Milan, Michigan



# **LOCATION MAP**



NOT TO SCALE

# **Sheet Index**

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C3.0	Layout, Paving, Grading, & Utilites Plan
C4.0	Site & Utility Details
C4.1	Site & Utility Details
L1.0	Landscape Plan
L1.1	Landscape Details

# **Engineer/Landscape Architect**

Beckett&Raeder

Landscape Architecture Planning & Engineering


Beckett & Raeder, Inc. 535 West William, Suite 101 Ann Arbor, MI 48103

734 **663.2622** ph 734 **663.6759** fx

# Owner

Tim Puffer 2710 Geert Court Lansing, MI 48910



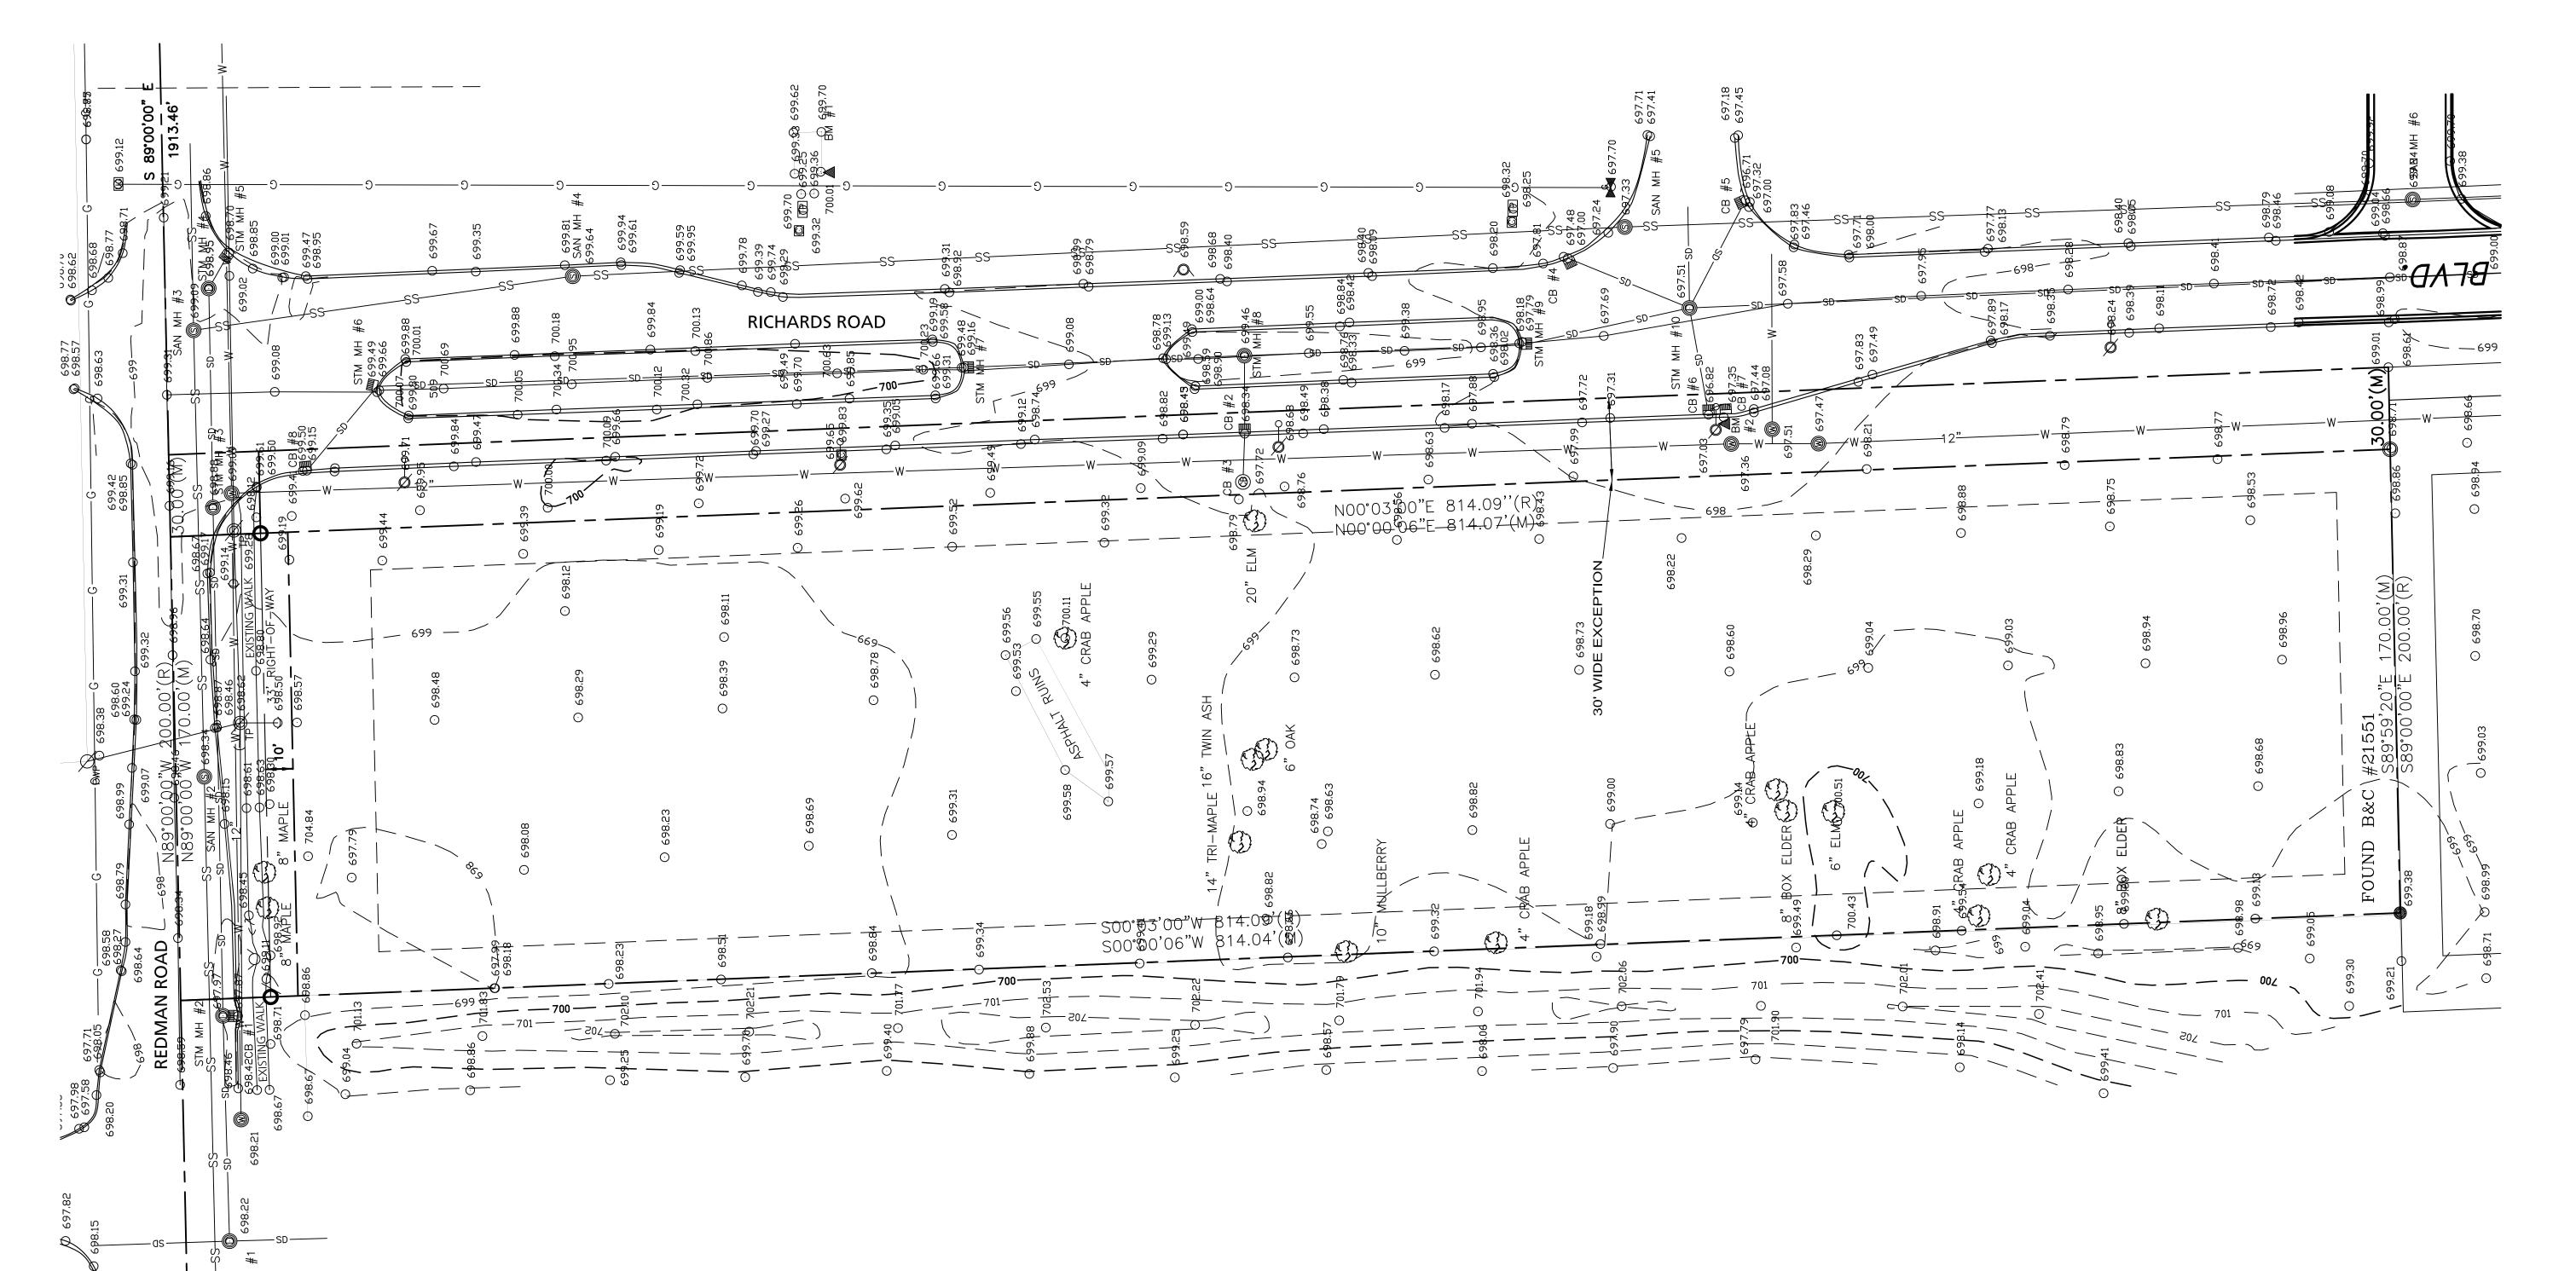

## EXISTING CONDITIONS LEGEND

	MONUMENT FOUND	G	GAS VALVE
	SET B&C #31588	UG	UNDERGROUND
AGL	ABOVE GROUND LEVEL	<u> </u>	GAS MARKER
F.P.	FOOTPRINT	G	GAS LINE
	DECIDUOUS TREE	PPT	PROPANE TANK
			FENCE
SS	—— SAN. SEWER LINE	SD	STORM DRAIN LINE
	SEWER MANHOLE	<b>©</b>	STORM DRAIN MANHOLI
PWP	POWERPOLE		
PWP \	GUY WIRE	СВ	CATCH BASIN
` .			CURB INLET
	STREET LIGHT POLE	TP	TELEPHONE PEDESTAL
E	BURIED ELECTRIC	$\aleph$	TELEPHONE POLE
O/HE	OVERHEAD ELECTRIC	TP T	0)/50/15 4 0 75/150/10/15
W	WATER LINE	O/HT	OVERHEAD TELEPHONE
<b>(W)</b>	WATER MANHOLE	O/HC	OVERHEAD CABLE
$\triangle$	HYDRANT		CABLE BOX
	PROPERTY LINE		

### **EXISTING CONDITIONS NOTES**

- 1. CONTRACTOR SHALL CALL MISS DIG (811) A MINIMUM OF THREE WORKING DAYS PRIOR TO START OF CONSTRUCTION.
- PRIOR TO START OF CONSTRUCTION
- 2. CONTRACTOR SHALL INVESTIGATE EXTENT AND LOCATION OF ALL EXISTING UTILITIES AND SHALL BE RESPONSIBLE FOR PROTECTION AND RESTORATION OF SAME IF DAMAGED AS A RESULT OF CONTRACTOR'S OPERATIONS.
- 3. CONTOUR INTERVAL SHOWN IS 1-FOOT.

### SURVEY PREPARED BY:

AUTENRIETH LAND SURVEYS, LLC PO BOX 80678 LANSING, MICHIGAN 48917 517-763-3062 jkautenrieth@comcast.net

#### FIELD SURVEY: JEFFREY K. AUTENRIETH PS#31588

THE NATURAL RESOURCE CONSERVATION SERVICE SOIL SURVEY INDICATES THE SITE IS COMPRISED OF MAINLY WASEPI SANDY LOAM WITH 0-3% SLOPES AND IS DESCRIBED AS SOMEWHAT POORLY DRAINED. ALSO ON THE SITE IS GILFORD SANDY LOAM WITH 0-2% SLOPES AND IS DESCRIBED AS VERY POORLY

#### BENCHMARK NOTES

SOIL TYPES

BENCHMARK #1- CHISLED "+" IN SOUTHWEST CORNER OF CONCRETE PAD TO AT&T PEDISTAL. ELEVATION 699.97 NGVD 88 DATUM.

BENCHMARK #2- CHISLED "+" IN EAST SIDE OF CONCRETE BASE STREET LIGHT POLE AT INTERSECTION OF RICHARDS AND SQUIRES ROADS. ELEVATION 697.60 NGVD 88 DATUM.

## STRUCTURE TABLE

SANITARY MANHOLE #1 STOR RIM 698.91 RIM 612" EAST-WEST 686.16 30" SANITARY MANHOLE #2

SANITARY MANHOLE #2 RIM 698.34 12" EAST 685.54 12" WEST 685.54

SANITARY MANHOLE #3 RIM 699.09 12" SOUTH 685.69 12" EAST-WEST 685.19

12" NORTH 686.79

SANITARY MANHOLE #4
RIM 699.64
12" NORTH-SOUTH 686.39

12" NORTH-SOUTH-EAST 687.93

SANITARY MANHOLE #6
RIM 699.24
12" NORTH-SOUTH 689.14

SANITARY MANHOLE #5

RIM 697.33

CATCHBASIN #7 FLOWLINE 696.82 12" NORTH 693.53 STORM MANHOLE #1 RIM 698.22 30" NORTH 690.12 30" SOUTH 690.32 8" EAST 693.22 SUMP 687.92

STORM MANHOLE #2 RIM 697.97 12" NORTH 695.12 8" WEST 693.87 10" EAST 694.17

RIM 698.95

12" SOUTH 695.67

STORM MANHOLE #3
RIM 698.88
10" EAST-WEST 698.38

STORM MANHOLE #4

10" WEST 693.25 12" SOUTHEAST 693.25 STORM MANHOLE/CATCHBASIN #5 FLOWLINE 698.70 30" NORTHEAST 690.90 30" SOUTHWEST 691.10

12" NORTHWEST 691.00

CATCHBASIN #8
FLOWLINE 699.15
12" SOUTHEAST 693.85

#### STORM MANHOLE #11 RIM 698.53 18" NORTH 694.33

STORM MANHOLE/CATCHBASIN #6

STORM MANHOLE/CATCHBASIN #7

STORM MANHOLE/CATCHBASIN #9

FLOWLINE 699.46

FLOWLINE 699.16

12 " WEST 691.36

FLOWLINE 697.76

30" NORTH 691.06

24" SOUTHEAST 691.06

STORM MANHOLE #10

24" NORTHWEST 691.51

12 " NORTHEAST 692.50

12" SOUTHEAST 692.50

18" SOUTH 691.51

12" WEST 692.50

24" EAST 691.61

RIM 699.46

RIM 697.51

30" SOUTH 690.46

30" NORTHEAST 690.46

12" NORTHWEST 693.00

30" NORTH-SOUTH 690.83

30" NORTH-SOUTH 691.26

STORM MANHOLE #8

CATCHBASIN #1 FLOWLINE 697.87 12" NORTH 695.77

CATCHBASIN #2 FLOWLINE 698.34 12" EAST 691.44 12" WEST 692.74

CATCHBASIN #3

FLOWLINE 697.38
12" EAST694.38

CATCHBASIN # 4
FLOWLINE 697.00
12" SOUTHWEST 692.90

CATCHBASIN #5
FLOWLINE 696.71
12" NORTHWEST 693.01

CATCHBASIN #6 FLOWLINE 696.82 12" EAST-SOUTH 693.42


### LEGAL DESCRIPTION

LEGAL DESCRIPTION AS RECORDED IN MONROE COUNTY DOCUMENT NUMBER 2018R10897

LAND SITUATED IN THE CITY OF MILAN, COUNTY OF MONROE, STATE OF MI DESCRIBED AS FOLLOWS:

COMMENCING AT THE WEST QUARTER CORNER OF SECTION 2, TOWN 5 SOUTH, RANGE 6 EAST, CITY OF MILAN, MONROE COUNTY, MICHIGAN; THENCE SOUTH 89 DEGREES 00 MINUTES EAST 516.40 FEET ALONG THE EAST AND WEST QUARTER LINE OF SAID SECTION AND THE CENTERLINE OF READMAN ROAD FOR A PLACE OF BEGINNING; THENCE SOUTH 00 DEGREES 00 MINUTES WEST 814.09 FEET PARALLEL WITH THE WEST LINE OF SAID SECTION; THENCE SOUTH 89 DEGREES 00 MINUTES EAST 200.00 FEET PARALLEL WITH THE NORTH LINE OF SAID SECTION; THENCE NORTH 00 DEGREES 03 MINUTES EAST 814.09 FEET PARALLEL WITH THE WEST LINE OF SAID SECTION AND THE CENTERLINE OF PLATT ROAD; THENCE NORTH 89 DEGREES 00 MINUTES WEST 200.00 FEET TO THE POINT OF BEGINNING, BEING PART OF THE SOUTHWEST QUARTER OF SAID SECTION AND LOT 164 OF ASSESOR'S PLAT OF THE CITY OF MILAN, AS RECORDED IN LIBER 7 OF PLATS, PAGE 48 MONROE COUNTY RECORDS, SUBJECT TO THE RIGHTS OF THE PUBLIC OVER THE NORTHERLY 33.0 FEET THEREOF AS OCCUPIED BY REDMAN ROAD.

EXCEPTING THAT PART OF THE SUBJECT PROPERTY DEEDED TO THE CITY OF MILAN BY QUIT CLAIM DEED RECORDED APRIL 6, 1994 IN LIBER 1373, PAGE 542, MONROE COUNTY RECORDS, AND FURTHER DESCRIBED AS FOLLOWS: A PARCEL OF LAND BEING PART OF LOT 164 ASSESSOR'S PLAT OF THE VILLAGE OF MILAN BEING PART OF SECTIONS 1 AND 2 TOWN 5 SOUTH, RANGE 6 EAST, CITY (FORMERLY VILLAGE) OF MILAN, MONROE COUNTY, MICHIGAN. AS RECORDED IN LIBER 7 OF PLATS, PAGE 48 THROUGH 51, FURTHER DESCRIBED AS FOLLOWS: COMMENCING AT THE WEST QUARTER CORNER OF SECTION 2, TOWN 5 SOUTH, RANGE 6 EAST; THENCE SOUTH 88 DEGREES 57 MINUTES EAST 686.97 FEET ALONG THE EAST AND WEST QUARTER LINE OF SECTION 2 AND THE CENTERLINE OF REDMAN ROAD (66 FEET WIDE); THENCE SOUTH 01 DEGREES 03 MINUTES, 00 SECONDS WEST 33.00 FEET TO THE POINT OF BEGINNING; THENCE SOUTH 00 DEGREES 03 MINUTES 00 SECONDS WEST 781.08 FEET PARALLEL TO THE WEST LINE OF SECTION 2; THENCE SOUTH 88 DEGREES 27 MINUTES 00 SECONDS EAST 30 FEET; THENCE NORTH 00 DEGREES 03 MINUTES 00 SECONDS EAST 781.09 FEET TO THE SOUTH RIGHT OF WAY LINE OF REDMAN ROAD; THENCE NORTH 88 DEGREES 57 MINUTES 00 SECONDS WEST 30.00 FEET BACK TO THE POINT OF BEGINNING.

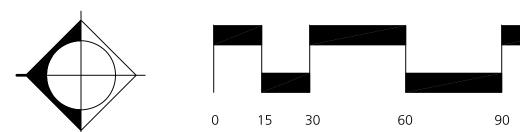

# Beckett&Raeder

Landscape Architecture Planning, Engineering & Environmental Services

Beckett & Raeder, Inc. 535 West William, Suite 101 Ann Arbor, MI 48103 734 **663.2622** ph

734 **663.6759** fx

Concultante

## Project Title

Milan Storage Development

Milan, Michigan

Sheet Title

Existing Conditions

Dates		
03.29.2019	Site Plan Review	
07.15.2019	Owner Review	

cale " = 20'

1" = 30'

Quality Control

Drawn: MS


Checked: KE

Project Number

Approved: KE

201909

Sheet Number

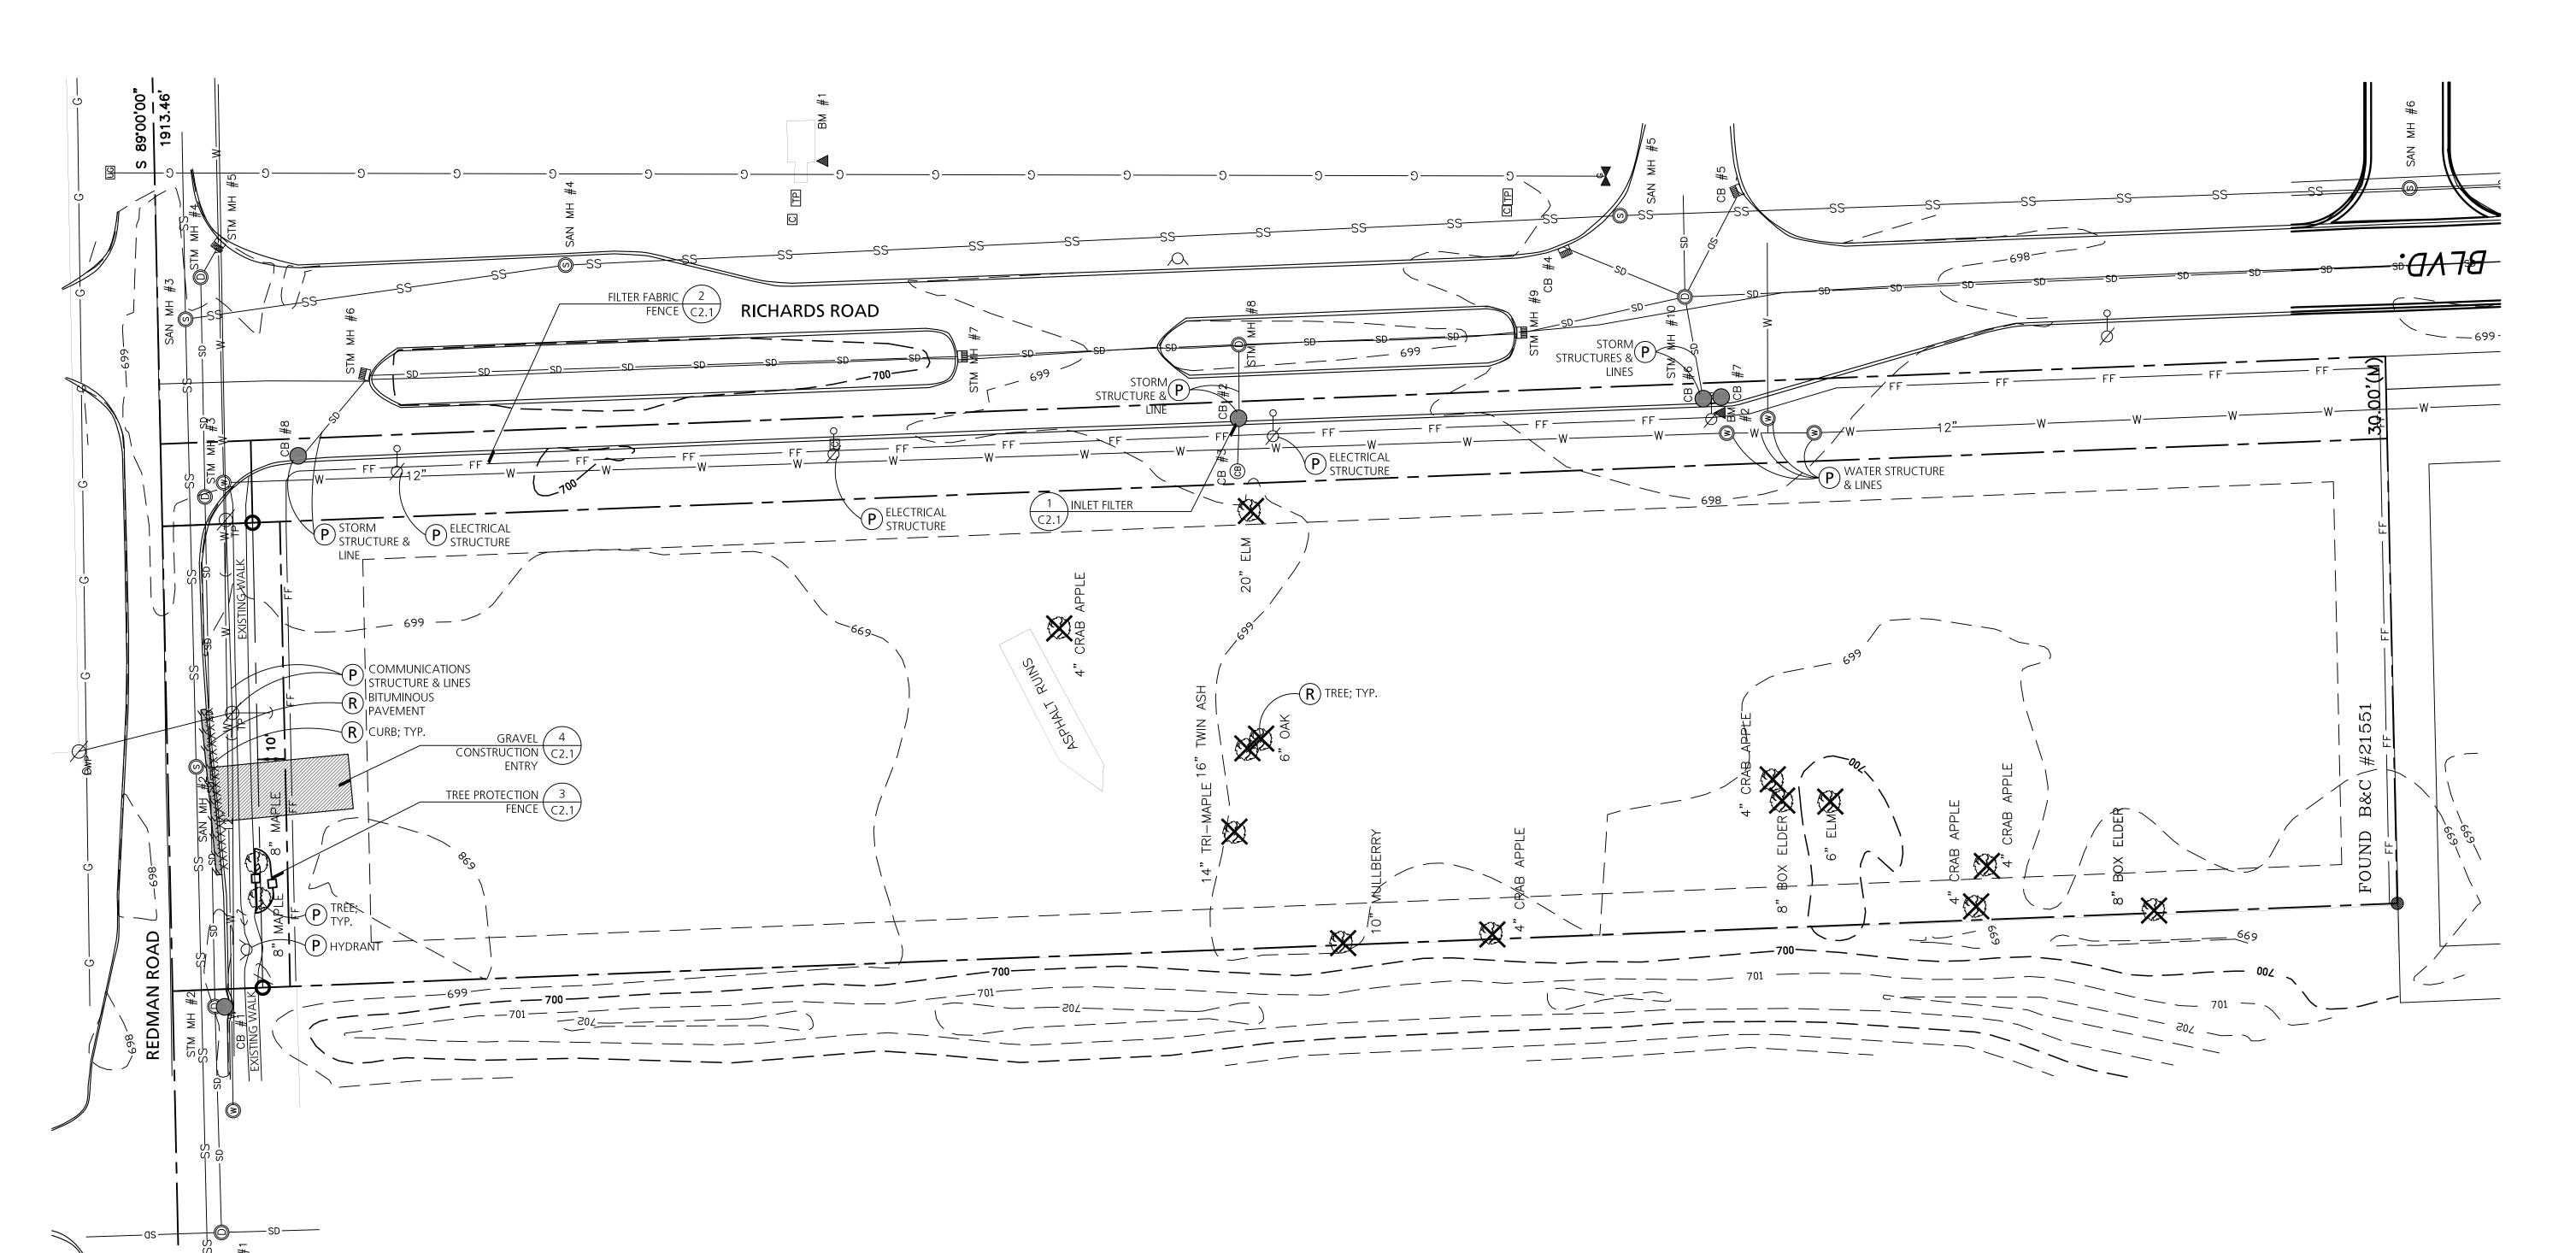

### DEMOLITION & SESC LEGEND

REMOVE EXISTING BITUMINOUS PAVING

GRAVEL CONSTRUCTION ENTRY

——— FF ——— FILTER FABRIC FENCE REMOVE ITEM

TREE PROTECTION FENCE

PROTECT ITEM

REMOVE EXISTING TREE

INLET FILTER

## **DEMOLITION NOTES**


- 1. CONTRACTOR SHALL CALL MISS DIG (811) A MINIMUM OF THREE WORKING DAYS PRIOR TO START OF CONSTRUCTION.
- 2. CONTRACTOR SHALL INVESTIGATE EXTENT AND LOCATION OF EXISTING UTILITIES AND SHALL BE RESPONSIBLE FOR PROTECTION AND RESTORATION OF SAME IF DAMAGED AS A RESULT OF CONTRACTOR'S OPERATIONS.
- 3. ALL ITEMS NOT INDICATED FOR REMOVAL SHALL REMAIN UNDISTURBED AND PROTECTED. CONTRACTOR SHALL FULLY RESTORE ANY ITEMS/MATERIALS DAMAGED DURING CONSTRUCTION AT NO ADDITIONAL COST TO THE OWNER.
- 4. ALL CONCRETE PAVEMENT AND CURB REMOVALS SHALL BE TO THE NEAREST JOINT BEYOND INDICATED EXTENT. 5. CONTRACTOR SHALL MAINTAIN CLEAN SAW CUT EDGES FOR PROPOSED WORK TO ABUT. BROKEN EDGES RESULTING FROM
- CONTRACTOR'S EXPENSE. 6. ALL REMOVALS SHALL BE SAW CUT FULL DEPTH AND COORDINATED WITH LAYOUT / GRADING PLANS. 7. REMOVALS SHALL INCLUDE SUBSOIL/EXISTING BASE MATERIALS TO FULL DEPTH REQUIRED FOR INSTALLATION OF NEW WORK

CONTRACTOR'S FAILURE TO PROTECT THE EDGE WILL BE SAW CUT BEYOND THE BREAKS AT THE NEAREST JOINT, AT THE

- INCLUDING BASE COURSE. ALL EXCAVATIONS SHALL PROVIDE ADEQUATE SOIL SUPPORT THROUGH THE USE OF ADEQUATE CUT SLOPES OR STRUCTURAL SHORING.
- 8. OWNER TO COORDINATE WITH RESPECTIVE UTILITY COMPANY FOR REMOVAL OF EXISTING TRANSFORMER, ELECTRICAL, CABLE, TELEPHONE AND FIBER OPTIC LINES.
- 9. CONTRACTOR SHALL REPAIR ALL DISTURBED TURF AREAS OUTSIDE OF PROJECT LIMITS DAMAGED DURING CONSTRUCTION. 10. ALL TOPSOIL AND ORGANIC MATERIAL SHALL BE REMOVED FROM UNDER PROPOSED BUILDING, FOOTINGS, SLABS, AND PAVED AREAS.
- 11. ALL SPOIL MATERIAL, INCLUDING TOPSOIL, TO BE REMOVED OFF SITE AND DISPOSED IN A LEGAL MANNER.
- 12. CONTRACTOR TO RELOCATE TREE PROTECTION FENCE WITH LANDSCAPE ARCHITECT/ENGINEER'S APPROVAL IN ORDER TO ACCOMPLISH WORK.
- 13. LAWN AND TOPSOIL REMOVALS AROUND EXISTING TREES TO BE PERFORMED WITH EXTREME CARE. REMOVALS TO BE COMPLETED BY HAND. NO HEAVY EQUIPMENT ALLOWED BENEATH TREE CANOPY.
- 14. DISCHARGE OF WATER, DUST, OR DEBRIS FROM CONCRETE AND ASPHALT WORK TO STORM OR SANITARY SYSTEMS IS PROHIBITED.
- 15. STORM DRAINS MUST BE PROTECTED FROM DUST AND DEBRIS.
- 16. ANY WATER USED DURING CONCRETE AND ASPHALT WORK (INCLUDING SWEEPING AND SAWCUTTING) MUST BE CONTAINED AND COLLECTED FOR PROPER DISPOSAL. SUGGESTED CONTROLS INCLUDE WET VACUUM OR ABSORBENTS.

### SESC NOTES

- 1. THIS PROJECT MUST BE CONSTRUCTED IN COMPLIANCE WITH PART 91 OF MICHIGAN NATURAL RESOURCES AND ENVIRONMENTAL PROTECTION ACT 451 OF 1994, AS AMENDED, THE SOIL EROSION AND SEDIMENT CONTROL ACT.
- 2. PRIOR TO ANY SITE DISTURBANCE, INCLUDING DEMOLITION, CONTRACTOR SHALL PLACE EROSION CONTROL MEASURES ON ALL EXISTING STORM SEWER STRUCTURES AFFECTED BY WORK IN THIS CONTRACT. SUCH EROSION CONTROL MEASURES SHALL BE MAINTAINED UNTIL PERMANENT MEASURES ARE IN PLACE.
- 3. CONTRACTOR SHALL PLACE TEMPORARY EROSION AND SEDIMENTATION CONTROL MEASURES AS REQUIRED AND AS SHOWN ON PLANS.
- 4. CONTRACTOR SHALL PROVIDE AND MAINTAIN ALL EROSION CONTROL MEASURES AS REQUIRED BY STATE AND LOCAL GOVERNING AUTHORITIES.
- 5. DAILY INSPECTIONS SHALL BE MADE BY THE CONTRACTOR TO DETERMINE THE EFFECTIVENESS OF EROSION AND SEDIMENT CONTROL MEASURES. ANY NECESSARY REPAIRS SHALL BE MADE
- 6. ALL EROSION AND SEDIMENT RESULTING FROM WORK ON SITE SHALL BE CONTAINED ON SITE AND NOT ALLOWED TO COLLECT IN ANY OFF-SITE AREAS OR WATERWAYS. WATERWAYS INCLUDE BOTH NATURAL AND MAN-MADE OPEN DITCHES, STREAMS, STORM DRAINS, RIVERS,
- 7. CONTRACTOR SHALL PLACE TEMPORARY EROSION AND SEDIMENTATION CONTROL MEASURES AS REQUIRED AND SHOWN ON PLANS.
- 8. CONTRACTOR SHALL PLACE INLET FILTER PROTECTION ON ALL STORM STRUCTURES AFFECTED BY THIS PROJECT.
- 9. ALL TEMPORARY SEDIMENT BASINS USED DURING CONSTRUCTION SHALL BE CLEANED AND ALL SEDIMENT LEGALLY DISPOSED OF PRIOR TO STABILIZATION. REMOVAL OF ALL FINES AND SEDIMENT IS CRITICAL IN AREAS WHERE INFILTRATION PRACTICES SHALL BECOME PERMANENT BEST MANAGEMENT PRACTICE.
- 10. CONTRACTOR SHALL CLEAN DEBRIS FROM STREETS ON A DAILY BASIS AS NEEDED.

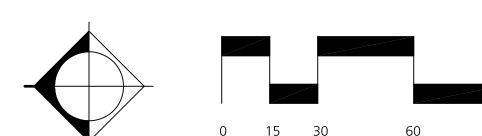

### B R (*i*) Beckett&Raeder

Landscape Architecture Planning, Engineering & Environmental Services

Beckett & Raeder, Inc. 535 West William, Suite 101 Ann Arbor, MI 48103 734 **663.2622** ph 734 **663 6759** fx

Project Title

Milan Storage Development

Milan, Michigan

Sheet Title

**Demolition & SESC Plan** 


Site Plan Review 03.29.2019 07.15.2019 Owner Review


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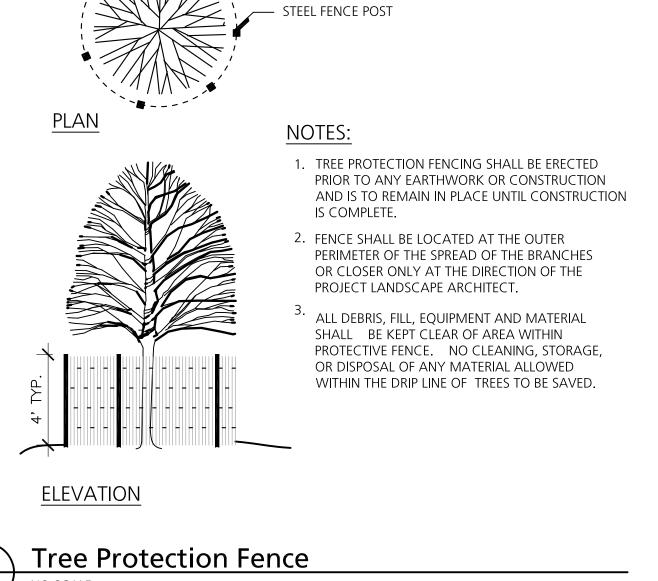
Quality Control Checked: KE

Approved: KE Project Number


201909



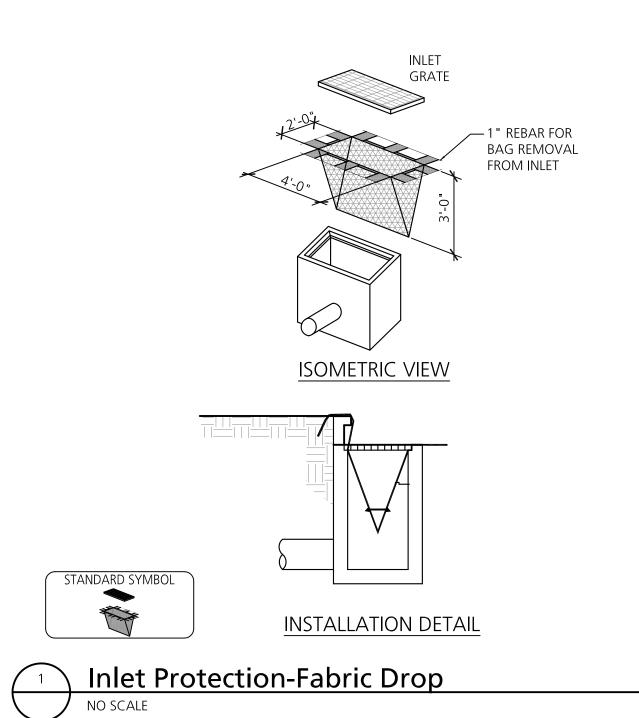

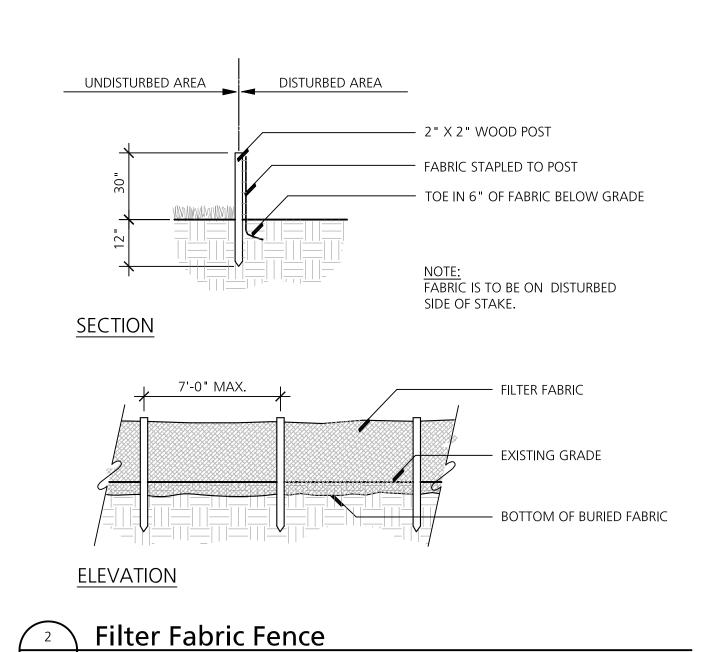

PLASTIC CONSTRUCTION FENCE

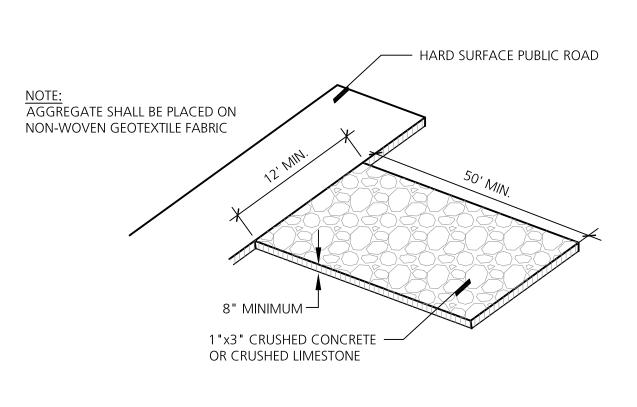

734 **663.2622** ph 734 **663.6759** fx Consultants

**Gravel Construction Entry** 

Seal

Project Title

Milan Storage Development

B R (*i*)

Beckett&Raeder

Landscape Architecture Planning, Engineering & Environmental Services

**Beckett & Raeder, Inc.** 535 West William, Suite 101 Ann Arbor, MI 48103

Milan, Michigan

SESC Details

03.29.2019 Site Plan Review Owner Review


As Shown

**Quality Control** 

Checked: KE Approved: KE

Project Number

C2.1

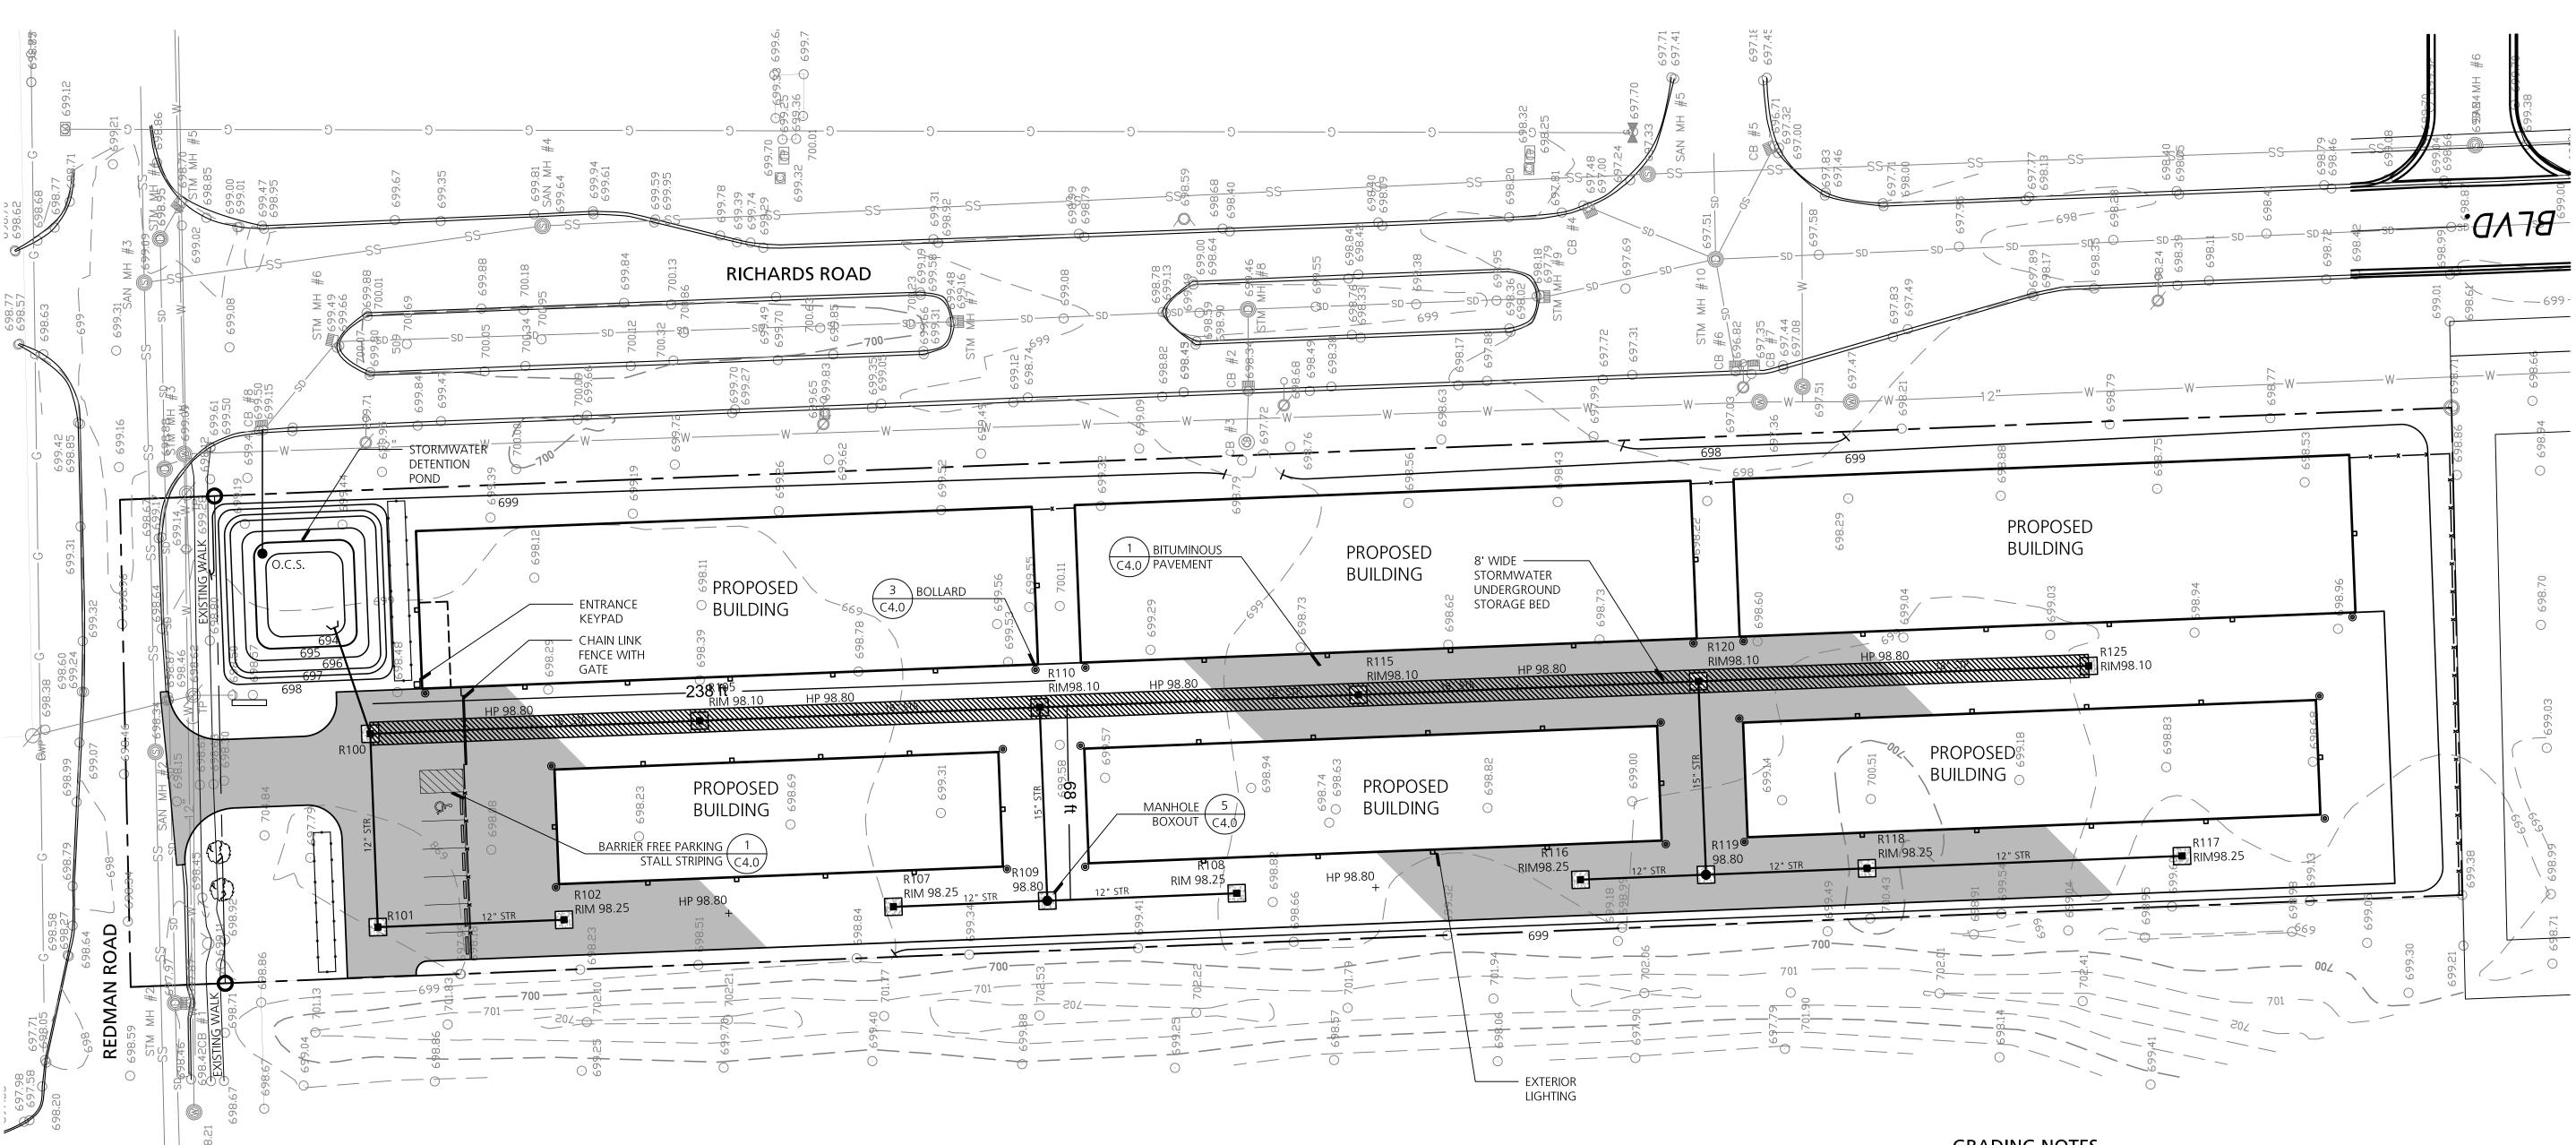

#### LAVOLIT CDADING & LITHITIES LEGEND

LAYOUT, GRADING	, & UTILITIES LEGEND		
SS	—— SAN. SEWER LINE	TP	TELEPHONE PEDESTAL
F	—— BURIED ELECTRIC	TP	TELEPHONE POLE
O/HE	OVERHEAD ELECTRIC	O/HT	OVERHEAD TELEPHONE
W	WATER LINE	O/HC	OVERHEAD CABLE
G	—— GAS LINE	G	GAS VALVE
SD	STORM DRAIN LINE	UG	UNDERGROUND GAS MARKER
	PROPERTY LINE	C [PPT]	CABLE BOX PROPANE TANK
	— RIGHT OF WAY	•	PROPOSED MANHOLE
	SEWER MANHOLE		PROPOSED CATCH BASIN
		$\cup$	PROPOSED END SECTION
PWP	POWERPOLE	STR	<ul> <li>PROPOSED STORM LINE</li> </ul>
(	GUY WIRE		
<b>\( \)</b>	STREET LIGHT POLE		BITUMINOUS PAVEMENT
	MONUMENT FOUND		
	SET B&C #31588		CONCRETE PAVEMENT
AGL	ABOVE GROUND LEVEL		
F.P.	FOOTPRINT	— — —700— — -	<ul> <li>EXISTING MAJOR CONTOUR</li> </ul>
	DECIDUOUS TREE	<i>− − − 7</i> 0 1 <i>− −</i>	<ul> <li>EXISTING MINOR CONTOUR</li> </ul>
		45	MAJOR CONTOUR (ADD 600)
W	WATER MANHOLE	44	
$\bigcirc$	HYDRANT	+ 41.20	<ul> <li>MINOR CONTOUR (ADD 600)</li> <li>SPOT ELEVATION (ADD 600)</li> </ul>
	STORM DRAIN MANHOLE	_	· ·
(CB)	CATCH BASIN	+ <sub>RIM</sub> 42.40	RIM ELEVATION (ADD 600)
	CURB INLET		PROPOSED LANDSCAPE EDGING

EXTERIOR LIGHTING

### STRUCTURE SCHEDULE

STRUCTURE SCHEDULE				
STRUCTURE ID	TYPE	RIM ELEV	INVERT ELEVATIONS	
FES	12"DIA	N/A	INV 12" W 694.00	
R100	48"DIA	697.50	INV 18" S 694.00 INV 12" W 694.10 INV 12" E 694.00	_
R101	48"DIA	697.64	INV 12" S 694.35 INV 12" E 694.25	
R102	24"DIA	698.25	INV 12" N 694.46	
R105	48"DIA	698.10	INV 18" S 694.00 INV 18" N 694.00	
R107	24"DIA	698.25	INV 12" S 694.41	
R108	24"DIA	698.25	INV 12" N 694.42	
R109	48"DIA	698.80	INV 12" S 694.31 INV 12" N 694.31 INV 12" E 694.21	
R110	48"DIA	698.10	INV 18" S 694.00 INV 12" W 694.10 INV 18" N 694.00	

R116 24"DIA 698.25 INV 12" S 694.45  R117 24"DIA 698.25 INV 12" N 694.80  R118 48"DIA 698.25 INV 12" S 694.60 INV 12" N 694.50  R119 48"DIA 698.80 INV 12" S 694.37 INV 12" N 694.37 INV 15" E 694.27  R120 48"DIA 698.10 INV 18" S 694.00 INV 18" N 694.00  R125 48"DIA 698.10 INV 18" N 694.00	IS	R115	48"DIA	698.10	INV 18" S 694.00 INV 18" N 694.00
R118 48"DIA 698.25 INV 12" S 694.60 INV 12" N 694.50  R119 48"DIA 698.80 INV 12" S 694.37 INV 12" N 694.37 INV 15" E 694.27  R120 48"DIA 698.10 INV 18" S 694.00 INV 18" N 694.00		R116	24"DIA	698.25	INV 12" S 694.45
R118		R117	24"DIA	698.25	INV 12" N 694.80
R119 48"DIA 698.80 INV 12" N 694.37 INV 15" E 694.27  R120 48"DIA 698.10 INV 18" S 694.00 INV 18" N 694.00		R118	48"DIA	698.25	
— R120 48"DIA 698.10 INV 18" N 694.00		R119	48"DIA	698.80	INV 12" N 694.37
R125 48"DIA 698.10 INV 18" N 694.00		R120	48"DIA	698.10	
		R125	48"DIA	698.10	INV 18" N 694.00

### LAYOUT & MATERIALS NOTES

- 1. ALL WORK SHALL BE COMPLETED IN CONFORMANCE WITH CURRENT ADA STANDARDS.
- 2. ALL DIMENSIONS ARE TO BACK OF CURB, FACE OF BUILDING OR EDGE OF
- MATERIAL UNLESS OTHERWISE NOTED.
- LINE FROM WHICH THEY ARE DIMENSIONED UNLESS OTHERWISE NOTED.

3. ALL LINES ARE PARALLEL OR PERPENDICULAR TO THE CURB/ PAVEMENT/ BUILDING

- 4. FOLLOWING LAYOUT OF ALL MATERIALS, CONTRACTOR SHALL REVIEW WITH OWNER'S REPRESENTATIVE.
- 5. ANY DISCREPANCIES IN THE LAYOUT PLAN SHOULD BE IMMEDIATELY REPORTED TO OWNER'S REPRESENTATIVE.

## **GRADING NOTES**

- 1. CONTRACTOR IS RESPONSIBLE FOR CONSTRUCTION ALL WORK COMPLETED IN
- CONFORMANCE WITH CURRENT ADA STANDARDS. 2. PROPOSED CONTOUR LINES AND SPOT ELEVATIONS REFLECT FINISH GRADES. HOLD DOWN SUBGRADE ELEVATIONS ACCORDINGLY. ADJUST RIM ELEVATIONS OF ALL UTILITIES AFFECTED BY WORK IN THIS CONTRACT. CONTRACTOR SHALL ENSURE POSITIVE DRAINAGE ON THE SITE. ANY AREA THAT APPEARS TO NOT

PROPERLY DRAIN SHALL BE BROUGHT TO THE IMMEDIATE ATTENTION OF THE

## **UTILITIES NOTES**

1. ALL UTILITIES SHOWN FOR CONCEPTUAL DESIGN DEVELOPMENT ONLY. FINAL ROUTING, SIZING AND CONNECTIONS WILL VARY.

LANDSCAPE ARCHITECT/ ENGINEER FOR RESOLUTION.

- 2. PROPOSED CONTOUR LINES AND SPOT ELEVATIONS REFLECT FINISH GRADES. HOLD DOWN SUBGRADE ELEVATIONS ACCORDINGLY. ADJUST RIM ELEVATIONS OF ALL UTILITIES AFFECTED BY WORK IN THIS CONTRACT. CONTRACTOR SHALL ENSURE POSITIVE DRAINAGE ON THE SITE. ANY AREA THAT APPEARS TO NOT PROPERLY DRAIN SHALL BE BROUGHT TO THE IMMEDIATE ATTENTION OF THE LANDSCAPE ARCHITECT/ ENGINEER FOR RESOLUTION.
- 3. CONTRACTOR SHALL VERIFY ALL EXISTING UTILITY LOCATIONS, DEPTHS AND ELEVATIONS PRIOR TO CONSTRUCTION. NO CHANGES IN CONTRACT PRICE WILL BE AWARDED FOR ACTUAL DISCREPANCIES IN UTILITY LOCATIONS DUE TO THE FAILURE TO VERIFY ACTUAL FIELD LOCATIONS.
- 4. THE CONTRACTOR SHALL RESTORE ALL AREAS DISTURBED BY HIS CONSTRUCTION OPERATIONS TO A CONDITION EQUAL TO OR BETTER THAN THAT EXISTING PRIOR TO CONSTRUCTION. THE CONTRACTOR SHALL CLEAN UP AND HAUL AWAY ALL CONSTRUCTION DEBRIS AND LITTER CAUSED BY HIS OPERATIONS.
- 5. CONTRACTOR SHALL PROTECT ALL EXISTING UTILITIES FROM DAMAGE DURING CONSTRUCTION. ANY DAMAGE INCURRED SHALL BE REPAIRED AT THE CONTRACTOR'S EXPENSE.
- 6. ALL UTILITY CROSSINGS SHALL HAVE A MINIMUM OF 18" VERTICAL CLEARANCE.
- 7. SEE ARCHITECTURAL AND MECHANICAL SHEETS FOR CONTINUATION OF UTILITIES WITHIN STRUCTURES.





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Consultants

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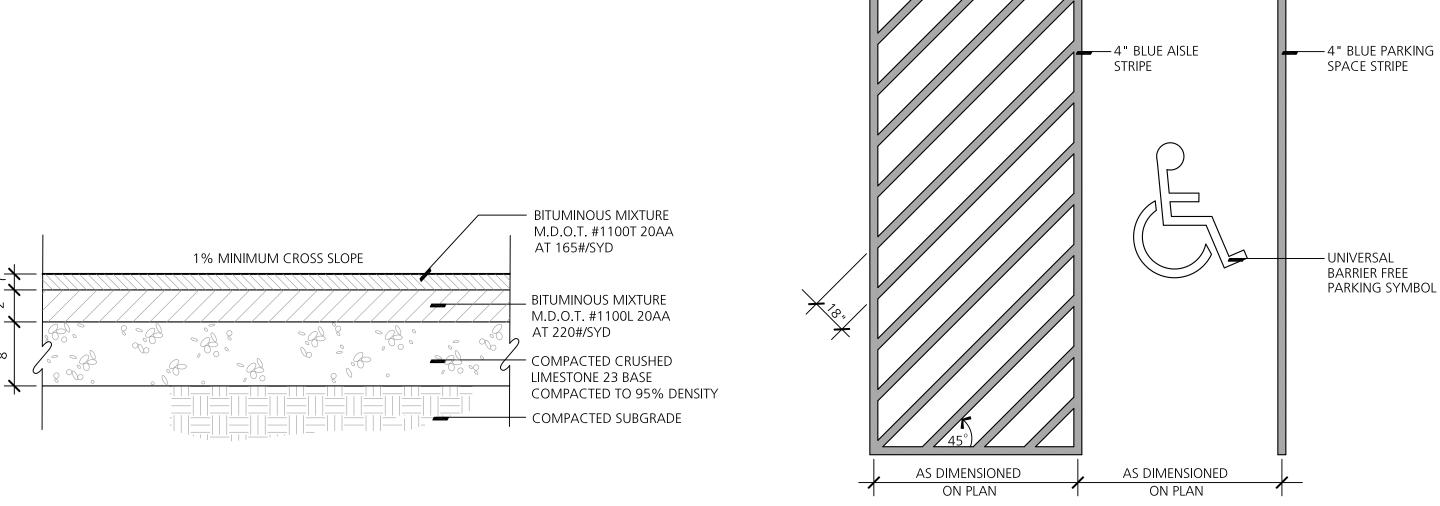
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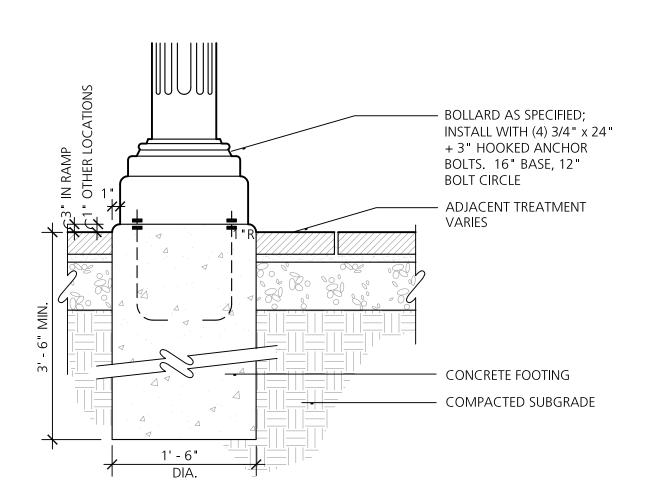
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C3.0





Consultants

Project Title

Milan

Milan, Michigan

Sheet Title

Site & Utility Details

Storage Development

Beckett&Raeder

Landscape Architecture Planning, Engineering & Environmental Services

Beckett & Raeder, Inc.

Ann Arbor, MI 48103

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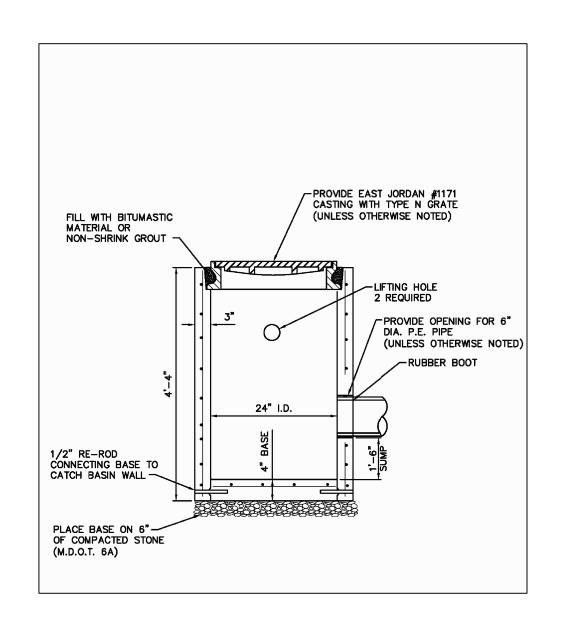
Bituminous Pavement


Barrier Free Parking Stall Striping
NO SCALE


— 4" YELLOW OR WHITE DIVIDER


STRIPE, AS SPEC'D

Bollard Installation
NO SCALE



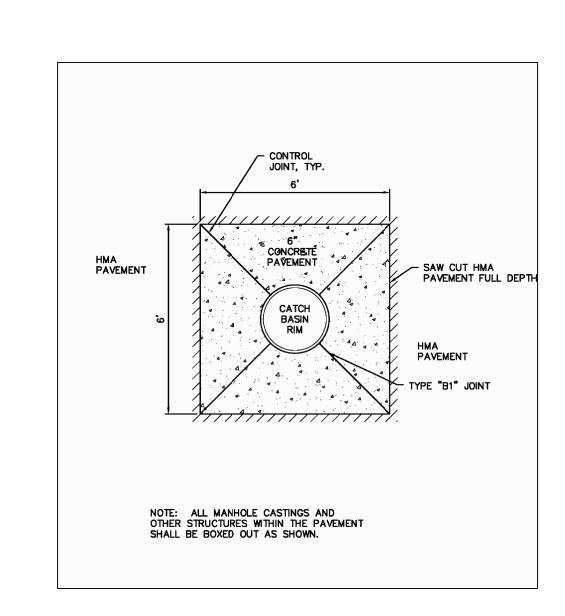

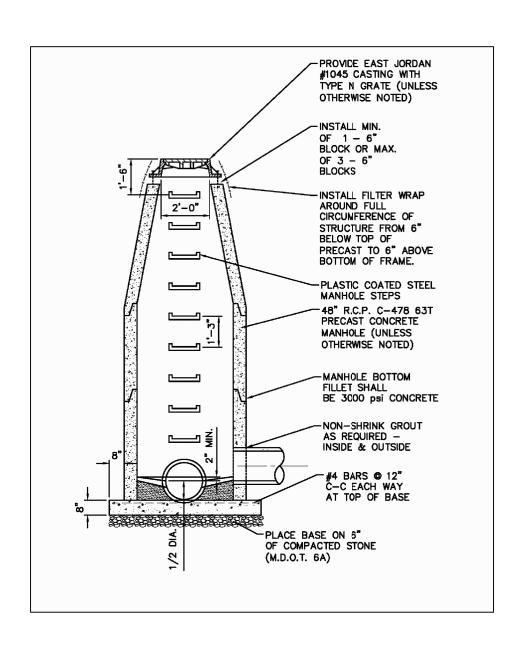

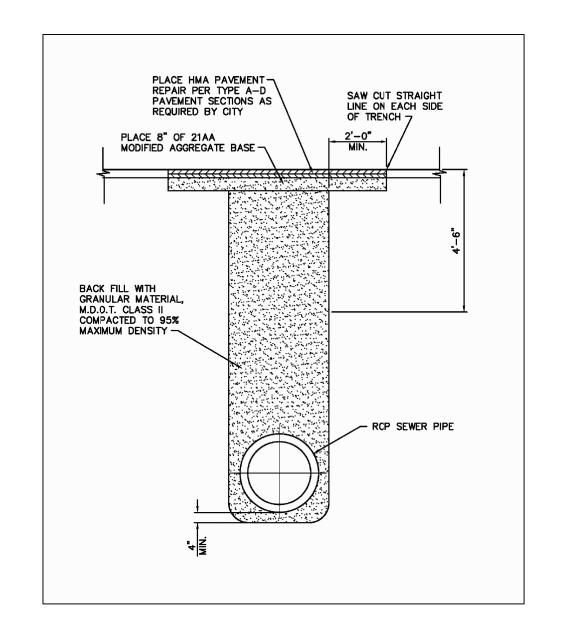


2' Diameter Catch Basin - City of Milan
NO SCALE


Manhole Boxout Detail - City of Milan
NO SCALE


Storm Sewer Manhole - City of Milan
NO SCALE

Open Cut Trench Detail - City of Milan
NO SCALE

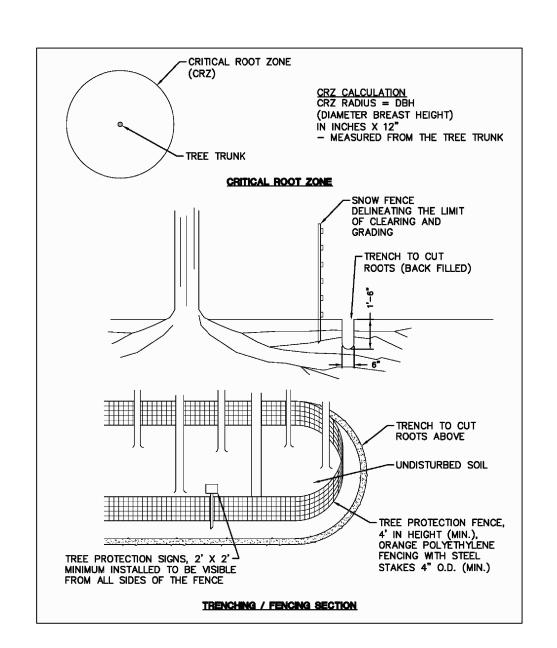

Tree Protection of Criical Root Zone - City of Milan

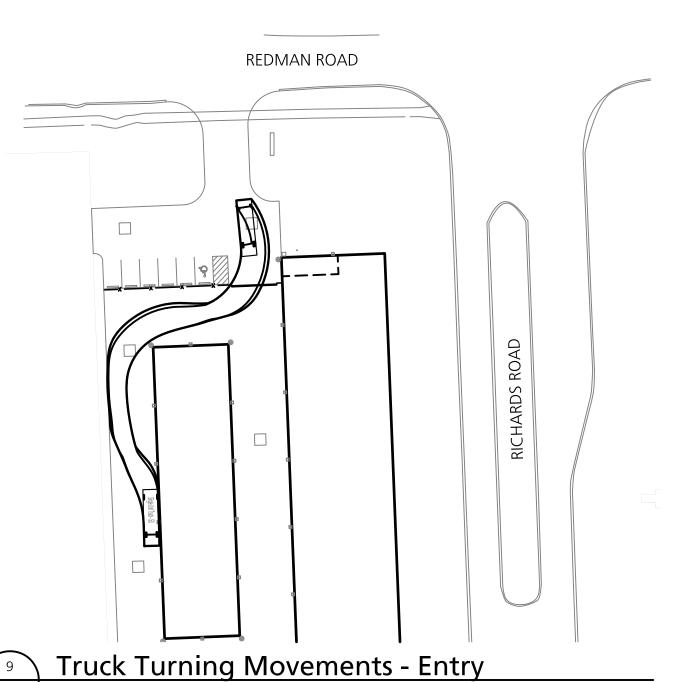

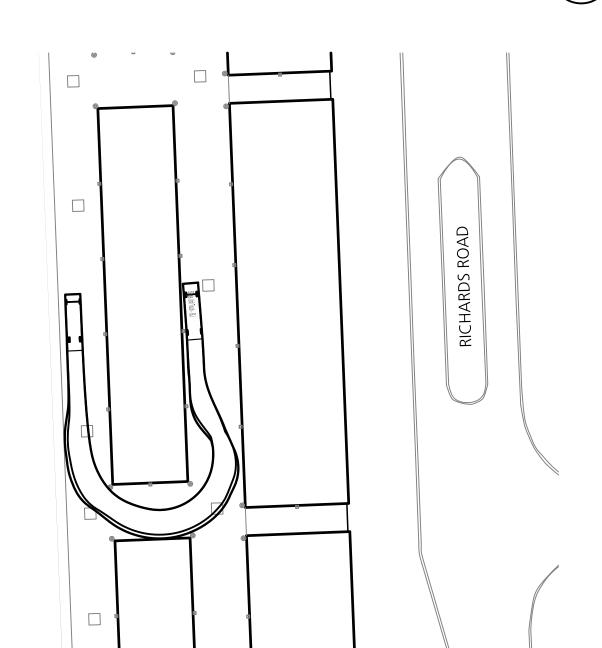

Truck Turning Movements - Aisle

03.29.2019 Site Plan Review
07.15.2019 Owner Review

Scale As Shown

Ouality Control

Drawn: MS


Checked: KE

Approved: KE

Project Number 201909

Sheet Number

C4.0

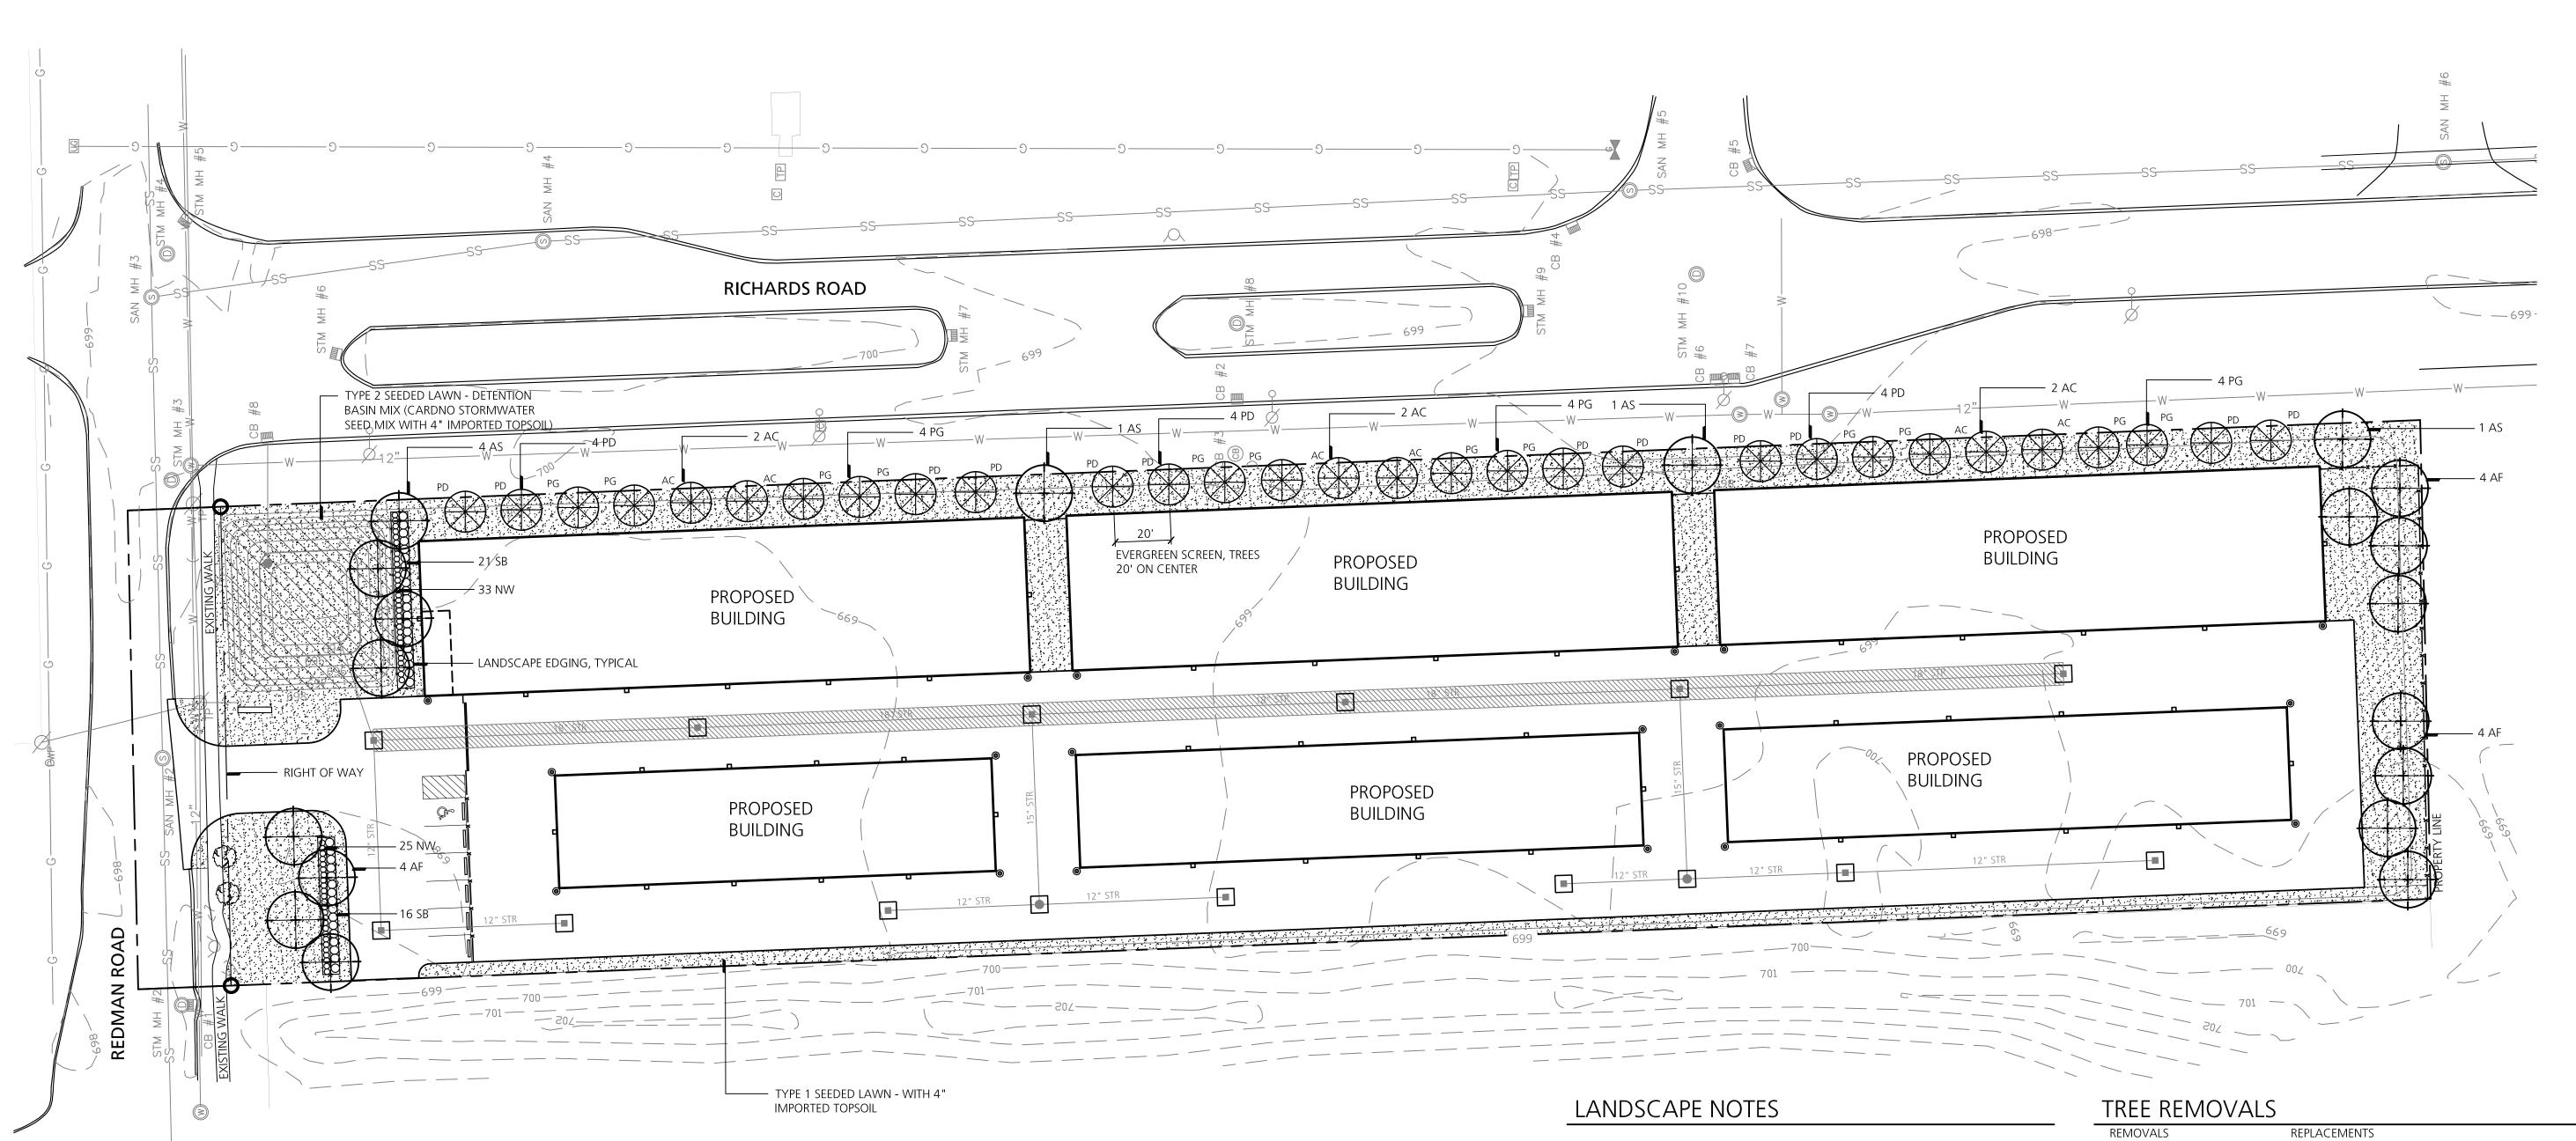


#### LANDSCAPE LEGEND

TYPE 2 SEEDED LAWN (DETENTION)

TYPE 1 SEEDED LAWN WITH 4" IMPORTED TOPSOIL



EXISTING TREE TO REMAIN PROTECTED

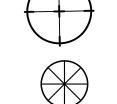

PROPOSED EVERGREEN TREE

PROPOSED CANOPY TREE



PROPOSED SHRUBS & PERENNIALS

PROPOSED LANDSCAPE EDGING PROPERTY LINE

## PLANT SCHEDULE

TREE:	S				
QTY.	SYM.	BOTANICAL NAME	COMMON NAME	SIZE	COMMENTS
6	AC	ABIES CONCOLOR	WHITE FIR	6 -7'HEIGHT	FULL TO THE GROUND, UNSHEARED, SINGLE STRAIGHT TRUNK
12	AF	*ACER X FREEMAN 'JEFFERSRED'	AUTUMN BLAZE MAPLE	2.0" CALIPER	FULL UNIFORM HEAD AND BRANCHING, SINGLE STRAIGHT TRUNK
7	AS	*ACER SACCHARUM 'GREEN MOUNTAIN'	GREEN MOUNTAIN SUGAR MAPLE	2.0" CALIPER	FULL UNIFORM HEAD AND BRANCHING, SINGLE STRAIGHT TRUNK
12	PD	PICEA GLAUCA VAR. DENSATA	BLACK HILLS SPRUCE	6 - 7' HEIGHT	FULL TO THE GROUND, UNSHEARED, SINGLE STRAIGHT TRUNK
12	PG	PICEA GLAUCA	WHITE SPRUCE	6 - 7' HEIGHT	FULL TO THE GROUND, UNSHEARED, SINGLE STRAIGHT TRUNK
NOTE: * INDICATES REPLACEMENT TREE, 19 TREES REQUIRED.					
SHRU	BS AND	PERENNIALS			
37	SB	SPIREA X B. 'ANTHONY WATERER'	ANTHONY WATERER SPIREA	3 GAL. CONT.	FULL HEAVY PLANT, PLANT 3' O.C.
58	NW	NEPETA X F. 'WALKERS LOW'	WALKER'S LOW CATMINT	2 GAL. CONT.	FULL HEAVY PLANT, PLANT 24" O.C.

- CONTRACTOR SHALL VERIFY ALL RIGHTS OF WAY, EASEMENTS, PROPERTY LINES AND LIMITS OF WORK, ETC. PRIOR TO COMMENCING WORK.
- PRIOR TO ANY CONSTRUCTION, THE CONTRACTOR SHALL TELEPHONE MISS DIG (1-800-482-7171) 72 HOURS IN ADVANCE OF ANY WORK, FOR THE LOCATION OF UNDERGROUND FACILITIES, AND SHALL ALSO NOTIFY REPRESENTATIVES OF ANY OTHER FACILITIES LOCATED IN THE VICINITY OF THE WORK, WHICH MAY NOT BE HANDLED BY MISS DIG.
- CONTRACTOR SHALL NOT WILLFULLY PROCEED WITH CONSTRUCTION AS DESIGNED WHEN IT IS OBVIOUS THAT UNKNOWN OBSTRUCTIONS AND/OR GRADE DIFFERENCES EXIST. SUCH CONDITIONS SHALL BE IMMEDIATELY BROUGHT TO THE ATTENTION OF THE OWNER'S REPRESENTATIVE AND/OR LANDSCAPE ARCHITECT. THE CONTRACTOR SHALL ASSUME FULL RESPONSIBILITY FOR ALL NECESSARY REVISIONS DUE TO FAILURE TO GIVE SUCH NOTIFICATION.
- CONTRACTOR SHALL BE RESPONSIBLE FOR ANY EXISTING MATERIALS THAT ARE DAMAGED DURING CONSTRUCTION.
- CONTRACTOR SHALL PROVIDE AND MAINTAIN POSITIVE SURFACE DRAINAGE AWAY FROM BUILDING.
- 6. ALL TREES TO HAVE CLAY LOAM OR CLAY BALLS TREES WITH SAND BALLS SHALL NOT BE ACCEPTED.
- 7. ALL TREES TO BE APPROVED BY OWNER'S REPRESENTATIVE AND/OR LANDSCAPE ARCHITECT PRIOR TO DELIVERY TO THE SITE. ANY TREES DELIVERED TO THE SITE NOT PREVIOUSLY APPROVED MAY BE REJECTED AND ARE THE SOLE RESPONSIBILITY OF THE CONTRACTOR.
- FINAL LOCATION OF ALL PLANT MATERIAL SHALL BE SUBJECT TO THE APPROVAL OF THE LANDSCAPE ARCHITECT.
- CONTRACTOR TO VERIFY PERCOLATION OF ALL PLANTING PITS AND BEDS PRIOR TO INSTALLATION OF PLANT MATERIAL, ADVISE AND COORDINATE METHOD OF PLANTING WITH LANDSCAPE ARCHITECT BASED ON PERCOLATION RATES.
- SEE SPECIFICATIONS FOR MATERIALS AND EXECUTION.
- CONTRACTOR SHALL REMOVE TREE WRAP AFTER COMPLETE INSTALLATION AND APPROVAL OF TREE AND PLANTING.
- 12. PRUNE MATERIAL ONLY AS DIRECTED BY LANDSCAPE ARCHITECT.
- CONTRACTOR SHALL STRAIGHTEN & STAKE TREES WITHIN 3 DAYS OF INSTALLATION.
- CONTRACTOR SHALL FIELD STAKE ALL TREE AND BED LOCATIONS FOR LANDSCAPE ARCHITECTS APPROVAL PRIOR TO BED EXCAVATION.
- LANDSCAPE ARCHITECT SHALL REVIEW ALL EXCAVATED TREE PITS AND SHRUBS, GROUNDCOVER, PERENNIAL BEDS PRIOR TO INSTALLATION OF SPECIFIED PLANTING SOIL MIX.
- PLANTING SOIL MIXTURE SHALL BE TO DIMENSIONS ILLUSTRATED ON DETAIL. PLANTING SOIL MIX SHALL BE ENCOMPASS ENTIRE PLANTING BED AREA, NO POCKET PLANTING UNLESS NOTED OTHERWISE (INDIVIDUAL PLANTS).

1 - 4" CRABAPPLE	1 - 2" CANOPY TREE
1 - 16" TWIN ASH	3 - 2" CANOPY TREES
1 - 6" OAK	1 - 2" CANOPY TREE
1 - 14" TRI-MAPLE	3 - 2" CANOPY TREES
1 - 10" MULBERRY	2 - 2" CANOPY TREES
1 - 4" CRABAPPLE	1 - 2" CANOPY TREE
1 - 4" CRABAPPLE	1 - 2" CANOPY TREE
1 - 8" BOX ELDER	2 - 2" CANOPY TREES
1 - 6" ELM	1 - 2" CANOPY TREE
1 - 4" CRABAPPLE	1 - 2" CANOPY TREE
1 - 4" CRABAPPLE	1 - 2" CANOPY TREE
1 - 8" BOX ELDER	2 - 2" CANOPY TREES
1 - 20" ELM	4 - 2" CANOPY TREESC

TOTAL REPLACEMENT TREES: 19 - 2" CANOPY TREES TOTAL REPLACEMENT TREES PROVIDED: 19 -2" CANOPY TREES

#### REPLACEMENT CRITERIA:

ALL TREES 6" CALIPER AND LESS = ONE 2-3" CANOPY TREE ALL TREES OVER 6" CALIPER = ONE 2-3" CANOPY TREE FOR EVERY 6" OF CALIPER


NOTE: CONFIRM TREES EXEMPT FROM REPLACEMENT ORDINANCE.

### SITE / LANDSCAPE DATA

SITE AREA: 3.05 ACRES (132,836.66 SF MINIMUM REQUIRED SITE LANDSCAPE (20% OF SITE AREA): 26,566.33 SF PROPOSED SITE LANDSCAPING: 28,496.98 SF

#### 1. FOR TREE REPLACEMENT CALCULATIONS SEE THIS SHEET.

2. FOR LANDSCAPE DETAILS SEE SHEET L1.1. 3. FOR CITY LANDSCAPE SPECIFICATIONS SEE SHEET L1.1.

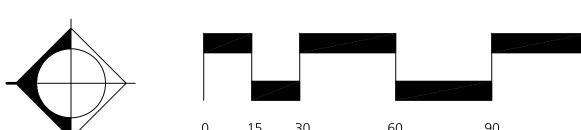

# Beckett&Raeder

Landscape Architecture Planning, Engineering & Environmental Services

Beckett & Raeder, Inc. 535 West William, Suite 101 Ann Arbor, MI 48103 734 **663.2622** ph

734 **663 6759** fx

Milan

Storage Development

Milan, Michigan

Sheet Title

Landscape Plan

03.29.2019 Site Plan Review 07.15.2019 Owner Review


1" = 30'

**Quality Control** 


Checked: KE Approved: KE

Project Number


201909 Sheet Number

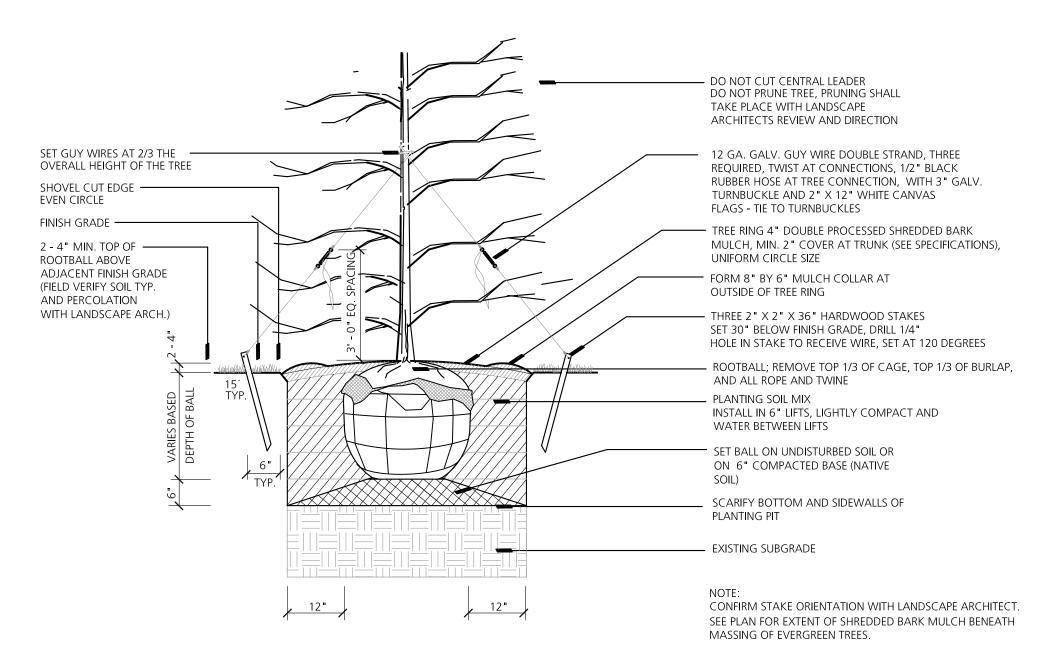


**Evergreen Tree Planting Detail** 

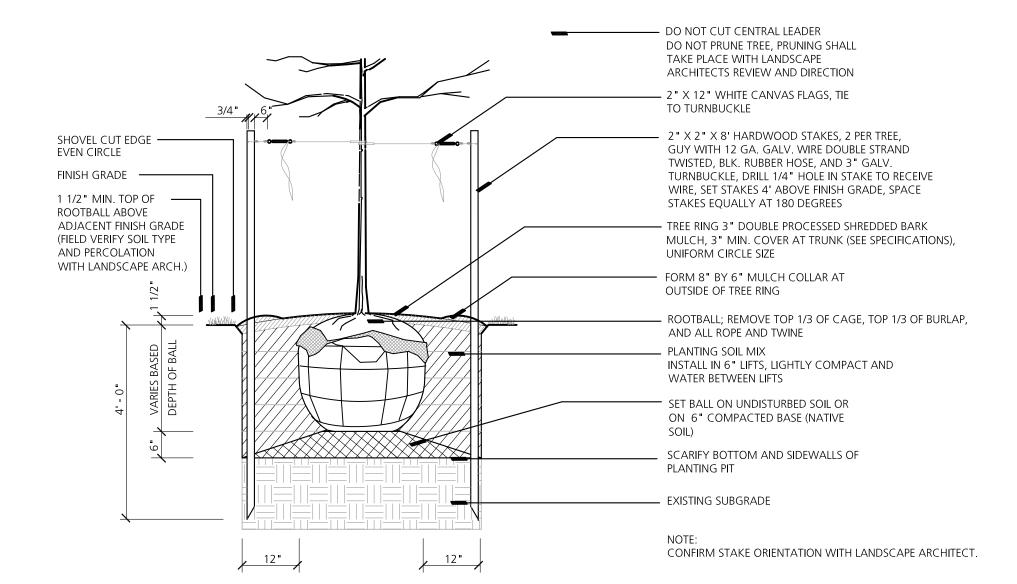

Deciduous Tree Planting Detail - Staked (2 1/2" Caliper Or Less)

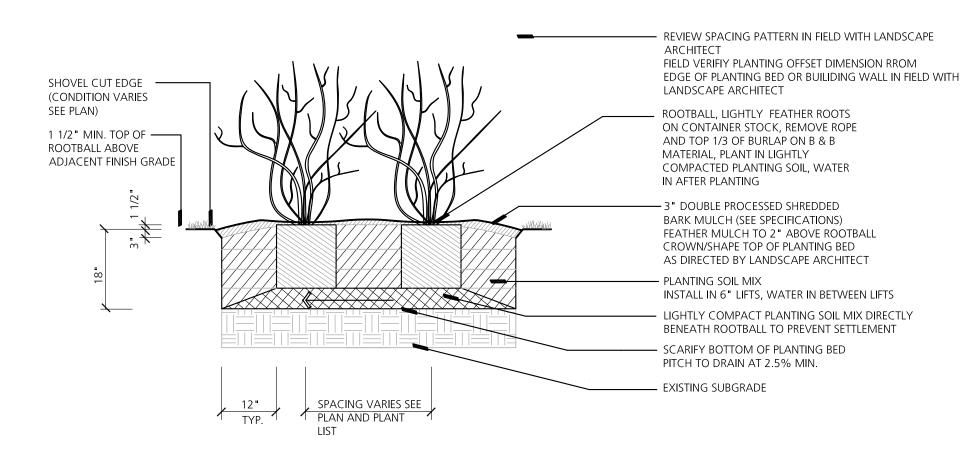

Shrub Planting Detail

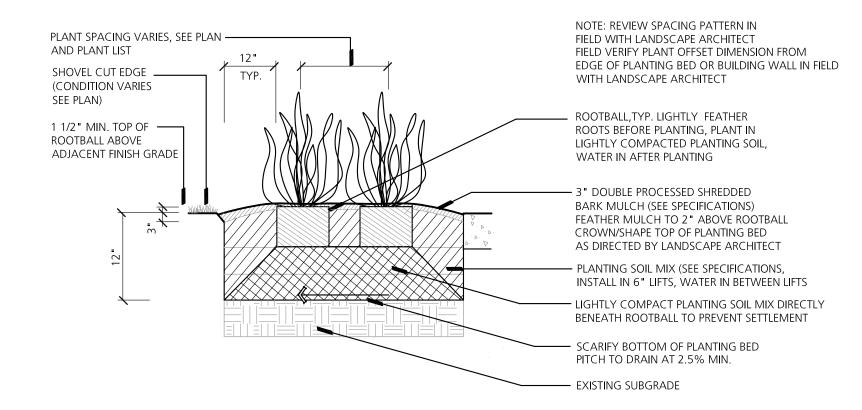

\ Perennial Planting Detail

### LANDSCAPE SPECIFICATIONS

EXCEPTIONS TO THE FOLLOWING SPECIFICATIONS WILL BE CONSIDERED, IF ACCEPTABLE ALTERNATES ARE DISCUSSED WITH THE CITY OF MILAN PRIOR TO LANDSCAPE INSTALLATION. ADDITIONAL SPECIFICATIONS ARE TO BE ADDED BY THE LANDSCAPE ARCHITECT AS NEEDED.

- 1. PRIOR TO ANY LAND CLEARING OR CONSTRUCTION, TREE PROTECTION FENCING IS TO BE INSTALLED BY THE CONTRACTOR AND INSPECTED BY THE CITY, SEE APPENDIX D FOR DRAWING. THIS FENCING SHALL BE INSTALLED AT THE DRIP LINE OF ALL TREES AND SHRUBS, IN ACCORDANCE WITH THE CITY'S TREE PROTECTION DETAIL, AND MUST BE MAINTAINED AS APPROVED FOR THE DURATION OF THE PROJECT. NO CUTTING, FILLING OR TRESPASSING SHALL OCCUR INSIDE THE FENCED AREAS WITHOUT PRIOR APPROVAL FROM THE CITY.
- 2. TREES TO BE TRANSPLANTED ON THE SITE SHALL BE SO MARKED IN THE FIELD BY THE CONTRACTOR, APPROVED BY THE CITY OF MILAN AND TRANSPLANTED USING ONLY THE APPROPRIATE SIZE TREE SPADE, PER THE AMERICAN ASSOCIATION OF NURSERYMEN AND CITY OF MILAN STANDARDS. TRANSPLANTS ARE TO BE WATERED IMMEDIATELY FOLLOWING PLANTING.
- 3. TREES SHOWN ON THE PLAN TO SAVE OR TRANSPLANT THAT ARE REMOVED OR DAMAGED SHALL BE REPLACED WITH ONE (1) 2"-3" CALIPER TREE FOR EACH TREE REMOVED UNDER 6" DIAMETER. TREES OVER 6" DIAMETER SHALL BE REPLACED WITH ONE (1) 2"-3" CALIPER TREE FOR EACH 6" IN DIAMETER REMOVED, TYPE OF REPLACEMENT AND LOCATION SHALL BE DETERMINED BY THE PROJECT LANDSCAPE ARCHITECT OR THE CITY OF MILAN.
- 4. PLANT TREES AND SHRUBS NO CLOSER THAN THE FOLLOWING MINIMUM DISTANCES FROM SIDEWALKS, CURBS AND PARKING STALLS:
- A. SHADE/CANOPY TREES, 5 FEET; B. ORNAMENTAL/FLOWERING TREES, 10 FEET; C. EVERGREEN TREES, 10 FEET;
- D. EVERGREEN/FLOWERING SHRUBS, 4 FEET
- 5. DIG SHRUB PITS A MINIMUM OF 1' LARGER THAN SHRUB ROOT BALLS AND TREE PITS 2' LARGER THAN ROOT BALLS. BACKFILL WITH ONE PART TOP SOIL AND ONE PART SOIL FROM THE EXCAVATED PLANTING HOLE. PLANT TREES AND SHRUBS AT THE SAME GRADE LEVEL AT WHICH THEY WERE PLANTED AT THE NURSERY. IF CLAY SOILS ARE EVIDENT, AND WATER IS STANDING, PLANT TREES AND SHRUBS HIGHER.
- 6. REMOVE ALL TWINE, WIRE AND BURLAP FROM THE TOP 1/3 OF TREE AND SHRUB EARTH BALLS AND FROM TREE TRUNKS. REMOVE ALL NON-BIODEGRADABLE MATERIAL SUCH AS PLASTIC OR NYLON COMPLETELY.
- 7. LAWN TREES ARE TO BE MULCHED WITH A MINIMUM OF 6' WIDE BY 3" DEEP SHREDDED BARK RINGS OR APPROVED DESIGN FOR TRUNK PROTECTION. ONLY NATURAL-COLORED SHREDDED HARDWOOD BARK MULCH WILL BE ACCEPTED.
- 8. SHRUB BEDS ARE TO BE MULCHED WITH SHREDDED BARK MULCH TO A MINIMUM DEPTH OF 3". ONLY NATURALCOLORED SHREDDED HARDWOOD BARK MULCH WILL BE ACCEPTED.
- 9. SOD IS TO BE PROVIDED FOR ALL EXISTING LAWN AREAS THAT THE OWNER INTENDS TO SAVE AND AREAS THAT ARE DAMAGED DURING CONSTRUCTION. THE SOD MUST BE INSPECTED BY THE CITY TO DETERMINE VIABILITY. IF THE EXISTING LAWN IS FOUND TO BE LEVEL, HEALTHY, DENSE AND FREE FROM WEEDS, LAWN MAY NOT REQUIRE REPLACEMENT OR RENOVATION. IF RENOVATION IS REQUIRED OR IS PART OF THE APPROVED PLAN, THEN THE FOLLOWING REQUIREMENTS WILL APPLY:
  - A. EXISTING LAWN FOUND TO BE IN POOR CONDITION MUST FIRST BE SPRAYED WITH ROUND-UP (OR EQUAL) TO KILL THE EXISTING LAWN AND WEED AREAS. WAIT FOR A MINIMUM PERIOD OF SEVEN (7) DAYS FOR THE HERBICIDE TO TAKE EFFECT, THEN REMOVE ALL DEAD SOD AND WEEDS TO A MINIMUM DEPTH OF TWO (2) INCHES. ADD A MINIMUM OF FOUR (4) TO SIX (6) INCHES OF NEW TOPSOIL TO ALL LAWN AREAS. BACK FILL AND COMPACT TOPSOIL TO THE TOP OF ALL CURBS AND WALKS PRIOR TO SODDING. RE-GRADE TO ELIMINATE ALL BUMPS AND DEPRESSIONS AND RE-SOD ALL AREAS.
  - B. EXISTING LAWN FOUND TO BE GENERALLY IN GOOD CONDITION BUT WITH BARE, SPARSE OR WEEDY AREAS MUST BE RENOVATED BY FILLING IN LOW AREAS. RAKING. OVER SEEDING AND TOP DRESSING ALL SPARSE AND BARE SPOTS AND BY INITIATING A WEED AND FEED PROGRAM.
- 10. THE CONTRACTOR SHALL BACKFILL DIRECTLY BEHIND ALL CURBS AND ALONG SIDEWALKS AND COMPACT TO THE TOP OF CURB OR WALK TO SUPPORT VEHICLE AND PEDESTRIAN WEIGHT WITHOUT SETTLING. ALL LANDSCAPE AREAS. ESPECIALLY PARKING LOT ISLANDS AND LANDSCAPE BEDS NEXT TO BUILDINGS SHALL BE EXCAVATED OF ALL BUILDING MATERIALS AND POOR SOILS TO A DEPTH OF 12"- 18" AND BACKFILLED WITH GOOD, MEDIUM TEXTURED PLANTING SOIL (LOAM OR LIGHT YELLOW CLAY). ADD 4"-6" OF TOPSOIL OVER FILL MATERIAL AND CROWN A MINIMUM OF 6" ABOVE TOP OF CURBS AND/OR WALKS AFTER EARTH SETTLING UNLESS OTHERWISE NOTED ON THE LANDSCAPE PLAN.
- 11. IN NATURAL AREAS THE FOLLOWING PROCEDURES SHALL BE FOLLOWED:
- A. REMOVE ANY TREES AND BRUSH PER CITY OF MILAN DIRECTION ONLY. B. REMOVE TRASH AND PERFORM SURFACE GRADING (IF ANY) ONLY TO FILL IN THE WORST LOW SPOTS. DO NOT
- CUT OR FILL AROUND TREES. C. RAKE, HYDROSEED AND MULCH BARE GROUND AREAS WITH PROPER SEED MIX (SHADE OR SUNNY MIX). D. LET AREA REVERT TO TREES AND SHRUBS. MOW VERY MINIMALLY, IF NECESSARY.
- 12. LANDSCAPE BERMS ARE TO BE CONSTRUCTED OF LIGHT YELLOW CLAY OR LOAM SOILS AND ARE TO BE FREE OF CONSTRUCTION MATERIALS AND DEBRIS. USE OF HEAVY CLAYS FOR BERM CONSTRUCTION MUST BE APPROVED BY
- THE CITY OF MILAN PRIOR TO INSTALLATION. SLOPES ARE TO BE NO STEEPER THAN 1:3 UNLESS OTHERWISE SPECIFIED ON THE LANDSCAPE PLAN. 13. CONVERSION OF ALL ASPHALT AND GRAVEL AREAS TO LANDSCAPE SHALL BE DONE IN THE FOLLOWING MANNER:
- A. THE CONTRACTOR SHALL REMOVE ALL ASPHALT, GRAVEL AND COMPACTED EARTH TO A DEPTH OF 6 18"; DEPENDING ON THE DEPTH OF THE SUB BASE AND DISPOSE OF OFF SITE FOR AN INSPECTION PRIOR TO BACKFILLING.
- B. REPLACE EXCAVATED MATERIAL WITH GOOD, MEDIUM TEXTURED PLANTING SOIL (LOAM OR LIGHT YELLOW CLAY) TO A MINIMUM OF 2" ABOVE TOP OF CURB AND SIDEWALK, ADD 4–6" OF TOPSOIL AND CROWN TO A MINIMUM OF 6" ABOVE ADJACENT CURB AND WALK AFTER EARTH SETTLING, UNLESS OTHERWISE NOTED ON THE LANDSCAPE PLAN.
- 14. ALL EXISTING TREES ON SITE AND IN THE RIGHT-OF-WAY SHALL BE PRUNED AS DIRECTED BY THE CITY TO REMOVE DEAD, DYING AND HAZARDOUS LIMBS OR TO REMOVE LIMBS WHICH IMPEDE CONSTRUCTION, DRIVEWAYS AND SIDEWALKS. PRUNING AND DEEP-ROOT FERTILIZING IS TO BE DONE ONLY BY A QUALIFIED, LICENSED TREE SERVICE COMPANY.
- 15. THE CONSTRUCTION OF DETENTION BASINS SHOULD BE MADE WITH THE FOLLOWING GOALS IN MIND: A. NATURAL, WITH FREE FORM APPEARING GRADES. B. SLOPES OF 1:4 OR FLATTER.
  - C. NO FENCING. D. NO WATER LEVELS TO BE RETAINED.
- E. MOW SLOPES AND LET BOTTOM OF BASIN REVERT TO NATURAL VEGETATION.
- 16. PROVIDE CONTINUOUS CURBING AROUND ALL LANDSCAPE AREAS ON SITE. ALTERNATE LANDSCAPE AREA PROTECTION SUCH AS DECORATIVE FENCES, RETAINING WALLS, ETC., MAY BE ACCEPTABLE IN LIEU OF CURBING OR MAY BE REQUIRED IN ADDITION TO CURBING TO PROTECT THE LANDSCAPE AREAS AND PROPERLY DEFLECT VEHICULAR AND PEDESTRIAN TRAFFIC.

Plannin'g, Engineering & Environmental Services

> Beckett & Raeder, Inc. 535 West William, Suite 101 Ann Arbor, MI 48103

734 663.2622 ph

734 **663.6759** fx

Seal

**Storage Development** 

Milan, Michigan

Sheet Title

Landscape Details

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07.15.2019	Owner Review

As Shown

Quality Control Checked: KE Approved: KE

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