



PITTSFIELD CHARTER TOWNSHIP

MONTIBELLER PARK
IMPROVEMENTS
PHASE 2



BID SET
JANUARY, 2023
PROJECT NUMBER: 2075140801
LWCF GRANT: 26-01847



PROJECT LOCATION MAPS
NOT TO SCALE

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CONSTRUCTION NOTES

- PRE-CONSTRUCTION MEETING
A PRE-CONSTRUCTION MEETING SHALL BE HELD PRIOR TO ANY WORK BEING PERFORMED ON THE PROJECT. THE MEETING TIME, PLACE, AND ATTENDEES SHALL BE ARRANGED BY THE PROJECT ENGINEER. WASHTENAW COUNTY WATER RESOURCES COMMISSION AND PITTSFIELD CHARTER TOWNSHIP SHALL BE INVITED, AT A MINIMUM TO THE PRE-CONSTRUCTION MEETING.
- SHOP DRAWINGS AND MATERIAL CERTIFICATES
PRIOR TO THE START OF CONSTRUCTION THE CONTRACTOR SHALL FURNISH MATERIAL SOURCE LISTS AND CERTIFICATIONS TO THE PROJECT ENGINEER. VERIFYING THAT ALL MATERIALS USED ON THE PROJECT ARE IN ACCORDANCE WITH MICHIGAN DEPARTMENT OF TRANSPORTATION 2020 STANDARD SPECIFICATIONS FOR CONSTRUCTION. SHOP DRAWINGS AND/OR CATALOG CUTS SHALL BE REQUIRED FOR MAJOR MATERIALS.
- MISS DIG UTILITY ALERT AND FIELD LOCATION OF UTILITIES
THREE (3) WORKING DAYS PRIOR TO BEGINNING CONSTRUCTION, IT SHALL BE THE CONTRACTOR'S RESPONSIBILITY TO CONTACT MISS DIG UTILITY PROTECTION SERVICE (811) TO VERIFY THE LOCATION OF ALL EXISTING UTILITIES. UNDERGROUND UTILITY LOCATIONS AS SHOWN ON THE PLANS WERE OBTAINED FROM UTILITY OWNERS AND WERE NOT FIELD LOCATED. THE CONTRACTOR SHALL ASSUME RESPONSIBILITY FOR THE PROTECTION OF ALL EXISTING UTILITIES DURING CONSTRUCTION. ALL UTILITIES DAMAGED DURING CONSTRUCTION SHALL BE REPAIRED WITH LIKE MATERIAL IN ACCORDANCE WITH THE UTILITY OWNERS REQUIREMENTS. THE CONTRACTOR SHALL VERIFY THE DEPTH AND HORIZONTAL LOCATION OF ALL EXISTING UTILITIES. THE EXACT LOCATION OF EXISTING UTILITIES SHALL BE DETERMINED BY HAND DIGGING.
- UTILITY INFORMATION
PUBLIC UTILITY INFORMATION IS DELINEATED IN ACCORDANCE WITH LOCATIONS PROVIDED BY UTILITY OWNERS. THE DESIGN ENGINEER IS NOT RESPONSIBLE FOR THE ACCURACY OF THE INFORMATION OR THE LOCATION AT WHICH THESE SERVICES EXIST. DIFFERING FIELD CONDITIONS SHALL BE BROUGHT TO THE ATTENTION OF THE ENGINEER.

THE LOCATION OF ALL PUBLIC UTILITIES SHOWN ON THE PLANS ARE TAKEN FROM THE BEST AVAILABLE DATA. THE OWNER WILL NOT BE RESPONSIBLE FOR ANY OMISSION OR VARIATIONS FROM THE LOCATIONS SHOWN.

CONSTRUCTION OPERATIONS SHALL BE CONDUCTED IN A MANNER AS TO INSURE THAT THOSE UTILITIES NOT REQUIRING RELOCATION WILL NOT BE DISTURBED. REPAIRATIONS OF UTILITIES DAMAGED DURING CONSTRUCTION BY THE CONTRACTOR SHALL BE THE FULL RESPONSIBILITY OF THE CONTRACTOR IN ACCORDANCE WITH THE AFFECTED UTILITY OWNERS REQUIREMENTS.

ALL PRIVATE UTILITY STRUCTURES WILL BE ADJUSTED TO GRADE BY THE OWNER OF THE FACILITY. THE CONTRACTOR SHALL PROVIDE THE ENGINEER WITH THREE (3) WORKING DAYS NOTICE PRIOR TO THE START OF SUCH WORK.
- STORMWATER DRAINAGE DURING CONSTRUCTION
THE CONTRACTOR SHALL MAINTAIN DITCH DRAINAGE DURING CONSTRUCTION AND SHALL NOT OBSTRUCT SUMP PUMP LEADS DISCHARGING TO THE DITCH. THE CONTRACTOR SHALL TAKE ALL NECESSARY MEASURES TO PROTECT ALL STORM SEWER FACILITIES SUCH AS CATCH BASINS, CULVERTS AND HEADWALLS DURING CONSTRUCTION. CULVERTS AND CATCH BASINS CONTAMINATED DURING CONSTRUCTION SHALL BE CLEANED AND THE COSTS SHALL BE INCLUDED IN THE EROSION CONTROL AND PROJECT CLEAN UP PAY ITEMS.
- EXISTING UTILITIES
THE CONTRACTOR SHALL MAINTAIN ALL EXISTING SANITARY SEWER, WATER OR STORM SEWER SERVICE CONNECTIONS IN SERVICE THROUGHOUT THE CONSTRUCTION PERIOD. THE CONTRACTOR SHALL PROVIDE OR ARRANGE FOR TEMPORARY SUPPORT OF GAS MAIN AND UTILITY POLES WHERE NEEDED. ALL STORM SEWERS DAMAGED OR REMOVED OR RELOCATED BY THE CONTRACTOR SHALL BE REPLACED WITH THE SAME SIZE AND QUALITY PIPE BY THE CONTRACTOR AT NO ADDITIONAL COST TO THE PROJECT. ALL UTILITIES UNDERMINED BY THE EXCAVATION SHALL HAVE COMPACTED CLASS II SAND BACKFILL PLACED UNDER THEM.
- UTILITY COORDINATION
FOR UTILITIES THAT NEED TO BE RELOCATED DURING CONSTRUCTION, THE CONTRACTOR WILL COORDINATE WITH THE RESPECTIVE UTILITY OWNER TO COMPLETE THIS TASK. THE COST TO RELOCATE UTILITIES WILL BE PAID FOR BY OTHERS. NO ADDITIONAL COST FOR COORDINATION EFFORTS INCURRED BY THE CONTRACTOR WILL BE PROVIDED.
- PROTECTION OF HAZARDOUS AREAS / OPEN EXCAVATIONS
EXCAVATIONS AND HAZARDOUS AREAS SHALL BE PROTECTED BY BARRICADES OR SNOW FENCE.

THE PLACEMENT OF PROTECTIVE FENCING MEETING MICHSA STANDARDS IS REQUIRED AROUND ALL OPEN EXCAVATIONS. THIS WILL NOT BE PAID FOR SEPARATELY, BUT WILL BE CONSIDERED AS HAVING BEEN IN THE CONTRACT UNIT PRICE BID FOR MINOR TRAFFIC DEVICES.
- DISPOSAL OF EXCESS EXCAVATED MATERIAL
ALL EXCESS EXCAVATED MATERIALS SHALL BE DISPOSED OF BY THE CONTRACTOR AT A LOCATION PROVIDED BY THE CONTRACTOR. ADJACENT PROPERTY OWNERS SHALL BE GIVEN PREFERENCE FOR DISPOSAL SITES.
- SALVAGEABLE MATERIALS
SALVAGEABLE MATERIALS SHALL BECOME THE PROPERTY OF THE OWNER, AND SHALL BE STORED AS DIRECTED BY THE ENGINEER.

ALL SIGNS RELOCATED BY CONSTRUCTION SHALL BE REPLACED. SIGNS AND POSTS REMOVED SHALL BE STOCKPILED AT A LOCATION SPECIFIED BY THE ENGINEER.
- SAW CUTS
ALL SAW CUTS SHOWN ON THE PLANS OR AS SPECIFIED WILL NOT BE PAID FOR SEPARATELY, BUT WILL BE CONSIDERED AS HAVING BEEN INCLUDED IN PAVEMENT REMOVAL ITEMS.
- TREE PROTECTION
PRIOR TO GRADING/CLEARING, ALL TREES TO REMAIN SHALL BE PROTECTED USING FENCE, PROTECTIVE. THE FENCING SHALL BE PLACED AT THE DRIP LINE AROUND THE ENTIRE CIRCUMFERENCE.
- TREE REMOVAL
PRIOR TO ANY TREE REMOVAL, ENGINEER SHALL MARK TREE WITH APPROVED TAPE AND COORDINATE REMOVAL OF TREE WITH PITTSFIELD PARKS 72 HOURS IN ADVANCE.
- HERBICIDE APPLICATION
WITHIN 48 HOURS OF TREE AND BRUSH REMOVAL, CONTRACTOR SHALL APPLY GLYPHOPHATE (OR APPROVED EQUAL) VEGETATION SOLUTION AT MANUFACTURER'S RECOMMENDED APPLICATION RATE TO ALL EXPOSED ROOT MATERIAL. PAID FOR AS: GRADING, MODIFIED.
- GRADING LIMITS
THE GRADING/CLEARING LIMIT LINES SHOWN ON THE PLANS ARE GENERAL LIMITS PROVIDED IN ADDITION TO THE PATH PROFILE TO GUIDE THE CONTRACTOR IN ESTIMATING DISTURBANCE AREAS, AS WELL AS EXCAVATION AND EMBANKMENT. AREAS TO BE GRADED MAY EXTEND PAST THESE LIMITS WHEN WITHIN THE PARK PROPERTY WITH THE PERMISSION OF THE ENGINEER. THE CONTRACTOR SHALL ESTIMATE RESTORATION IMPACTS BASED ON THEIR ANALYSIS OF THE INFORMATION PROVIDED, AND NOT NECESSARILY THE GRADING LIMIT LINES SHOWN ON THE PLANS, AND SHALL BE RESPONSIBLE FOR PROVIDING ALL SITE RESTORATION FOR A SQUARE YARD AMOUNT AS PROVIDED IN SLOPE RESTORATION AND PROJECT CLEAN UP PAY ITEMS. DISTURBANCE LIMITS SHALL BE MINIMIZED TO PROTECT ALL NATURAL AREAS. ALL DISTURBED AREAS SHALL BE RESTORED AS NEW.
- COVERS AND CASTINGS
ALL FINAL ELEVATIONS OF MANHOLE CASTINGS, HYDRANTS, VALVES AND VALVE BOXES SHALL BE DETERMINED BY THE ENGINEER IN THE FIELD. CASTINGS DAMAGED BY THE CONTRACTOR SHALL BE REPLACED AT THE EXPENSE OF THE CONTRACTOR, WITH MATERIALS APPROVED BY THE ENGINEER.
- RESTORATION OF GRAVEL SHOULDERS
FOR GRAVEL SHOULDERS CONTAMINATED BY CONSTRUCTION THE CONTRACTOR SHALL RE-GRAVEL WITH 23A CRUSHED LIMESTONE TO MICHIGAN DEPARTMENT OF TRANSPORTATION 2020 STANDARD SPECIFICATIONS FOR CONSTRUCTION. FOR SHOULDERS REMOVED BY CONSTRUCTION THE MINIMUM REPLACEMENT SHALL BE 4' WIDE BY 4" DEEP, INCIDENTAL TO OTHER PAY ITEMS.
- A WASHTENAW COUNTY WATER RESOURCES PERMIT NUMBER DRA2021-00090 HAS BEEN ACQUIRED FOR THE PROJECT.

PROJECT AND UTILITY CONTACTS:

NAME: PITTSFIELD CHARTER TOWNSHIP (GRANTEE)
ADDR: 6201 WEST MICHIGAN AVE. ANN ARBOR, MI 48108
PHONE: 734-822-3134
EMAIL: WEST@PITTSFIELD-MI.GOV
CONTACT: JESSICA WEST

NAME: PITTSFIELD CHARTER TOWNSHIP (UTILITIES)
ADDR: 6201 WEST MICHIGAN AVE. ANN ARBOR, MI 48108
PHONE: 734-822-2110
EMAIL: UTILITIES@PITTSFIELD-MI.GOV
CONTACT: BILLY WEIRICH

NAME: PITTSFIELD CHARTER TOWNSHIP (PARKS AND RECREATION)
ADDR: 701 ELLSWORTH RD. ANN ARBOR, MI 48108
PHONE: 734-822-2114
EMAIL: WADER@PITTSFIELD-MI.GOV
CONTACT: RICH WADE

NAME: WASHTENAW COUNTY WATER RESOURCES COMMISSION
ADDR: 705 N. ZEEB RD. ANN ARBOR, MI 48103
PHONE: 734-222-8860
EMAIL: MILLERS@WASHTENAW.ORG
CONTACT: SCOTT MILLER, PE

NAME: STANTEC CONSULTING MICHIGAN INC. (PRIME PROFESSIONAL)
ADDR: 1188 OAK VALLEY DRIVE STE 100, ANN ARBOR, MI 48108
PHONE: 734-761-1010
EMAIL: CLAIRE.MARTIN@STANTEC.COM
CONTACT: CLAIRE MARTIN, PE

GENERAL NOTES

- IF PROJECT DISTURBANCE AREA EXCEEDS 5 ACRES, CONTRACTOR MUST APPLY FOR NOTICE OF COVERAGE FROM EGLE.
- PATHWAY TO MEET ALL BARRIER FREE UNIVERSAL ACCESS REQUIREMENTS.
- THERE IS EXTENSIVE BRUSH ADJACENT TO THE PROPOSED PATH. BRUSH LIMITS ARE NOT SHOWN ON THE PLANS, CONTRACTOR TO FIELD VERIFY PRIOR TO SUBMITTING BID, AND INCLUDE COST OF ALL BRUSH CLEANING NECESSARY TO CONSTRUCT THE PATHWAY.
- ALL PATH RAMP ARE TO BE ADA COMPLIANT AND BE CONSTRUCTED WITH 6" THICK CONCRETE WITH THE INSTALLATION OF DETECTABLE WARNING SURFACES PER MDOT STANDARD DETAIL.
- NO CHEMICALS ARE ALLOWED IN STORMWATER FEATURES OR BUFFER ZONES WITH THE FOLLOWING EXCEPTION: INVASIVE SPECIES MAY BE TREATED WITH CHEMICALS BY A CERTIFIED APPLICATOR.

TRAFFIC NOTES

- ACCESS TO ALL DRIVEWAYS MUST BE MAINTAINED AT ALL TIMES. AT LEAST ONE PARKING LOT IN MONTIBELLER PARK MUST REMAIN OPEN AT ALL TIMES. PHASING OF PARKING LOT IMPROVEMENTS MUST BE CONSIDERED ACCORDINGLY.
- ALL TRAFFIC CONTROL DEVICES AND THEIR USAGE MUST CONFORM TO THE MICHIGAN MANUAL OF UNIFORM TRAFFIC CONTROL DEVICES (MMUTCD), LATEST EDITION.
- ALL EXISTING PAVEMENT MARKINGS THAT ARE REMOVED FOR TRAFFIC CONTROL OR OBLITERATED DURING CONSTRUCTION OPERATIONS MUST BE REPLACED WITH POLYUREA FOR THE LONGITUDINAL LANE LINES.
- ALL SIGNS MATERIALS AND SUPPORTS MUST MEET NCHRP-350 CRASH WORTHY REQUIREMENTS.
- THERE MUST BE NO HAULING OF MATERIALS INCLUDING TRUCKS ENTERING AND EXITING IN OR OUT OF THE SITE (WORK ZONE) BETWEEN THE HOURS OF 6:00 A.M. TO 9:00 A.M. AND 2:00 P.M. TO 7:00 P.M., MONDAY THROUGH FRIDAY.

| Maintenance Tasks and Schedule | | COMPONENTS | | | | | | | | | | SCHEDULE | |
|--|--|------------|-----------------------|--------------------|----------------------------|---------|-------------------------------|-----------------|-----------------|----------|--------------------|--|--|
| TASKS | | STREETS | STORM DRAINAGE SYSTEM | CATCH BASIN INLETS | CATCH BASIN INLET CASTINGS | CHANGES | VEGETATION CONTROL STRUCTURES | RETENTION BASIN | RETENTION BASIN | WETLANDS | EMERGENCY OVERFLOW | | |
| INSPECT FOR SEDIMENT ACCUMULATION | | X | X | X | X | X | X | X | X | X | X | ANNUALLY | |
| REMOVAL OF SEDIMENT ACCUMULATION | | X | X | X | X | X | X | X | X | X | X | EVERY 5-10 YEARS AS NEEDED* | |
| INSPECT FOR FLOATABLES AND DEBRIS | | X | X | X | X | X | X | X | X | X | X | ANNUALLY | |
| CLEANING FOR FLOATABLES AND DEBRIS | | X | X | X | X | X | X | X | X | X | X | ANNUALLY | |
| INSPECTION FOR EROSION | | X | X | X | X | X | X | X | X | X | X | ANNUALLY | |
| SESC INSPECTION FOLLOWING STORMS OF 1 INCH OF MORE | | X | X | X | X | X | X | X | X | X | X | AS NEEDED | |
| REESTABLISH PERMANENT VEGETATION ON ERODED SLOPES | | | | | | X | | | | | | AS NEEDED | |
| REPLACEMENT OF GRAVEL JACKETS | | | | | | | | | | | | EVERY 3-5 YEARS AS NEEDED* | |
| CLEAN STREETS AND PARKING LOTS | | | | | | | | | | | | SEMI-ANNUALLY | |
| MOWING | | | | | | X | | | | X | | 1 TIME PER YEAR | |
| INSPECT STRUCTURAL ELEMENTS DURING WET WEATHER AND COMPARE TO AS-BUILT PLANS (BY A PROFESSIONAL ENGINEER REPORTING TO THE OWNER) | | | X | | | X | X | X | X | X | X | ANNUALLY | |
| MAKE ADJUSTMENTS OR REPLACEMENTS AS DETERMINED BY ANNUAL WET WEATHER INSPECTION | | | X | | | X | X | X | X | X | X | AS NEEDED | |
| KEEP RECORDS OF ALL INSPECTIONS AND MAINTENANCE ACTIVITIES AND REPORT TO OWNER | | | X | X | X | X | X | X | X | X | X | ANNUALLY | |
| KEEP RECORDS OF ALL COSTS FOR INSPECTIONS, MAINTENANCE AND REPAIRS. REPORT TO OWNER | | | X | X | X | X | X | X | X | X | X | ANNUALLY | |
| REVIEW COST EFFECTIVENESS OF THE PREVENTATIVE MAINTENANCE PROGRAM AND MAKE ADJUSTMENTS AS NEEDED | | | X | X | X | X | X | X | X | X | X | ANNUALLY | |
| OWNER TO HAVE A PROFESSIONAL ENGINEER CARRY OUT EMERGENCY INSPECTIONS UPON IDENTIFICATION OF SEVERE PROBLEMS | | | X | X | X | X | X | X | X | X | X | AS NEEDED | |
| WATER DISTURBED AREAS TO PROVIDE DUST CONTROL | | | | | | | | | | | | WEEKLY OR AS DETERMINED BY PERMITTING AGENCY | |

* "AS NEEDED" MEANS WHEN SEDIMENT HAS ACCUMULATED TO A MAXIMUM OF ONE FOOT DEPTH
- REGULAR STORM WATER MANAGEMENT SYSTEM MAINTENANCE WILL BE PERFORMED BY AN OPERATIONS COMPANY, CONTRACTED BY PITTSFIELD TOWNSHIP.
- THE ESTIMATED ANNUAL BUDGET FOR MAINTENANCE IS:
\$200 - FOR YEARLY INSPECTION
\$100 - FOR YEARLY MOWING
\$100/YEAR FOR SEDIMENT REMOVAL, REQUIRED REPAIRS
\$50/YEAR FOR RECORD KEEPING
\$50/YEAR FOR AS-NEEDED EMERGENCY INSPECTIONS
\$500 TOTAL ESTIMATED ANNUAL BUDGET

Table 1 - Infiltration Test Results

| Test Pit | Test No. | Stabilized Infiltration Rate (in/hr) | Average Infiltration Rate (in/hr) | Design Infiltration Rate (in/hr) |
|----------|----------|--------------------------------------|-----------------------------------|----------------------------------|
| TP-3 | 3.1 | 70 1/2 | 70 7/8 | 10* |
| | 3.2 | 71 1/4 | | |
| TP-4 | 4.1 | 15 | 11 1/4 | 5 5/8 |
| | 4.2 | 7 1/2 | | |

*WCWRC Procedures and Design Criteria for Stormwater Management specify a maximum design infiltration rate of 10 in/hr.

| W1-a | Rational Method Variables | Cover Type | | Soil Type | Area (SFT) | Area (Ac) | C | C x A (Ac) | C x A (sf) | |
|------|---------------------------|---|--|-----------|---------------------------------|-----------|---------------------------------|-------------|-------------|-------------|
| | | Roof | | D | 0 | 0.00 | 0.95 | 0.00 | 0 | |
| | | Gravel (6-foot Limestone Pathway, South Baseball Field) | | B/D | 81222 | 1.86 | 0.85 | 1.58 | 69039 | |
| | | Concrete (Brick Paver Areas, Sidewalk) | | B/D | 11853 | 0.27 | 0.95 | 0.26 | 11260 | |
| | | Asphalt (Pickleball Court) | | D | 9148 | 0.21 | 0.95 | 0.20 | 8691 | |
| | | Lawn (Slope 4-8%) | | B/D | 136343 | 3.13 | 0.46 | 1.44 | 62718 | |
| | | | | | | | Total C x A | | 3.48 | 151707 |
| | | | | | Total Area | | 5.48 | 238565.8 | | |
| | | | | | Weighted C - (Tot CxA)/(Tot A) | | 0.64 | 0.64 | | |
| W1-b | NRCS Variables Pervious | Cover Type | | Soil Type | Area (SFT) | Area (Ac) | CN | CN x A (Ac) | CN x A (sf) | |
| | | Lawn | | B/D | 136343 | 3.13 | 76 | 238.51 | 10389321 | |
| | | | | | | | Total CN x A | | 238.51 | 10389321.36 |
| | | | | | | | Total Area | | 3.13 | 136342.8 |
| | | | | | | | Weighted CN - (Tot CNA)/(Tot A) | | 76 | 76 |
| | | | | | | | | | | |
| | | | | | | | | | | |
| W1-c | NRCS Variables Impervious | Cover Type | | Soil Type | Area (SFT) | Area (Ac) | CN | CN x A (Ac) | CN x A (sf) | |
| | | Roof | | D | 0 | 0.00 | 98 | 0.0 | 0 | |
| | | Gravel (6" Limestone Pathway, South Baseball Field) | | B/D | 81222 | 1.86 | 91 | 169 | 756835 | |
| | | Concrete (Brick Paver Areas, Sidewalk) | | B/D | 11853 | 0.27 | 98 | 27 | 1161594 | |
| | | Asphalt (Pickleball Court) | | D | 9148 | 0.21 | 98 | 21 | 896504 | |
| | | | | | | | Total CN x A | | 216 | 9424933.4 |
| | | | | | | | Total Area | | 2.35 | 102223 |
| | | | | | Weighted CN - (Tot CNA)/(Tot A) | | 92 | 92 | | |

| LEGEND | | | |
|--------|------------------------------------|--------|--------------------------------------|
| SYMBOL | DESCRIPTION | SYMBOL | DESCRIPTION |
| | EXIST. CONTOUR | | EXIST. CURB AND GUTTER |
| | PROP. CONTOUR | | PROP. CURB AND GUTTER |
| | EXIST. SPOT ELEVATION | | CENTERLINE OF DITCH |
| | PROP. SPOT ELEVATION | | EDGE OF WATER |
| | TOP OF CURB | | EDGE OF WETLAND |
| | TOP OF PAVEMENT | | EXISTING FENCE |
| | GUTTER | | PROPOSED FENCE |
| | EXIST. STORM SEWER | | TREE PROTECTION FENCE |
| | PROP. STORM SEWER | | SILT FENCE |
| | EXIST. MANHOLE | | CLEARING LIMITS |
| | PROP. MANHOLE | | EXIST. GUARDRAIL |
| | PROP. EDGE DRAIN | | PROP. GUARDRAIL |
| | EXIST. CATCH BASIN/INLET | | PROPERTY LINE |
| | PROP. CATCH BASIN/INLET | | CENTERLINE |
| | END SECTION/HEAD WALL | | EXIST. SIGN |
| | CULVERT | | PROP. SIGN |
| | INLET FILTER | | ENCLOSED TRASH AREA |
| | PROP. CLEANOUT | | DRAINAGE DIRECTION |
| | EXIST. SANITARY SEWER | | SIDEWALK RAMP |
| | PROP. SANITARY SEWER | | BARRIER FREE PARKING |
| | EXIST. WATER MAIN | | FINISH FLOOR ELEV. |
| | PROP. WATER MAIN | | FINISH GRADE ELEV. |
| | EXIST. HYDRANT | | BASEMENT FLOOR ELEV. |
| | PROP. HYDRANT | | GARAGE FLOOR ELEV. |
| | EXIST. POST INDICATOR VALVE | | SECTION CORNER |
| | EXIST. GATE VALVE AND BOX/STOP BOX | | CONTROL POINT |
| | PROP. GATE VALVE AND WELL | | FOUND IRON PIPE |
| | PROP. GATE VALVE AND WELL | | SET IRON PIPE |
| | PROP. REDUCER | | FOUND CONCRETE MONUMENT |
| | PROP. END CAP | | SET CONCRETE MONUMENT |
| | EXIST. OVERHEAD ELECTRIC | | FOUND PK NAIL |
| | PROP. OVERHEAD ELECTRIC | | SET PK NAIL |
| | EXIST. UNDERGROUND ELECTRIC | | FOUND LEADED CHISEL HOLE |
| | PROP. UNDERGROUND ELECTRIC | | SET LEADED CHISEL HOLE |
| | EXIST. LIGHT POLE | | FOUND REROO |
| | PROP. LIGHT POLE | | APPROX. LOCATION OF SOIL BORING |
| | EXIST. UTILITY POLE | | APPROX. LOCATION OF MONITORING WELL |
| | GUY WIRE | | APPROX. LOCATION OF PENETRATION TEST |
| | EXIST. ELECTRIC TRANSFORMER | | EXIST. DECIDUOUS TREE |
| | PROP. ELECTRIC TRANSFORMER | | EXIST. EVERGREEN TREE |
| | EXIST. OVERHEAD TELEPHONE | | EXIST. SHRUB |
| | PROP. OVERHEAD TELEPHONE | | EXIST. TREE OR BRUSH LIMIT |
| | EXIST. UNDERGROUND TELEPHONE | | TREE TO BE REMOVED |
| | PROP. UNDERGROUND TELEPHONE | | REMOVE AND REPLACE |
| | EXIST. GAS | | BITUMINOUS PAVEMENT |
| | PROP. GAS | | GRAVEL PAVEMENT |
| | EXIST. MAILBOX | | CONCRETE PAVEMENT |
| | EXIST. GAS RISER | | BRICK PAVERS |
| | EXIST. TELEPHONE RISER | | |
| | COMPACTED SAND BACKFILL | | |

STORMWATER DESIGN CALCULATIONS

| First Flush Volume Rational | |
|---------------------------------------|-----------|
| Vff = (1/12) * (1/12) * 43560 * A * C | |
| A | 5.48 |
| C | 0.64 |
| Vff | 12642 CFT |

| Presettlement Bankfull Runoff Calculation (Vbf-pre) | |
|--|-----------------------|
| 2 yr / 24 hour storm | P 2.35 in |
| Determine Presettlement CN. Assume Good Cover Forestland w/ Meadow | CN (Soil Type B/D) 74 |
| S = 1000/CN - 10 | S 3.51 in |
| Q = (P - 0.2*S)^2 / (P + 0.8*S) | Q 0.53 in |
| Total site area excluding "Self Creditting" BMPs | A 136342.8 cf |
| Vbf-pre = Q(1/12)A | Vbf-pre 6975 cf |

| Pervious Cover Post-Development Bankfull Runoff Calculation (Vbf-per-post) | |
|--|----------------------|
| 2 yr / 24 hour storm | P 2.35 in |
| | CN 76 |
| S = 1000/CN - 10 | S 3.12 in |
| Q = (P - 0.2*S)^2 / (P + 0.8*S) | Q 0.61 in |
| Total site area excluding "Self Creditting" BMPs | A 136342.8 cf |
| Vbf-per-post = Q(1/12)A | Vbf-per-post 6975 cf |

| Impervious Cover Post-Development Bankfull Runoff Calculation (Vbf-imp-post) | |
|--|-----------------------|
| 2 yr / 24 hour storm | P 2.35 in |
| | CN 92 |
| S = 1000/CN - 10 | S 0.85 in |
| Q = (P - 0.2*S)^2 / (P + 0.8*S) | Q 1.57 in |
| Total site area excluding "Self Creditting" BMPs | A 102223 cf |
| Vbf-imp-post = Q(1/12)A | Vbf-imp-post 13385 cf |

| Pervious Cover Post-Development 1% Storm Runoff Calculation (V100-per-post) | |
|---|------------------------|
| 100-yr storm | P 5.11 in |
| | CN 76 |
| S = 1000/CN - 10 | S 3.12 in |
| Q = (P - 0.2*S)^2 / (P + 0.8*S) | Q 2.64 in |
| Total site area excluding "Self Creditting" BMPs | A 136342.8 cf |
| V100-per-post = Q(1/12)A | V100-per-post 30042 cf |

| Impervious Cover Post-Development 1% Storm Runoff Calculation (V100-imp-post) | |
|---|------------------------|
| 100-yr storm | P 5.11 in |
| | CN 92 |
| S = 1000/CN - 10 | S 0.85 in |
| Q = (P - 0.2*S)^2 / (P + 0.8*S) | Q 4.22 in |
| Total site area excluding "Self Creditting" BMPs | A 102223 cf |
| V100-imp-post = Q(1/12)A | V100-imp-post 35955 cf |

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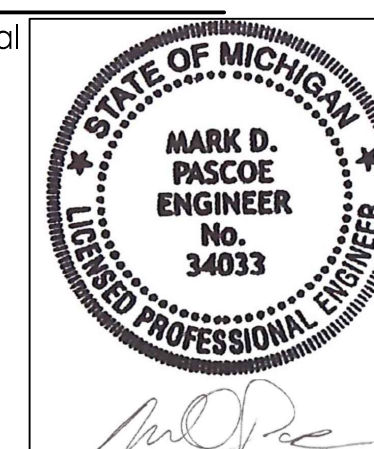
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Consultant

Notes

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PITTSFIELD CHARTER TOWNSHIP

MONTIBELLER PARK IMPROVEMENTS
PHASE 2

Pittsfield Township, Michigan

Title

OVERALL EXISTING CONDITIONS

Project No.
2075140801

Scale 0 100' 200'

| | |
|----------|----------|
| Revision | Sheet |
| 0 | 03 of 24 |

Drawing No.

C001

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| Issued | | By | Appd | YYYY.MM.DD |
| File Name: 140801C-002 | JDA | AMS | MDP | 2020.03.10 |
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PITTSFIELD CHARTER TOWNSHIP

MONTIBELLER PARK IMPROVEMENTS
PHASE 2

Pittsfield Township, Michigan

Title

OVERALL PROPOSED SITE PLAN


Project No.
207514080

Revision Sheet
0 04 of 24

Scale 0 100' 200'


Drawing No.

C002

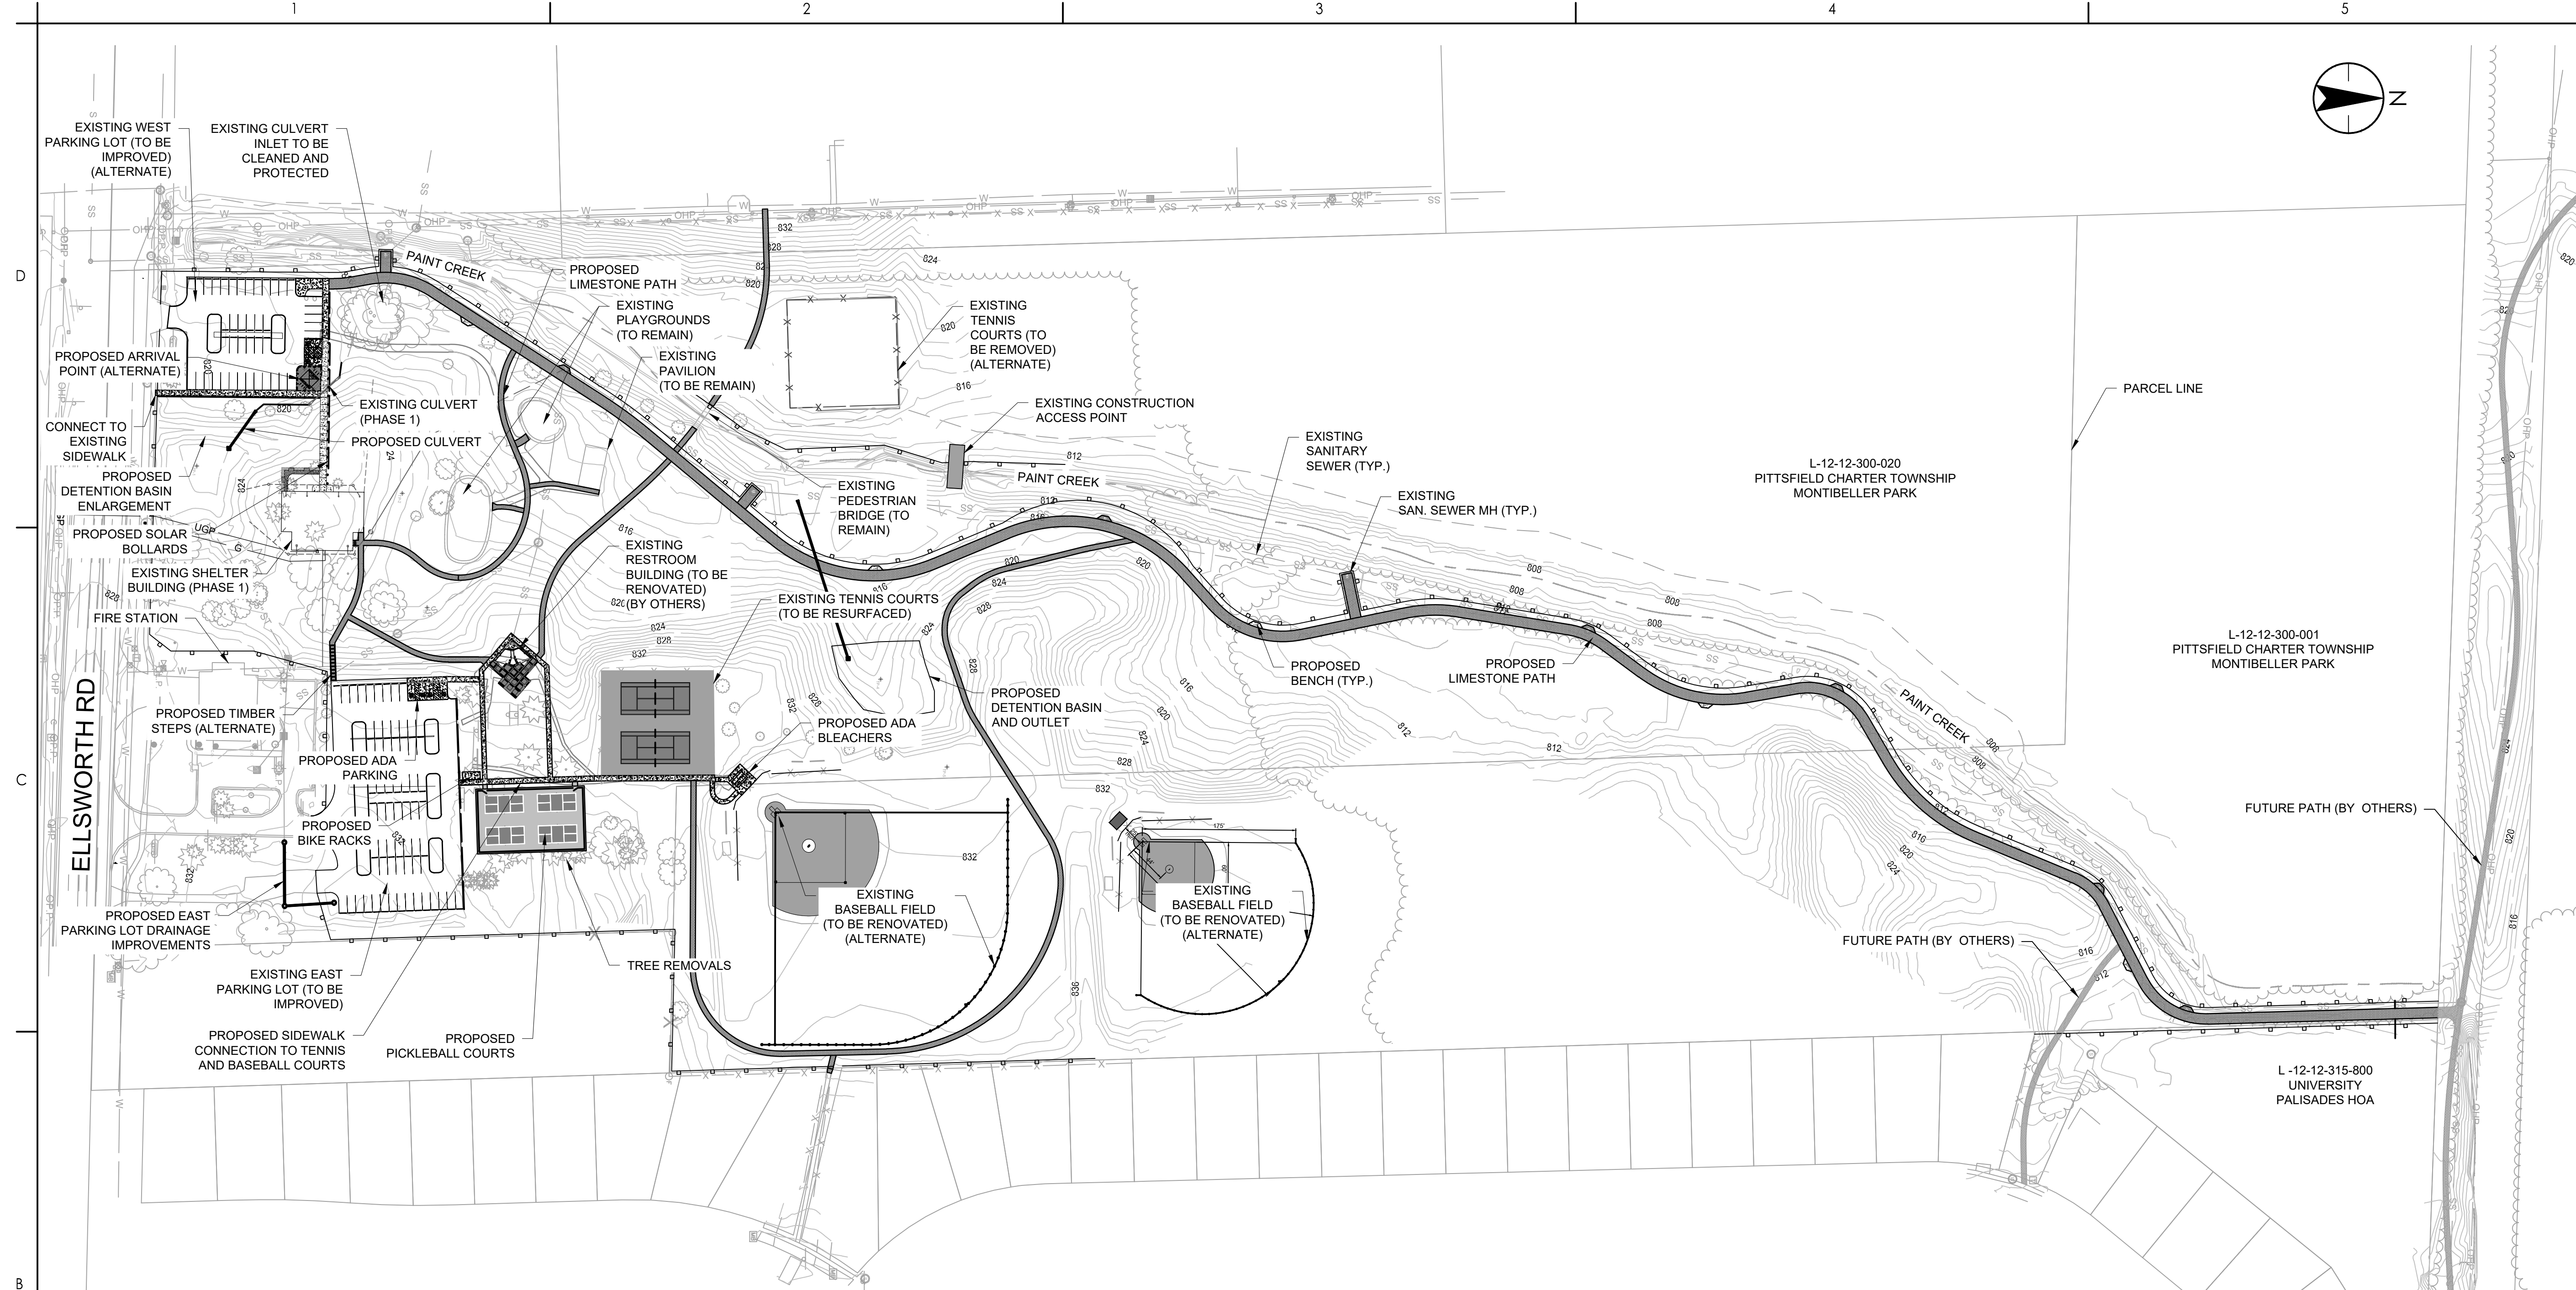

| Base Bid Quantities | | | |
|---------------------|---|----------|------|
| Item No. | Item Description | Quantity | Unit |
| 1 | Mobilization & General Conditions (5% max.) | 1 | LS |
| 2 | Soil Erosion Controls | 1 | LS |
| 3 | Audio Visual File | 1 | LS |
| 4 | Project Cleanup | 1 | LS |
| 5 | Tree Removal | 15 | EA |
| 6 | Gravel Drive Regrading/Removal (East Parking Lot) | 5000 | SYD |
| 7 | Existing HMA Removal | 856 | SYD |
| 8 | Integral Curb (West Parking Lot Sidewalk) | 267 | LF |
| 9 | 6" Straight Curb (East Parking Lot Islands) | 318 | LF |
| 10 | 6' Wide Limestone Path | 2544 | LF |
| 11 | 6' Concrete Sidewalk | 1267 | LF |
| 12 | 12' Wide Limestone Path | 2779 | LF |
| 13 | Gravel Resurfacing (East Parking Lot) | 3739 | SYD |
| 14 | ADA Parking Area (East Parking Lot) | 1 | LS |
| 15 | Wheel Stop (East Parking Lot) | 54 | EA |
| 16 | Bike Rack | 1 | EA |
| 17 | Decorative Fence | 574 | LF |
| 18 | Existing Tennis Court Resurfacing | 1800 | SYD |
| 19 | Pickleball Court | 1 | LS |
| 20 | ADA Bleachers | 1 | LS |
| 21 | 12' Wide Sanitary Manhole Access | 9 | EA |
| 22 | ADA Bench Area | 4 | EA |
| 23 | Existing Detention Basin Enlargement and Storm Outlet Structure | 1 | LS |
| 24 | Proposed Detention Basin and Storm Outlet Structure | 1 | LS |
| 25 | 15" Diameter Storm Sewer | 130 | LF |
| 26 | 48" Diameter Storm Structure with 2' Diameter Beehive Cover | 1 | EA |
| 27 | 48" Diameter Storm Structure with 2' Diameter Flat Top Cover | 2 | EA |
| 28 | Remove Bulkhead and Connect to New Storm Structure | 1 | EA |
| 29 | Turf Establishment & Landscaping | 1 | LS |
| 30 | LED Solar Bollards | 17 | EA |

| Alternate No. | Item Description | Quantity | Units |
|---|--|----------|-------|
| Alternate No. 1 (Add-on: West Parking Lot Re-surfacing) | Gravel Drive Regrading/Removal | 2128 | SYD |
| | Concrete ADA Spaces | 550 | SFT |
| | 6" Straight Curb | 246 | LF |
| | Gravel Resurface | 1875 | SYD |
| | Wheel Stop | 25 | EA |
| | Turf Establishment & Landscaping | 1 | LS |
| Alternate No. 2 (Add-on: Arrival Point) | Arrival Point Shelter | 1 | EA |
| | Integral Curb | 70 | FT |
| | Brick Pavers | 750 | SFT |
| | Bench | 4 | EA |
| | Trash Can | 2 | EA |
| | Turf Establishment & Landscaping | 1 | LS |
| Alternate No. 3 (Add-on: Baseball Field Improvements) | Bike Rack | 3 | EA |
| | 4-feet High Chain Link Homerun Fence | 490 | LF |
| | 4-feet High Chain Link Gate in Homerun Fence | 1 | EA |
| | Foul Pole | 2 | EA |
| | Infield Skin Material | 1500 | SYD |
| | 4-feet High Chain Link Homerun Fence | 136 | LF |
| | 4-feet High Chain Link Gate in Homerun Fence | 1 | EA |
| | Foul Pole | 2 | EA |
| Alternate No. 4 (Add-on: West Tennis Court Removal) | Infield Skin Material | 735 | SYD |
| | West Tennis Court HMA Removal | 1740 | SYD |
| | West Tennis Court Fence Removal | 490 | LF |
| | Turf Establishment & Landscaping | 1 | LS |
| Alternate No. 5 (Add-on: Additional Site Work) | Timber Steps | 1 | LS |
| | 6' Wide Limestone Path | 281 | LF |
| | Brick Pavers | 1147 | SFT |

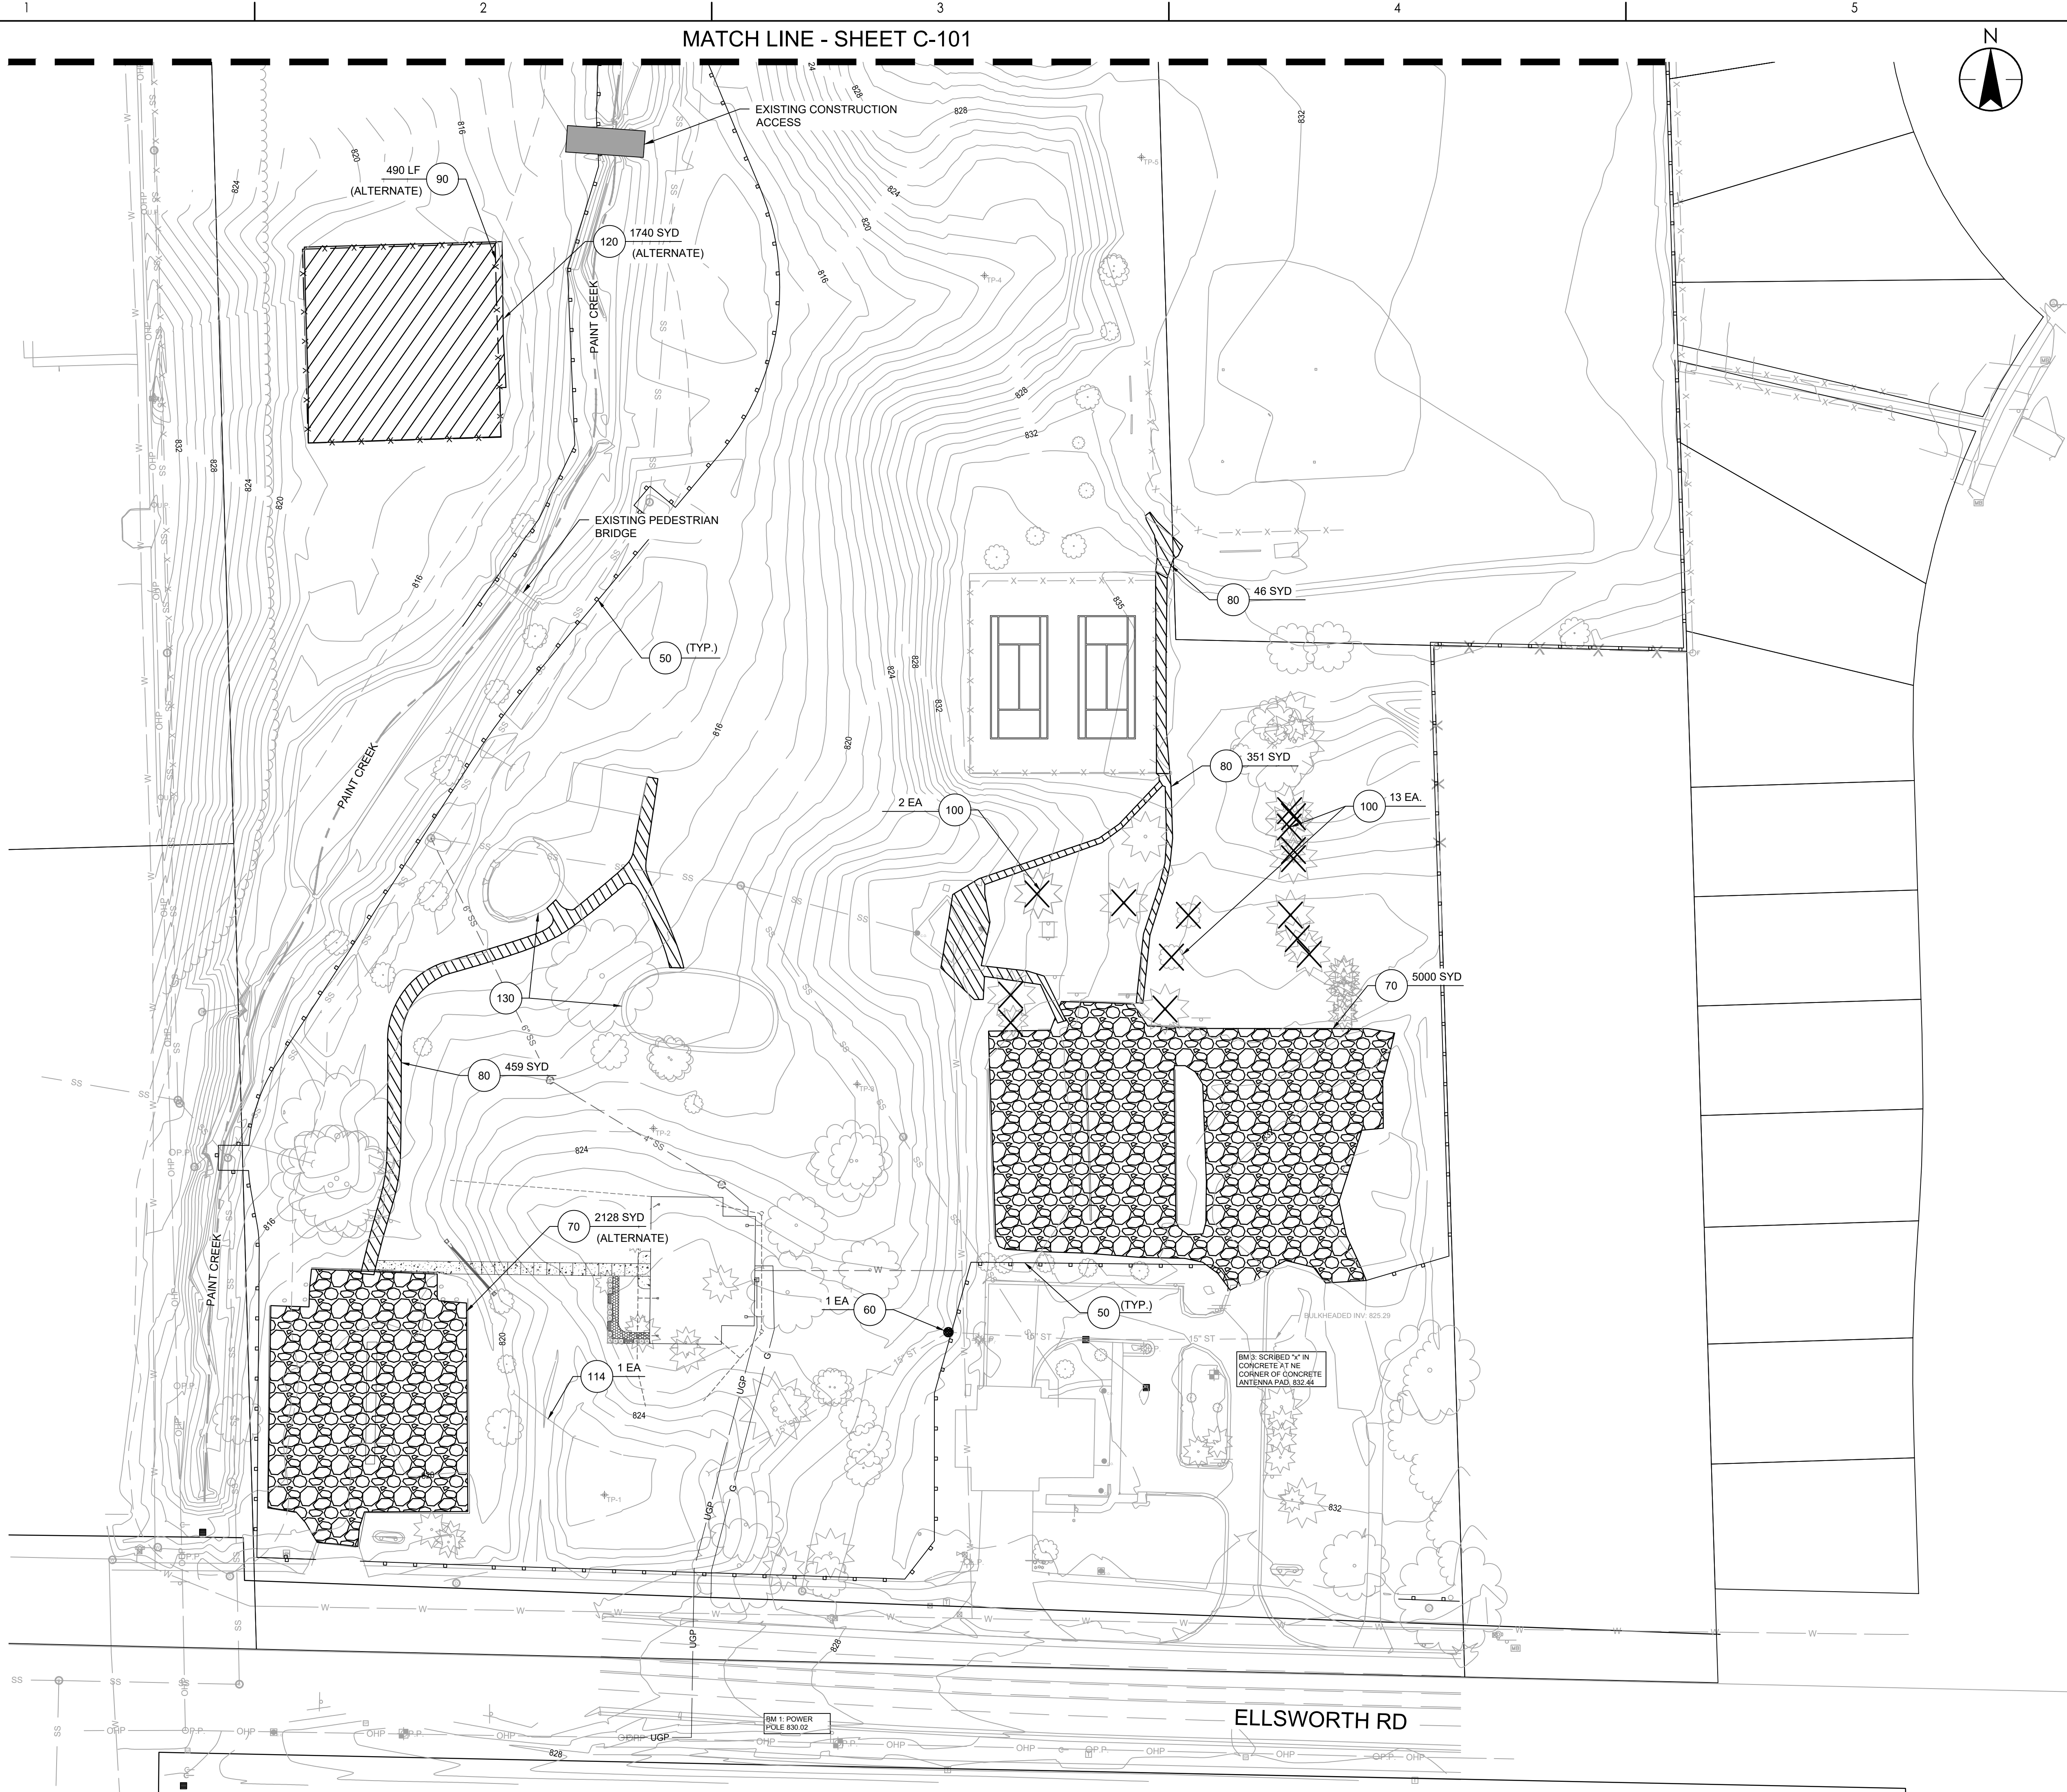

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KEY NOTES:


- 50 SILT FENCE
- 60 INLET FILTER
- 70 GRAVEL DRIVE REGRADING/REMOVAL
- 80 EXISTING HMA REMOVAL
- 90 FENCE REMOVAL
- 100 TREE REMOVAL
- 114 EXISTING 12" CULVERT REMOVAL
- 120 EXISTING TENNIS COURT AND FENCE TO BE REMOVED
- 130 PROTECT EXISTING PLAYGROUNDS

A BID SET PHASE 2



Issued

File Name: 140801C-100

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Client/Project Logo

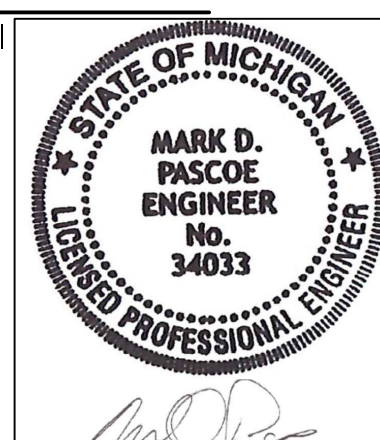

Client/Project
PITTSFIELD CHARTER TOWNSHIP

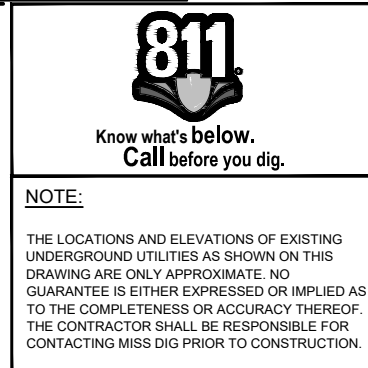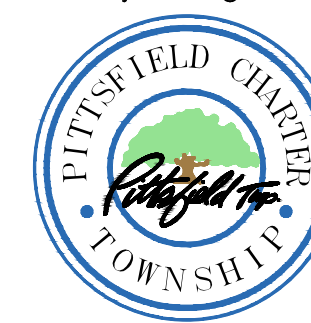MONTIBELLER PARK IMPROVEMENTS
PHASE 2

Pittsfield Township, Michigan

Title

DEMOLITION AND SOIL EROSION
CONTROL - SOUTH

Project No.
2075140801

Revision Sheet
0 05 of 24

Scale
0 50' 100'

Drawing No.
C100

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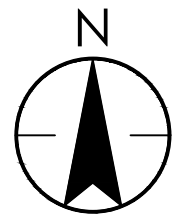
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MATCH LINE - SHEET C-102

MATCH LINE - SHEET C-100



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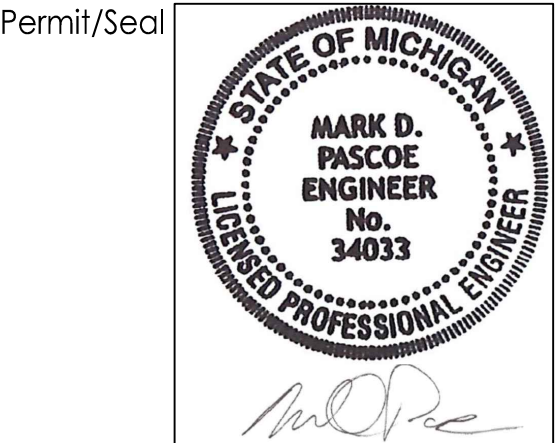
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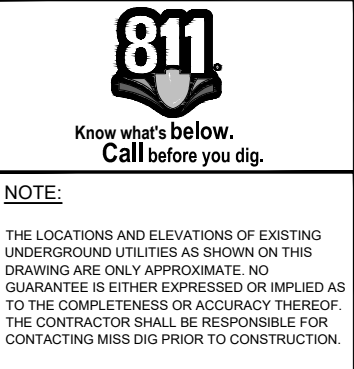
KEY NOTES:

- 50 SILT FENCE

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PITTSFIELD CHARTER TOWNSHIP

MONTIBELLER PARK IMPROVEMENTS
PHASE 2

Pittsfield Township, Michigan

Title

DEMOLITION AND SOIL EROSION
CONTROL - MIDDLE

Project No.
2075140801

Revision Sheet
0 06 of 24


Scale
0 50' 100'

Drawing No.

C101

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MATCH LINE - SHEET C-101

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PITTSFIELD CHARTER TOWNSHIP

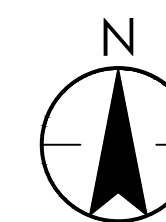MONTIBELLER PARK IMPROVEMENTS
PHASE 2

Pittsfield Township, Michigan

Title

DEMOLITION AND SOIL EROSION
CONTROL - NORTH


Project No.
2075140801

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| Revision | Sheet |
| 0 | 07 of 24 |

Scale 0 50' 100'

Drawing No.

C102

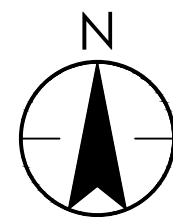

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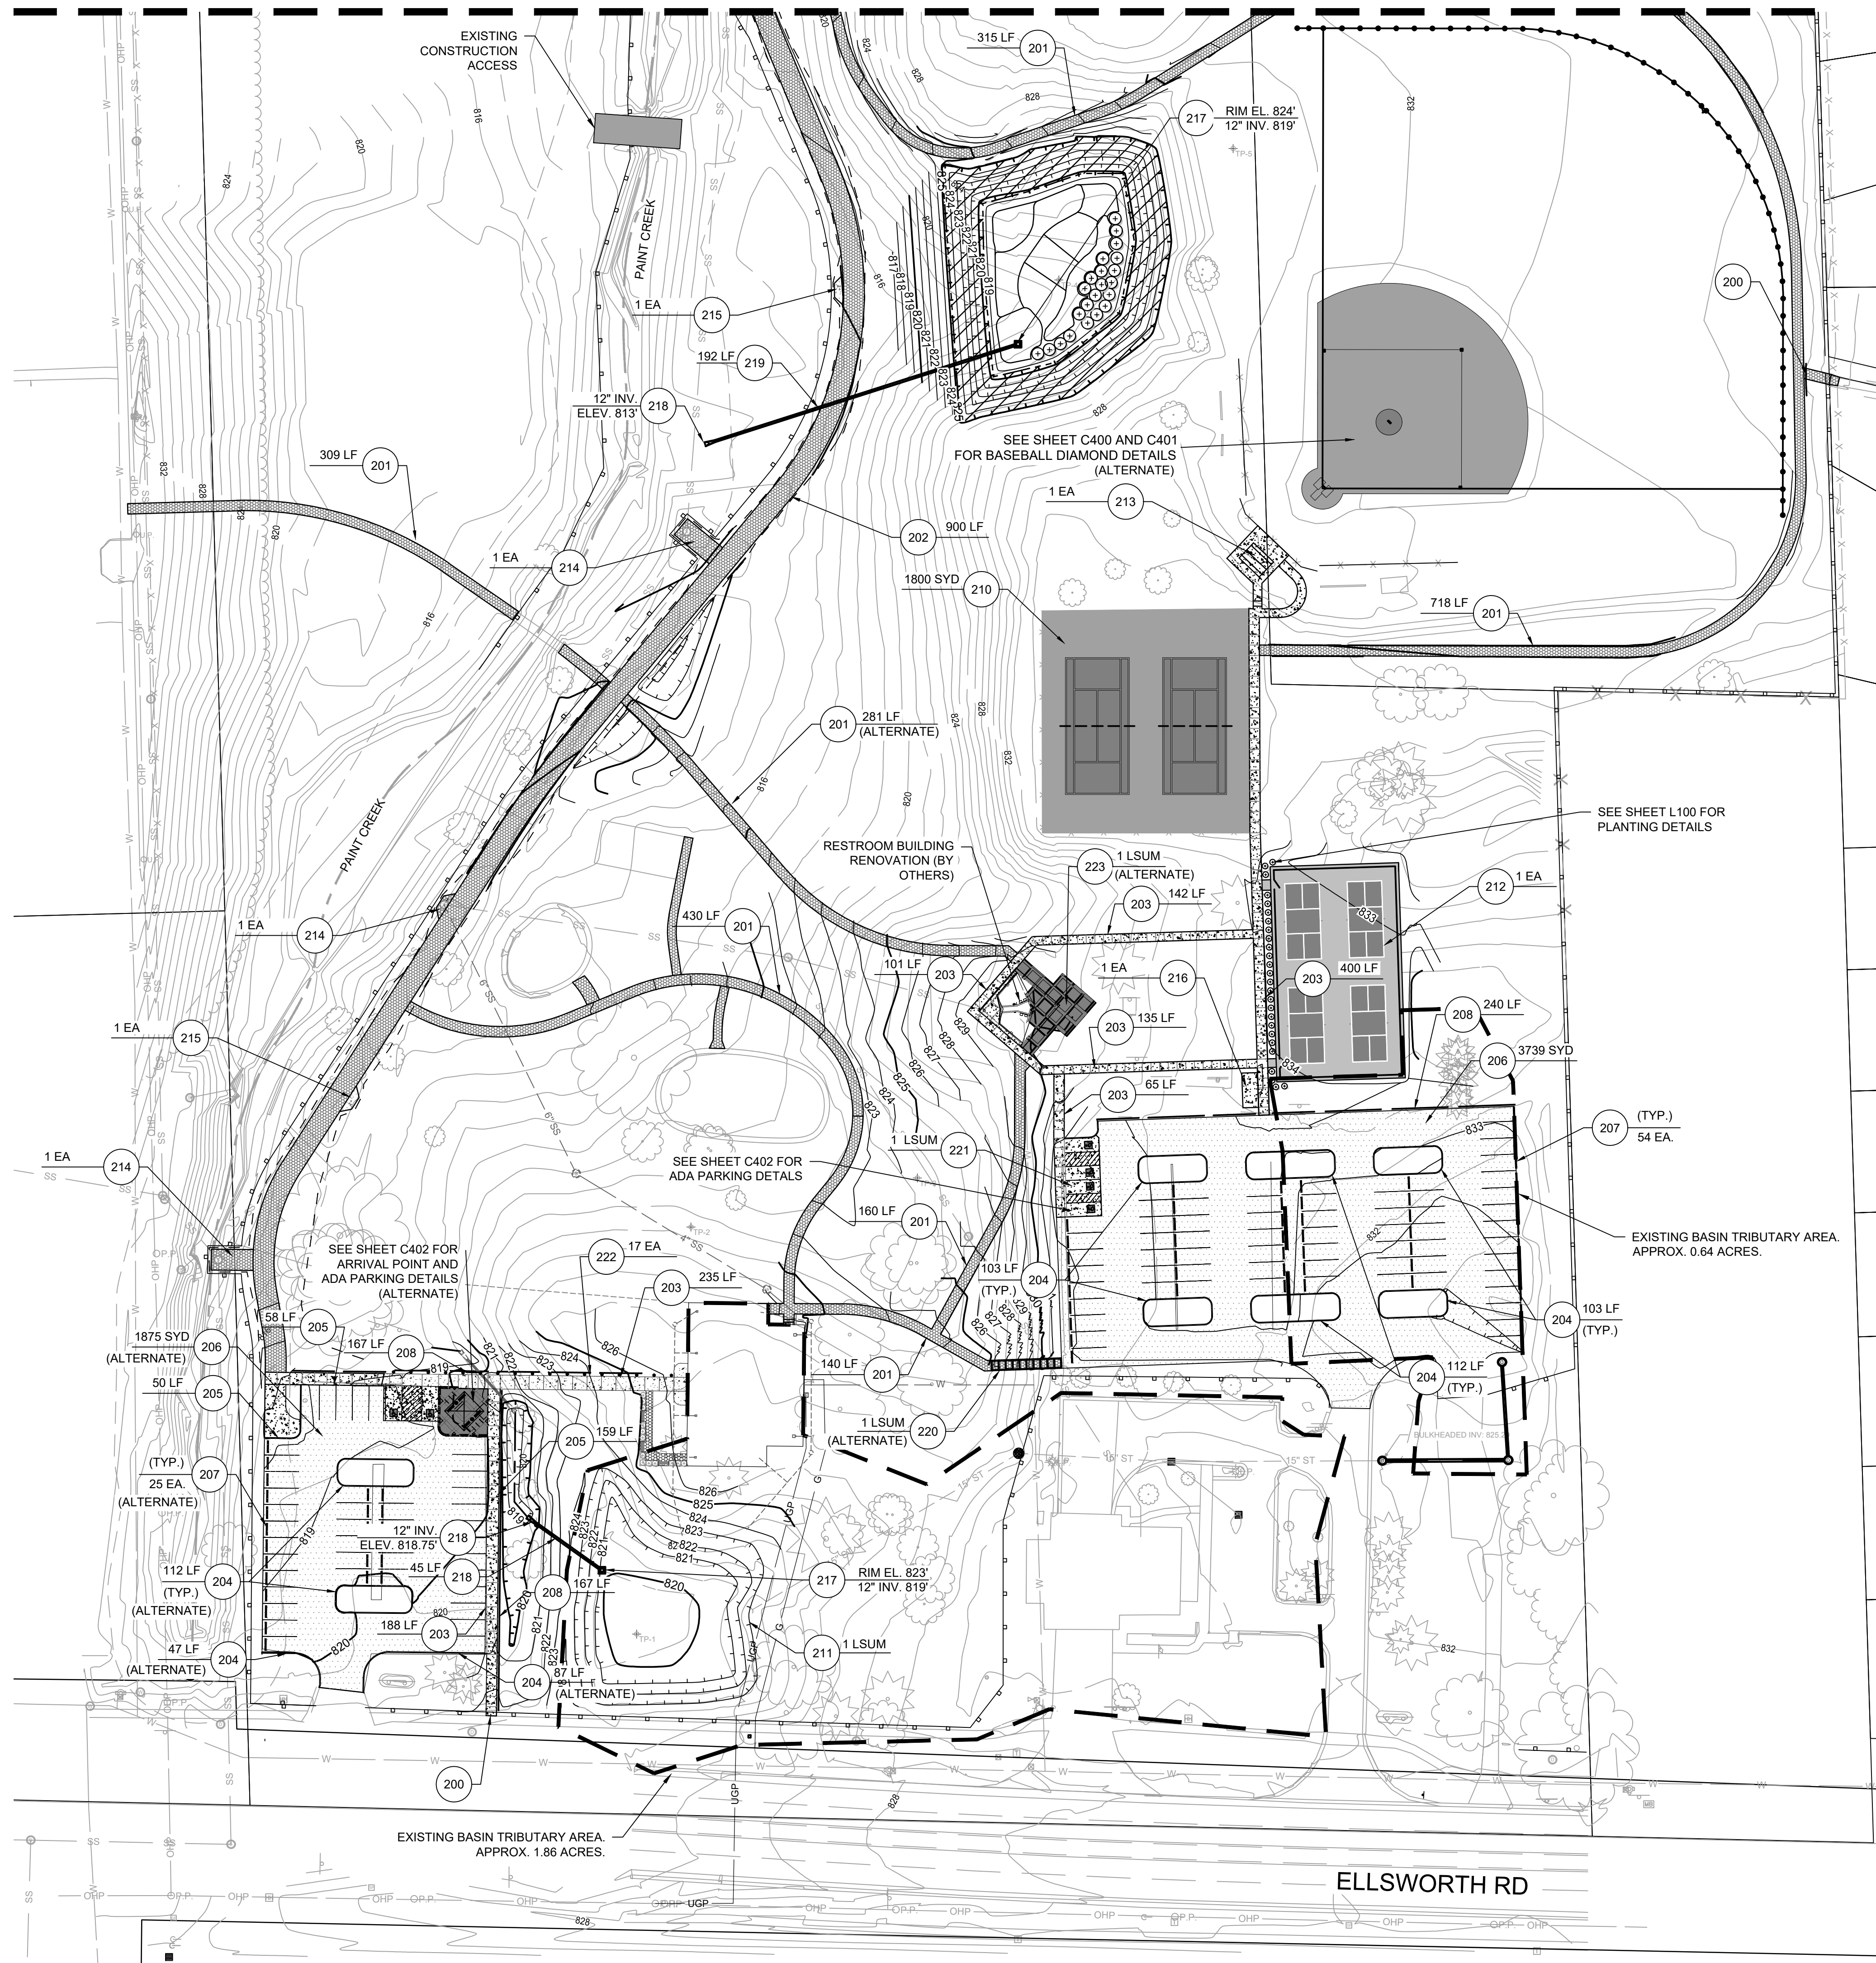
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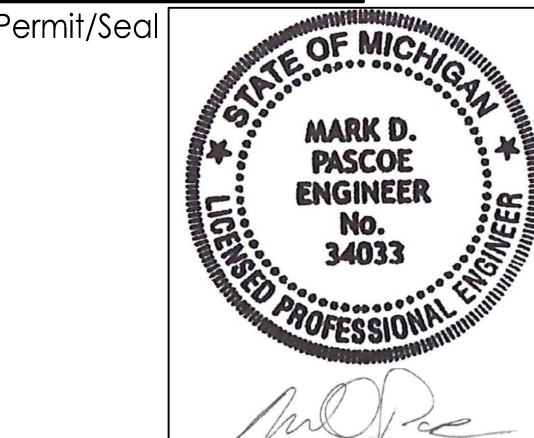
Notes

KEY NOTES:



- 200 CONNECT TO EXISTING SIDEWALK
- 201 PROPOSED 6" WIDE LIMESTONE PATH
- 202 PROPOSED 12" WIDE LIMESTONE PATH
- 203 PROPOSED 6" CONCRETE SIDEWALK
- 204 PROPOSED 6" STRAIGHT CURB
- 205 PROPOSED 6" INTEGRAL CURB
- 206 PROPOSED GRAVEL RESURFACING
- 207 PROPOSED WHEEL STOP
- 208 PROPOSED DECORATIVE FENCE
- 210 EXISTING TENNIS COURT TO BE RESURFACED
(SEE SHEET C403 FOR DETAILED PLAN)
- 211 ADJUST EXISTING UNDERDRAINS, REMOVE AND
REPLACE EXISTING CULVERT AND ENLARGE
EXISTING DETENTION BASIN
(SEE SHEET C301)
- 212 PROPOSED PICKLEBALL COURT
(SEE SHEET C403 FOR DETAILED PLAN)
- 213 ADA BLEACHERS (SEE SHEET C400)
- 214 PROPOSED 12" WIDE SANITARY MANHOLE
ACCESS
- 215 ADA BENCH AREAS (SEE SHEET C501)
- 216 PROPOSED BIKE RACKS (SEE SHEET C501)
- 217 36" DETENTION BASIN WITH RISER
(SEE DRAWING C500 FOR DETENTION
OUTLET STRUCTURE DETAIL)
- 218 12" END SECTION
- 219 12" STORM OUTLET PIPE
- 220 TIMBER STEPS (ALTERNATE)
(SEE SHEET C502 FOR DETAILS)
- 221 ADA PARKING SPACE
(SEE SHEET C402 FOR DETAILS)
- 222 PROPOSED LED SOLAR BOLLARDS
(SEE DETAIL LAYOUT SHEET C402)
- 223 BRICK PAVERS (ALTERNATE)
(SEE SHEET C402 FOR DETAILS)



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MONTIBELLER PARK IMPROVEMENTS
PHASE 2

Pittsfield Township, Michigan

Title

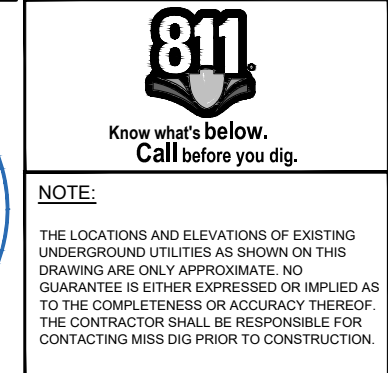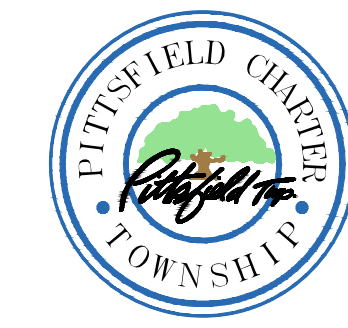
PROPOSED SITE PLAN - SOUTH

Project No.
2075140801

Revision Sheet
0 08 of 24

Scale
0 50' 100'

Drawing No.
C110

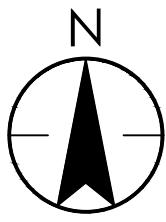

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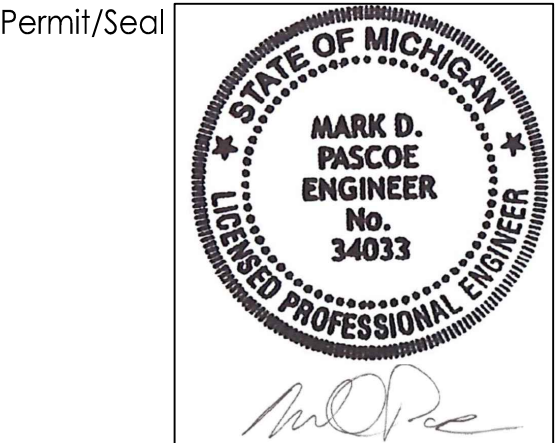
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KEY NOTES:

- 201 PROPOSED 6' WIDE LIMESTONE PATH
- 202 PROPOSED 12' WIDE LIMESTONE PATH
- 214 PROPOSED 12' WIDE SANITARY MANHOLE ACCESS
- 215 ADA BENCH AREA (SEE SHEET C501)

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| A | BID SET PHASE 2 | CRW | MDP | 2023.01.26 |
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PITTSFIELD CHARTER TOWNSHIP

MONTIBELLER PARK IMPROVEMENTS
PHASE 2

Pittsfield Township, Michigan

Title

PROPOSED SITE PLAN - MIDDLE

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| Project No. | 2075140801 | Scale | 0 50' 100' |
| Revision | Sheet | Drawing No. | |
| 0 | 09 of 24 | | |

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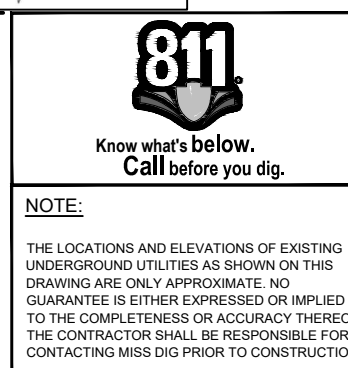
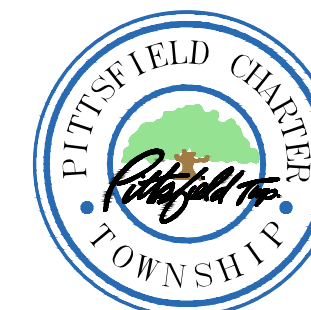
KEY NOTES:

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PITTSFIELD CHARTER TOWNSHIP

MONTIBELLER PARK IMPROVEMENTS
PHASE 2

Pittsfield Township, Michigan

Title

PROPOSED SITE PLAN - NORTH

Project No.
207514080


Revision Sheet
0 10 of 24

Scale
0 50' 100'

Drawing No.

C112

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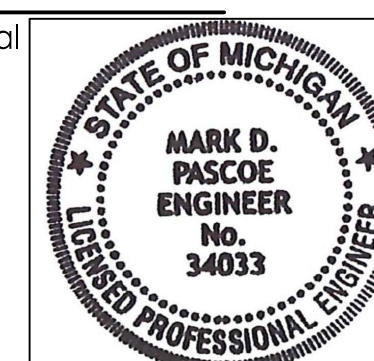
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Notes
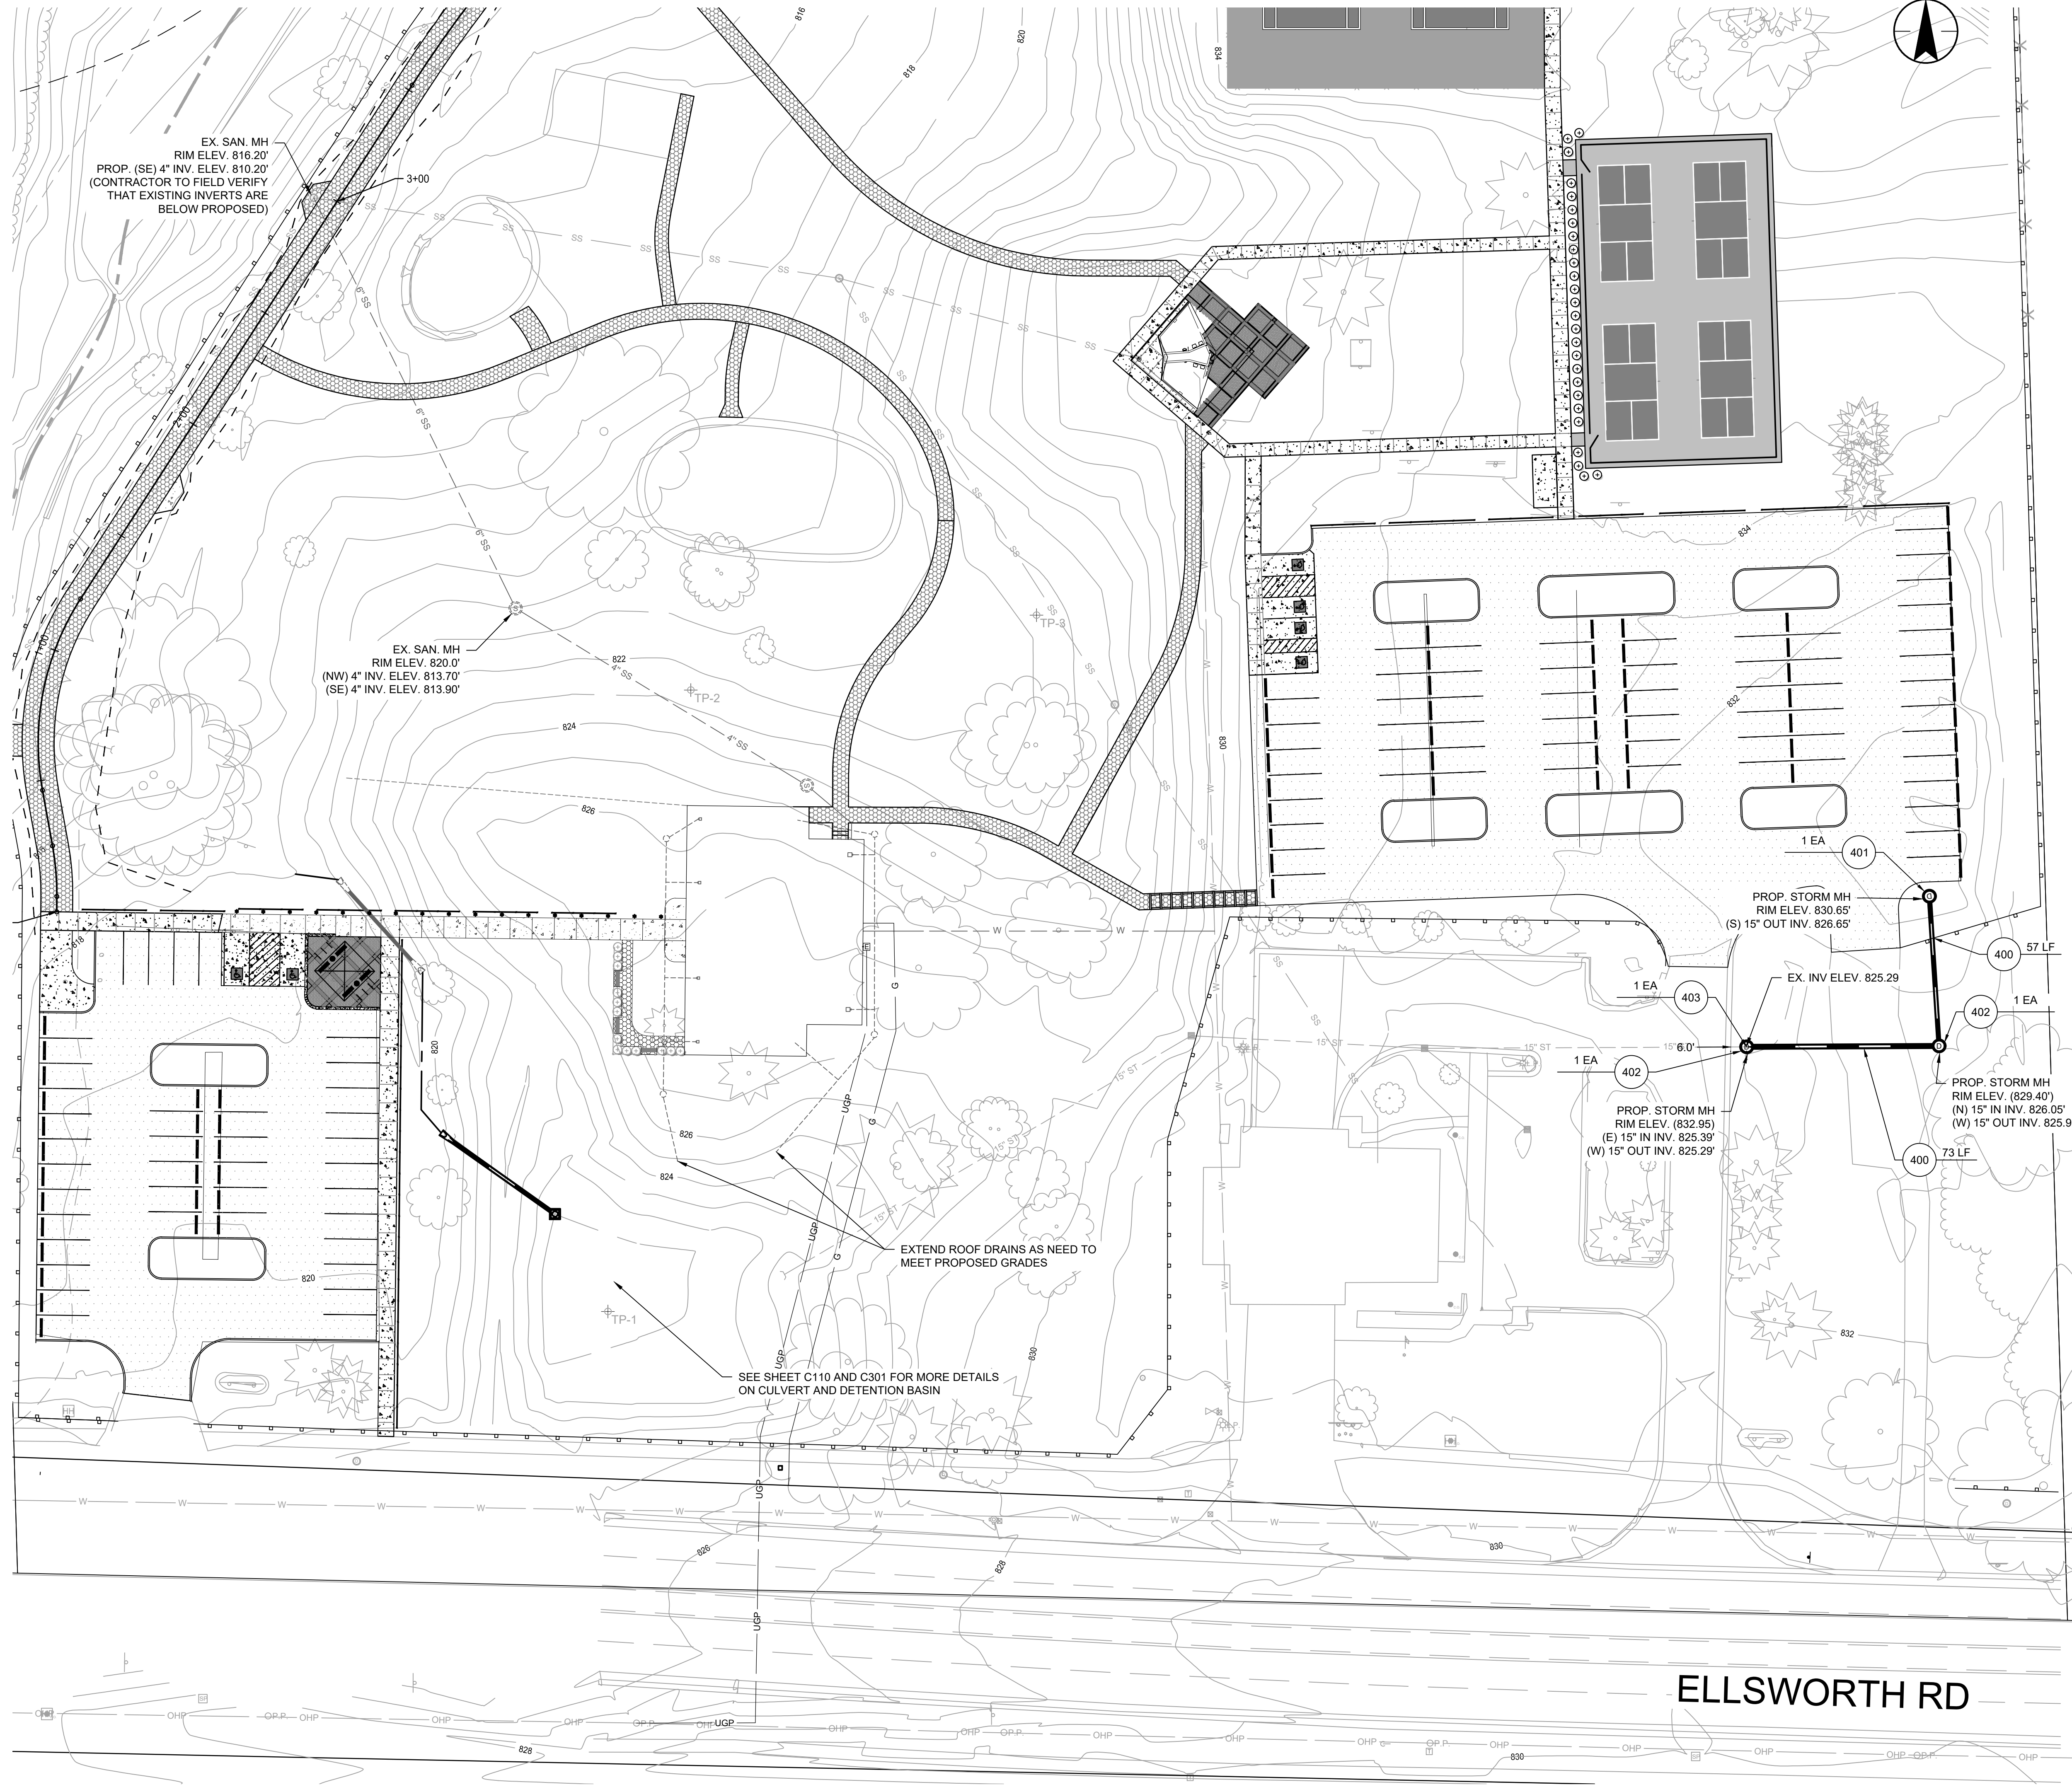
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|---|------------------------|------|-------|------------|
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| | Issued | By | Appd | YYYY.MM.DD |
| | File Name: 140801C-300 | JDA | AMS | MDP |
| | | Dwn. | Dsan. | Chkd. |
| | | | | 2020.03.10 |
| | | | | YYYY.MM.DD |

Permit/Seal



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Know what's below.
Call before you dig.

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Client/Project

PITTSFIELD CHARTER TOWNSHIP

MONTIBELLER PARK IMPROVEMENTS
PHASE 2

Pittsfield Township, Michigan

Title

OVERALL GRADING PLAN

Project No.
207514080

Revision Sheet
0 12 of 24


Scale
0 100' 200'

Drawing No.

C300

V:\2020\140801C-301\140801C-301.dwg (Drawing) 2/14/2020 2:28:27 PM

| | | | | |
|--|---|--------|---------------|------------|
| I. Total Volume of Detention Area: 100 Year storm | | | | |
| 1) | Developed Area Contributing Runoff (a) | = | | 2.49 acres |
| 2) | Maximum Allowable Runoff, Qa = Qa = a * 0.15 cfs/acre | = | | 0.37 cfs |
| 3) | Total Storage Required (based on added volume for building) | = | | 20,998 cf |
| II. Storage volume to detain "first flush" runoff | | | | |
| volume of 0.5 inch rain over entire watershed. | | | | |
| Volume = 1815 x acreage x relative imperv. factor | Volume | = | | 3,041 cf |
| III. Storage volume to control "bankfull" flood (1.5 year storm/24 hr. event) | | | | |
| Volume = 8170 x acreage x relative imperv. factor (i Volume | | = | | 12,747 cf |
| IV. Storage Elevations | | | | |
| | Xo = | 820.00 | Xif = | 820.70 |
| | Xbf = | 822.16 | X100 = | 822.98 |
| Outlet Control Structure | | | | |
| 1. Outlet pipe sizing: (10 year un-restricted) | | | | |
| Use 12-inch pipe at min. slope | | | | |
| 2. Standpipe outlet holes sizing - "first flush" runoff | | | | |
| Qff = Vff / 24 hrs / 3600 sec | Qff = | 0.035 | cfs | |
| h = 2/3 x (Xif - Xo) | h = | 0.467 | ft | |
| A = Qff / (.62 x sqrt(2*32.2*h)) | A = | 0.010 | sf | |
| The area of a 3/4" orifice | | 0.0031 | sf | |
| Number of orifice holes | = | 3 | holes at elev | 820.00 |
| 3. Standpipe outlet holes sizing - "Bankfull flood" discharge | | | | |
| Bankfull should discharge within 36 to 48 hours | | | | |
| Release from first flush holes only | | | | |
| Q = a x .62 x sqrt(2x32.2x3h) = | Q = | 0.056 | cfs | |
| Tbft with first flush holes only = | | 63 | hrs | |
| Add holes at to decrease storage time | | | | |
| The first flush volume will discharge in | | 27 | hrs | |
| The volume between the Bankfull elevation and the First Flush Elevation | | | | |
| Vbft-Vff = | | 9,706 | cf | |
| should discharge (target 42 hour discharge time) in | | 15.0 | hrs | |
| Qbf = | | 0.18 | cfs | |
| A = area of bankfull holes | | 0.024 | sf | |
| The area of a 1" orifice | | 0.0055 | sf | |
| Number of orifice holes | = | 4 | holes at elev | 820.70 |
| Bankfull storage time check = | | 43 | hrs | |
| 4. Standpipe outlet holes sizing - "100-yr flood" discharge | | | | |
| Q100 = Qa | Q100 = | 0.370 | cfs | |
| Release from above holes | | | | |
| hff = (X100 - Xo) | hff = | 2.98 | ft | |
| hbf = (X100 - Xif) | hbf = | 2.280 | ft | |
| Release from above holes | | | | |
| Q = a x .62 x sqrt(2x32.2xhff) + a x .62 x sqrt(2x32.2xhbf) = | Q = | 0.245 | cfs | |
| Remaining flow | Q100-Q = | 0.125 | cfs | |
| A = Q100 / (.62 x sqrt(2*32.2*h)) | A = | 0.028 | sf | |
| The area of a 1 1/2" orifice | | 0.0123 | sf | |
| Number of orifice holes | = | 2 | holes at elev | 822.16 |
| 100-year storage time check = | | 49 | hrs | |
| Allowable flow rate check = | | 0.36 | cfs | < 0.37 cfs |
| Qff + Qbf + ((0.62)(X100)(2*g*h100)^0.50) = | | | | |

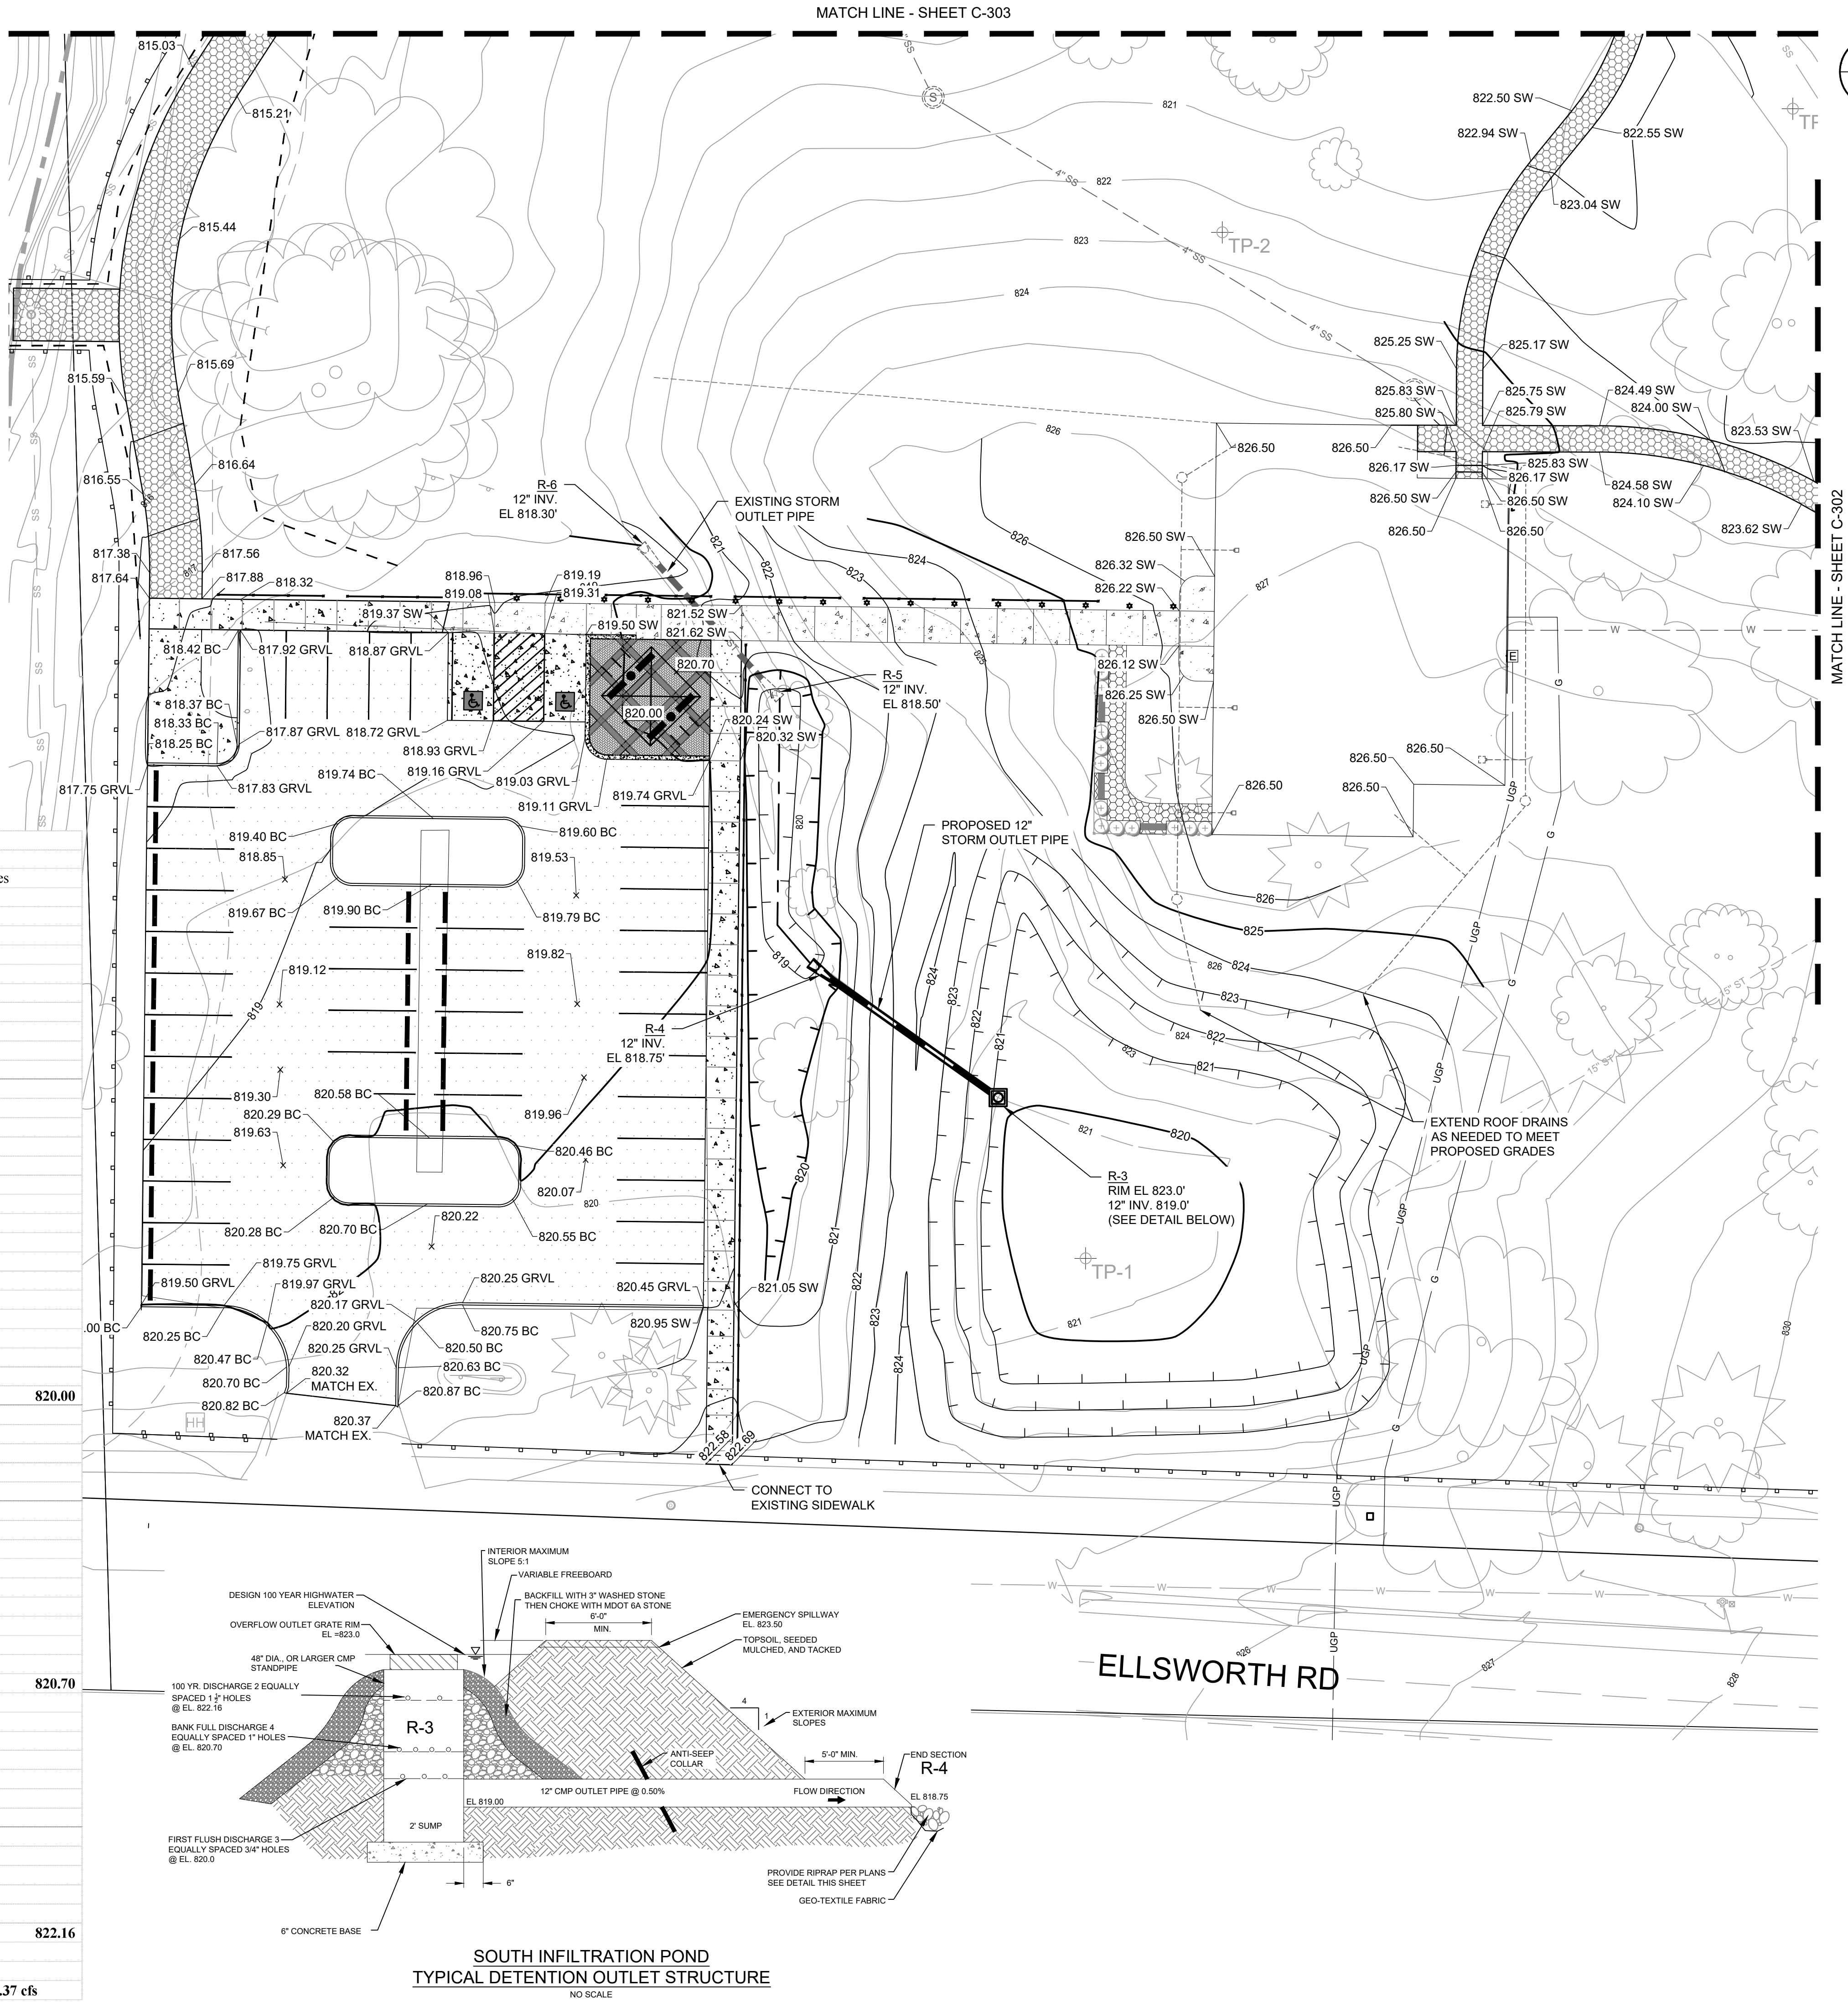

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Ann Arbor MI 48108-2771
Tel: (734) 761-1010
www.stantec.com


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Client/Project
PITTSFIELD CHARTER TOWNSHIP

MONTIBELLER PARK IMPROVEMENTS
PHASE 2

Pittsfield Township, Michigan

Title

PROPOSED GRADING PLAN I

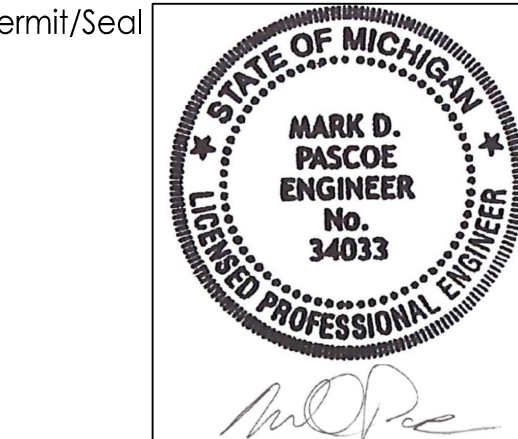
Project No.
2075140801

Revision Sheet
0 13 of 24

Scale
0 30' 60'

Drawing No.

C301

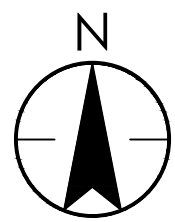

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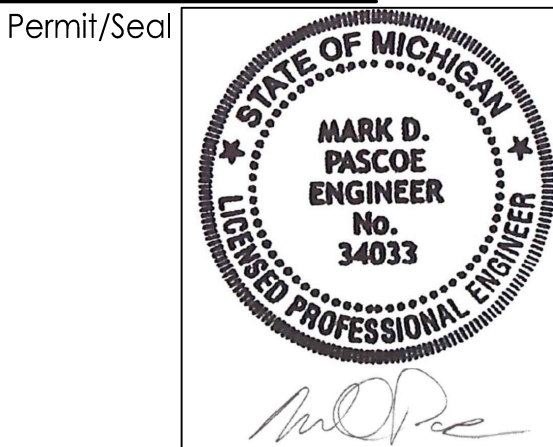
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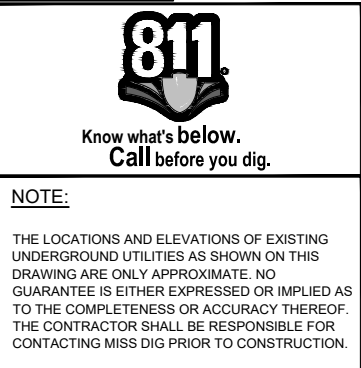
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Notes

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|------------------------|--|------|-------|------------|
| A - BID SET PHASE 2 | | CRW | MDP | 2023.01.26 |
| Issued | | By | Appd | YYYY.MM.DD |
| File Name: 140801C-302 | | JDA | AHS | MDP |
| | | Dwn. | Dsgn. | Chkd. |
| | | | | YYYY.MM.DD |



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PITTSFIELD CHARTER TOWNSHIP


MONTIBELLER PARK IMPROVEMENTS
PHASE 2

Pittsfield Township, Michigan

Title

PROPOSED GRADING PLAN II

| | |
|------------------------------|---------------------|
| Project No. 2075140801 | Scale 0 30' 60' |
| Revision Sheet 0 14 of 24 | Drawing No. C302 |

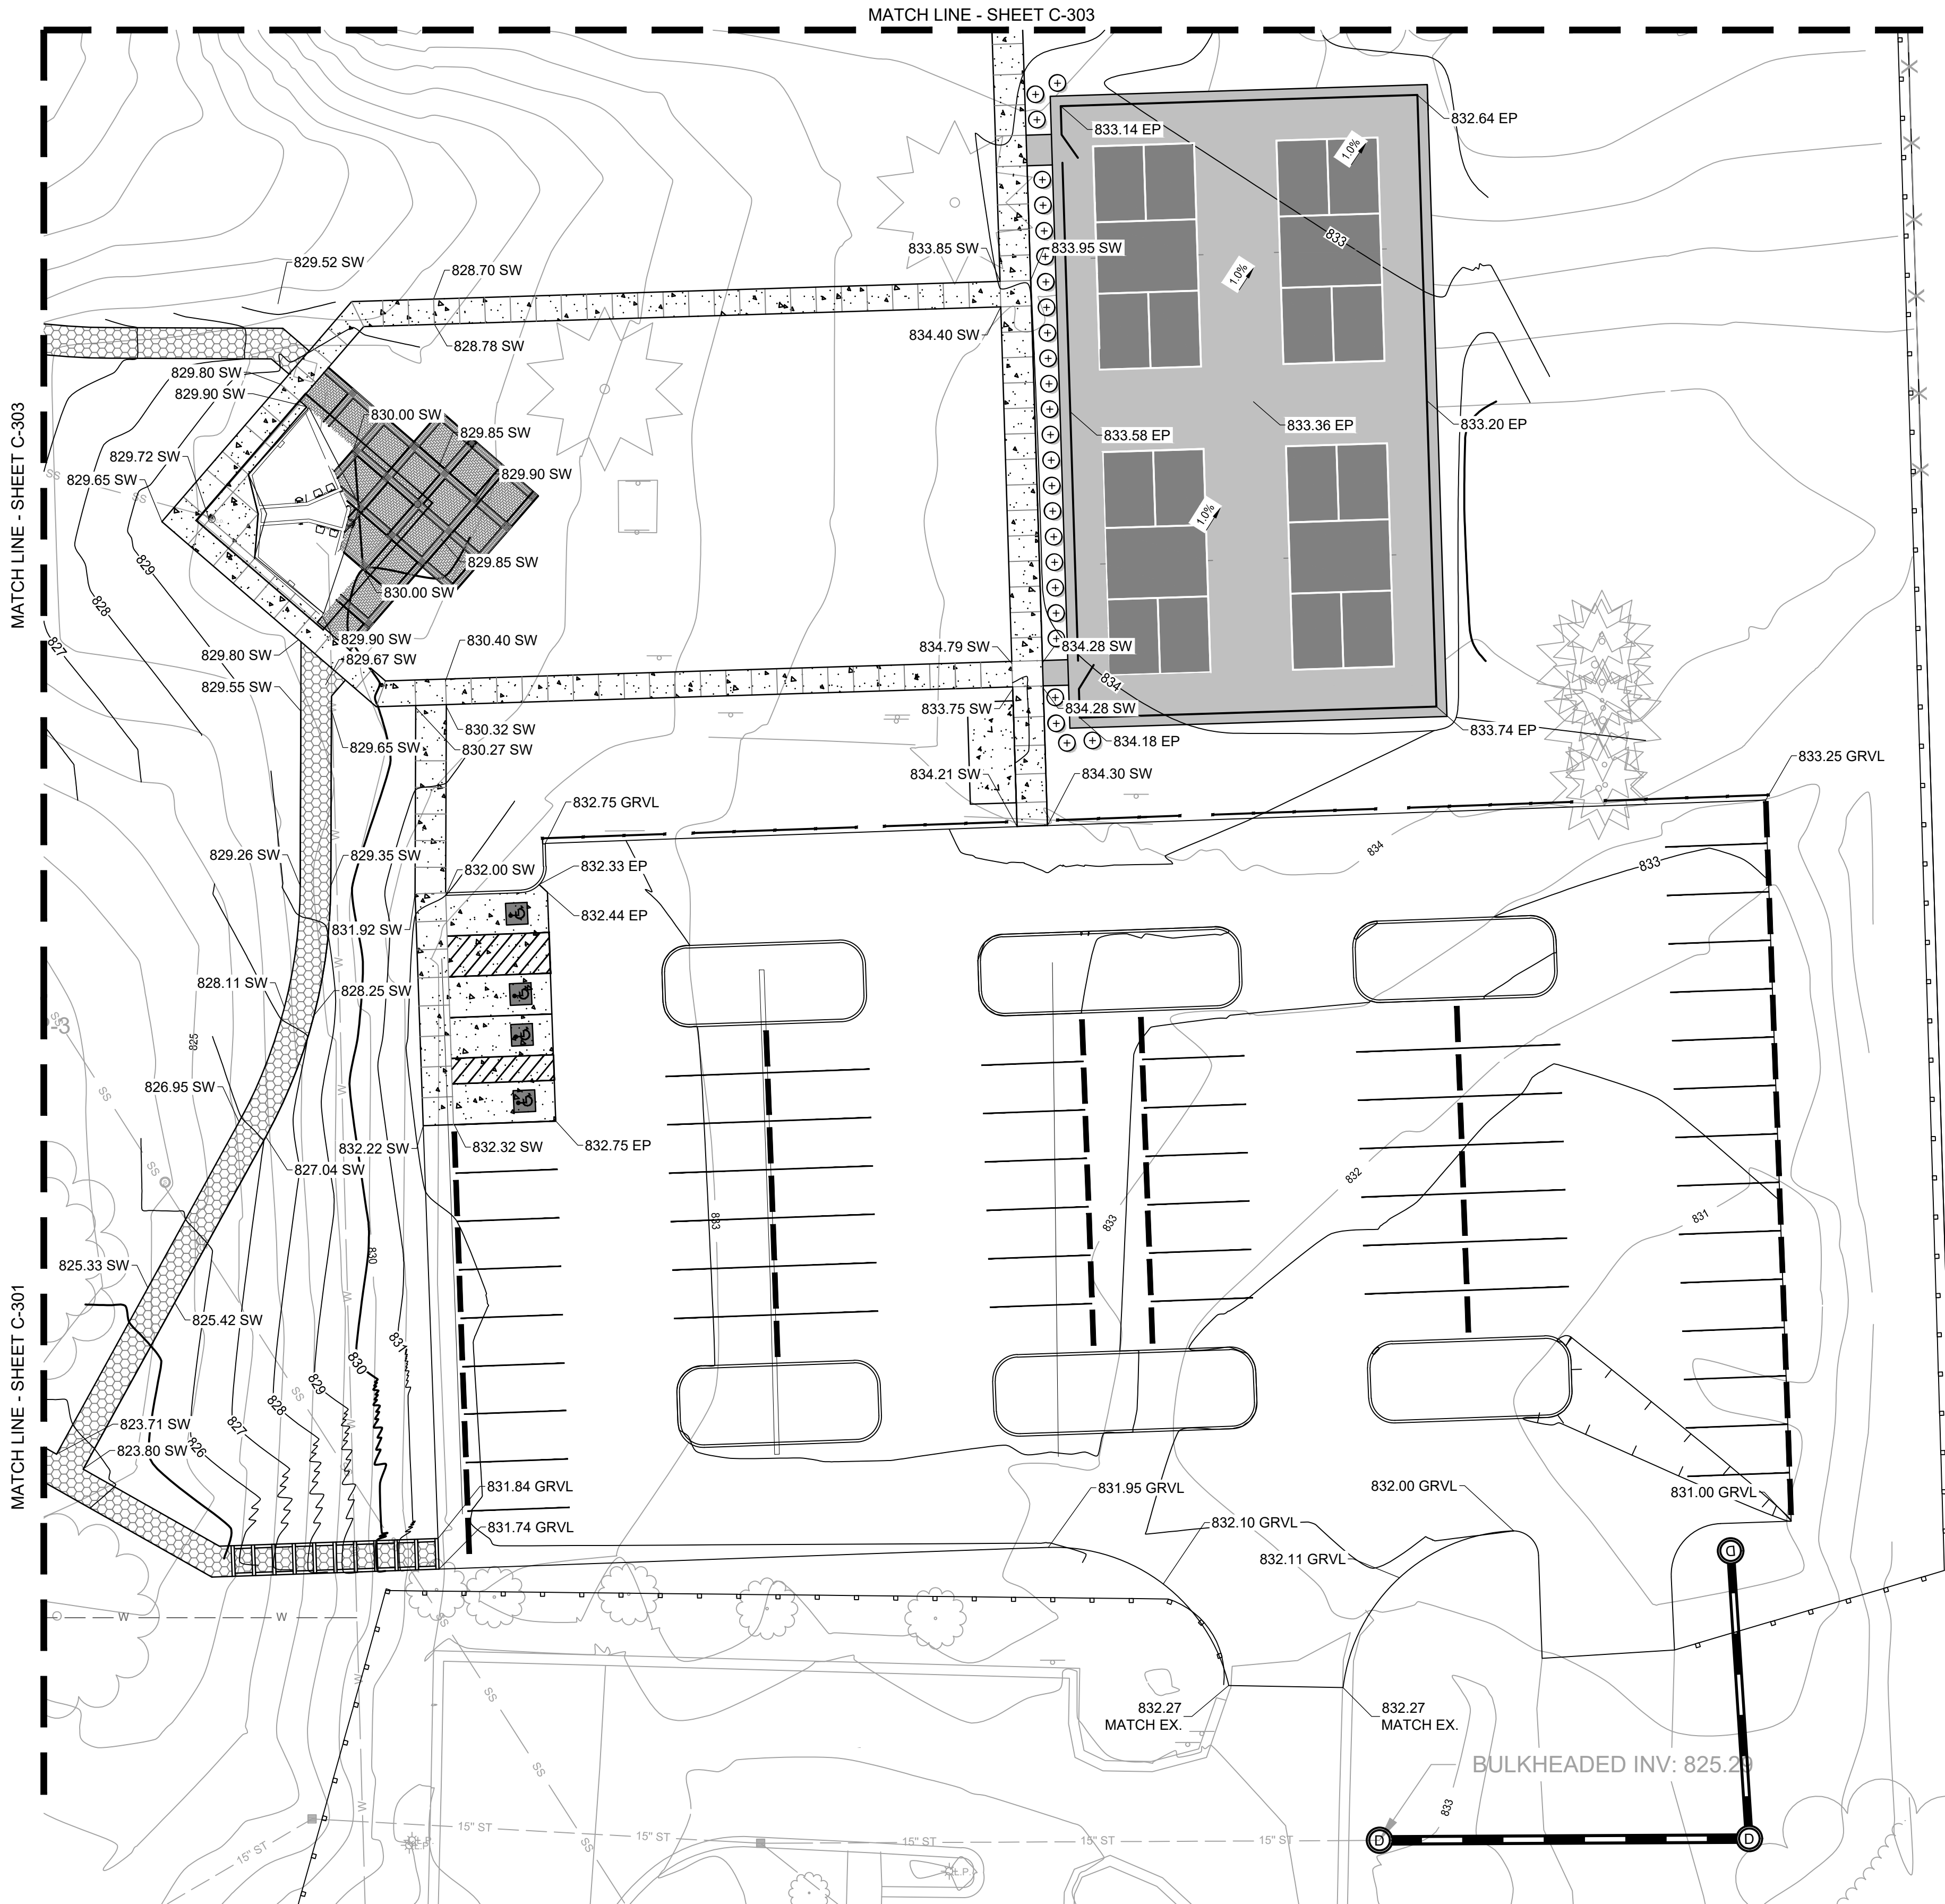



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Notes



| DETENTION VOLUME (NORTH INFILTRATION POND) | | | | |
|--|-----------|----------------|-------------|--------------|
| Volume Provided | | | | |
| Elevation (ft) | Area (sf) | Avg. Area (sf) | Height (ft) | Volume (cft) |
| 819.0 | 6850 | | | 0 |
| | | 7533 | 1.0 | |
| 820.0 | 8216 | | | 7533 |
| | | 8958 | 1.0 | |
| 821.0 | 9700 | | | 16491 |
| | | 10502 | 1.0 | |
| 822.0 | 11303 | | | 26993 |
| | | 12167 | 1.0 | |
| 823.0 | 13030 | | | 39160 |
| | | 13955 | 1.0 | |
| 824.0 | 14880 | | | 53115 |

| | | | | |
|---|------------------------|------|-------|------------|
| A | BID SET PHASE 2 | CRW | MDP | 2023.01.26 |
| | Issued | By | Appd | YYYY.MM.DD |
| | File Name: 140801C-303 | JDA | AMS | 2020.03.10 |
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| | | | | YYYY.MM.DD |



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Pittsfield Township, Michigan

PROPOSED GRADING PLAN III AND DETENTION POND PLAN

Project No. 2075140801

Scale 0 30' 60'

| | | |
|----------|----------|-------------|
| Revision | Sheet | Drawing No. |
| 0 | 15 of 24 | C303 |

C303

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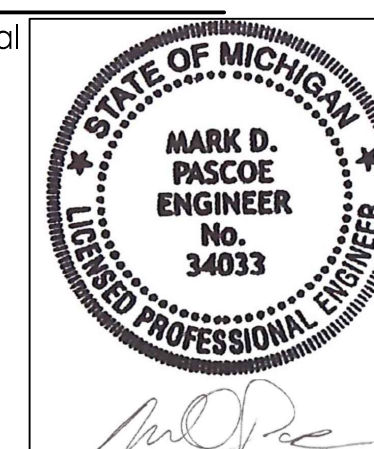
Consultant

KEY NOTES:


50 SILT FENCE

| | | | | |
|------------------------|------|-------|-------|------------|
| File Name: 140801C-304 | JDA | AMS | MDP | 2020.03.10 |
| | Dwn. | Dsgn. | Chkd. | YYYY.MM.DD |

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PITTSFIELD CHARTER TOWNSHIP

MONTIBELLER PARK IMPROVEMENTS
PHASE 2

Pittsfield Township, Michigan

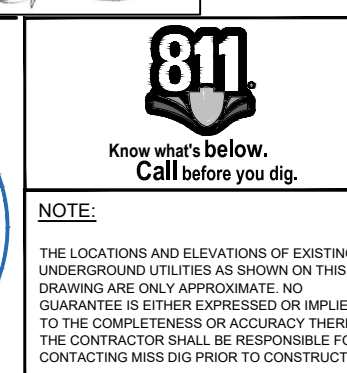Title

PROPOSED GRADING PLAN IV

Project No.
207514080

| | |
|----------|----------|
| Revision | Sheet |
| 0 | 16 of 24 |

Scale
0 30' 60'

Drawing No.

C304

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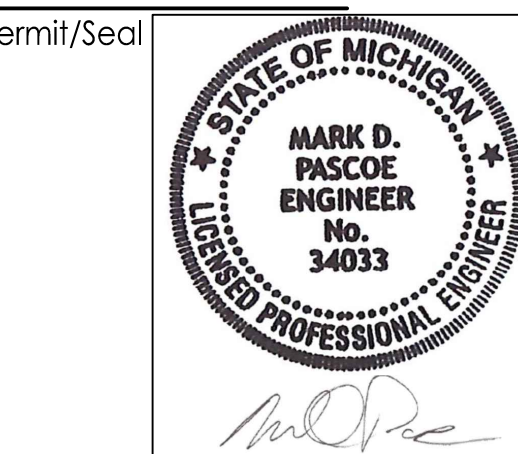
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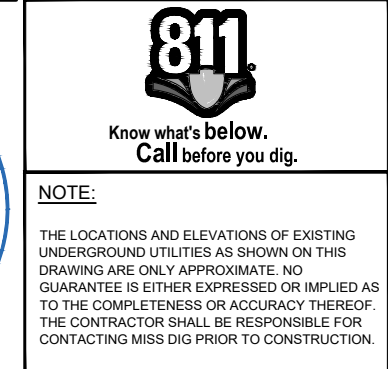
KEY NOTES:

- 213 ADA BLEACHERS
- 300 4 FEET HIGH CHAIN LINK HOMERUN FENCE
SEE DETAIL SHEET C-401
- 301 4 FEET HIGH CHAIN LINK GATE IN HOMERUN FENCE
SEE DETAIL SHEET C-401
- 302 FOUL POLE
SEE DETAIL SHEET C-401
- 303 EXISTING BACKSTOP FENCE TO REMAIN
- 304 INFIELD SKIN MATERIAL

| | | | | |
|------------|-----------------|------|-------|------------|
| A | BID SET PHASE 2 | CRW | MDP | 2023.01.26 |
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PITTSFIELD CHARTER TOWNSHIP

MONTIBELLER PARK IMPROVEMENTS
PHASE 2

Pittsfield Township, Michigan

Title

DETAILED SITE PLAN - SOUTH FIELD
(ALTERNATE)

Project No.
2075140801

Revision Sheet
0 17 of 24

Scale
0 20' 40'


Drawing No.

C400

BALLFIELD DIMENSIONS

- PONY: AGES 13-14
80 FEET BASE LINES
54 FEET PITCHER MOUND TO HOME PLATE
310 FEET HOMERUN FENCE - POCKET
265 FEET HOMERUN FENCE - BASE LINES
40 FEET HOME PLATE TO BACKSTOP
80 FEET RADIUS ON INFIELD SKIN,
RUBBER RADIUS POINT

TP-5

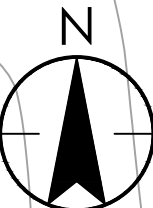

302 1 EA

300 490 LF

1 EA

301

304 1500 SYD

310'


80'

265' to HR Fence

1 EA


302

SOUTH FIELD DETAIL
(ALTERNATE)

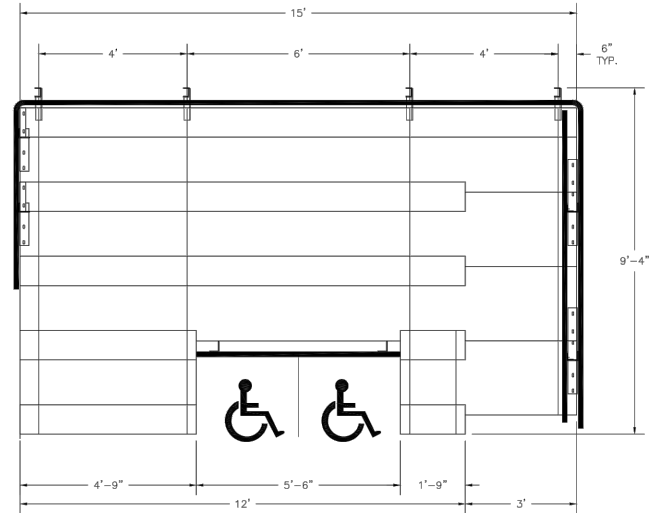

PROPOSED ADA BLEACHER DETAIL


| SECTION | GROSS | ACTUAL NO. OF | NET |
|----------------------------|--------|---------------|---------|
| LENGTH | NO. TO | RIGHTS | SEATING |
| 15' | 10.00 | 10.00 | 100 |
| 12' | 8.00 | 8.00 | 80 |
| 14.75' | 3.17 | 3.00 | 2 |
| 1.75' | 1.17 | 1.00 | 10 |
| TOTAL NET SEATING CAPACITY | | | 192 |

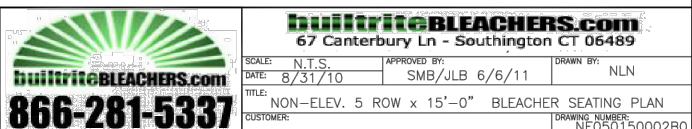



KEY NOTES:

- 300 4 FEET HIGH CHAIN LINK HOMERUN FENCE
SEE DETAIL THIS SHEET
- 301 4 FEET HIGH CHAIN LINK GATE IN HOMERUN FENCE
SEE DETAIL THIS SHEET
- 302 FOUL POLE
SEE DETAIL THIS SHEET
- 303 EXISTING BACKSTOP FENCE TO REMAIN
- 304 INFIELD SKIN MATERIAL
- 305 BLEACHER ON CONCRETE PAD

| | | | |
|------------------------|------|-------|------------|
| A. BID SET PHASE 2 | CRW | MDP | 2023.01.26 |
| Issued | By | Appd | YYYY.MM.DD |
| File Name: 140801C-401 | JDA | AHS | MDP |
| | Dwn. | Dsgn. | Chkd. |
| | | | YYYY.MM.DD |

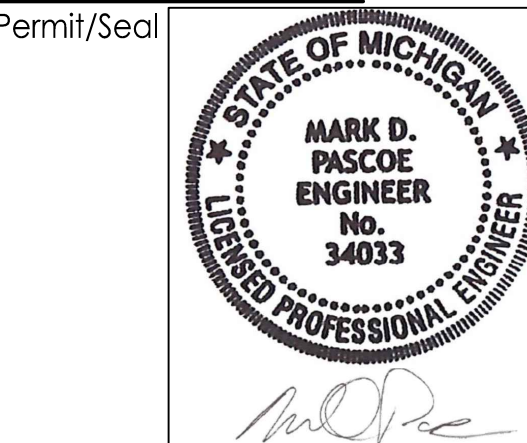

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PITTSFIELD CHARTER TOWNSHIP

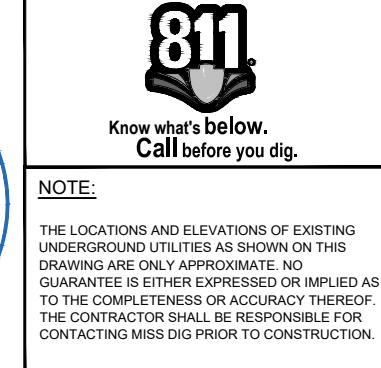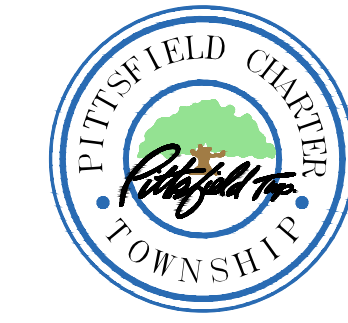MONTIBELLER PARK IMPROVEMENTS
PHASE 2

Pittsfield Township, Michigan

Title

DETAILED SITE PLAN - NORTH FIELD
(ALTERNATE)

Project No.
2075140801

Revision Sheet
0 18 of 24

Scale
0 20' 40'

Drawing No.

C401

SECTION 02821 - CHAIN-LINK FENCES

PART 1 - GENERAL

1.1 RELATED DOCUMENTS

A. Drawings and general provisions of the Contract, including General and Special Conditions and Division 1 Specification Sections, apply to this Section.

1.2 SUMMARY

A. This Section includes the following:

- Color coated chain link fencing and accessories
- Related Sections include the following:

- Concrete Specifications

1.3 DEFINITIONS

A. CLFMI: Chain Link Fence Manufacturers Institute.

B. Zn-5-Al-MM Alloy: Zinc-5 percent aluminum-mischmetal alloy.

1.4 SUBMITTALS

A. Product Data: Material descriptions, construction details, dimensions of individual components and profiles, and finishes for the following: Fence and Accessories.

B. Shop Drawings: Show locations of fence, posts, rails, and tension wires and details of extended posts, extension arms, or other operation, hardware, and accessories. Indicate materials, dimensions, sizes, weights, and finishes of components. Include plans, elevations, sections, and other required installation and operational clearances, and details of post anchorage and attachment and bracing.

C. Samples: Color selection and Color coating finish method.

1.5 QUALITY ASSURANCE

A. Installer Qualifications: An experienced installer who has completed chain-link fences and gates similar in material, design, and extent to those indicated for this Project and whose work has resulted in construction with a record of successful in-service performance.

B. Source Limitations for Chain-Link Fences and Gates: Obtain each color, grade, finish, type, and variety of component for chain-link fences and gates from one source with resources to provide chain-link fences and gates of consistent quality in appearance and physical properties.

1.6 PROJECT CONDITIONS

A. Field Measurements: Verify layout information for chain-link fences and gates shown on Drawings in relation to surrounding elements. Verify dimensions by field measurements.

PART 2 - PRODUCTS

2.1 CHAIN-LINK FENCE AND GATE FABRIC

A. Steel Chain-Link Fence Fabric: Height indicated on Drawings. Provide fabric fabricated in one-piece widths for fencing in height of 12 feet and less. Comply with CLFMI's "Product Manual" and with requirements indicated below:

- Mesh and Wire Size: 2-inch mesh, 0.120-(9 gage)inch diameter.
- Color coat using PVC elastomer coating, powder coating or equal. Submit coating specifications with shop drawings for review and approval.
 - Color: Black
 - Selvaige: Knuckled at top and bottom

2.2 FRAMING

A. Round Steel Pipe: Standard weight, Schedule 40, galvanized steel pipe complying with ASTM F 1083. Comply with ASTM F 1043, Material Design Group IA, external and internal coating Type A, consisting of not less than 1.8-oz./sq. ft. zinc, and the following strength and stiffness requirements:

A. Post Brace Rails: Match top rail for coating and strength and stiffness requirements. Provide brace rail with truss rod assembly for each gate, end, and pull post. Provide two brace rails extending in opposing directions, each with truss rod assembly, for each corner post and for pull posts. Provide rail ends and clamps for attaching rails to posts.

B. Top Rails: Fabricate top rail from lengths 21 feet or longer, with swaged-end or fabricated for expansion-type coupling, forming a continuous rail along top of chain-link fabric.

C. Intermediate Rails: Match top rail for coating and strength and stiffness requirements.

2.3 TENSION WIRE

A. General: Provide horizontal tension wire at the following locations:

- Location: Extended along bottom of fence fabric when no bottom rail is specified.

B. Metallic-Coated Steel Wire: 0.177-inch diameter, marcelled tension wire complying with ASTM A 824 and the following:

- Coating: Type I, aluminum coated (aluminized).

2.4 FITTINGS

A. General: Provide fittings for a complete fence installation, including special fittings for corners. Comply with ASTM F 626.

B. Post and Line Caps: Mill-finished aluminum. Provide watertight closure cap for each

- Provide line post caps with loop to receive tension wire or top rail.

C. Rail and Brace Ends: Mill-finished aluminum. Provide rail ends or other means for attaching rails securely to each gate, corner, pull, and end post.

D. Rail Fittings: Provide the following:

- Top Rail Sleeves: Mill-finished aluminum not less than 6 inches long.
- Tension and Brace Bands: Mill-finished aluminum.

F. Tension Bars: Mill-finished aluminum, length not less than 2 inches shorter than full height of chain-link fabric. Provide one bar for each gate and end post, and two for each corner and pull post. Provide one bar integrally woven into post.

G. Truss Rod Assemblies: Mill-finished aluminum rod and turnbuckle or other means of adjustment.

H. Tie Wires, Clips, and Fasteners: Provide the following types according to ASTM F 626:

- Standard Round Wire Ties: For attaching chain-link fabric to posts, rails, and frames, complying with the following:
 - Aluminum: ASTM B 211; alloy 1350-H19; 0.148-inch-diameter, mill-finished wire.
 - Round Wire Hog Rings: Hot-dip galvanized steel or aluminum for attaching chain-link fabric to horizontal tension wires.

2.5 COLOR COATED ACCESSORIES

A. Coat all fence accessories (framing, tension wires, gates, and fittings) with color coated finish to match fence fabric.

PART 3 - EXECUTION

3.1 EXAMINATION

A. Examine areas and conditions, with Installer present, for compliance with requirements for site clearing, earthwork, pavement work, and other conditions affecting performance.


- Do not begin installation before final grading is completed, unless otherwise permitted by owner.

B. Proceed with installation only after unsatisfactory conditions have been corrected.


3.2 PREPARATION

A. Stake locations of fence lines every 200', and gates and terminal posts and angle points. Do not exceed intervals of 500 feet or line of sight between stakes. Indicate locations of utilities, lawn sprinkler system, underground structures, storm pipes, benchmarks, and property monuments.


Do not install fence until shop drawings and staked fence locations have been approved by the Township and all necessary permits have been acquired.

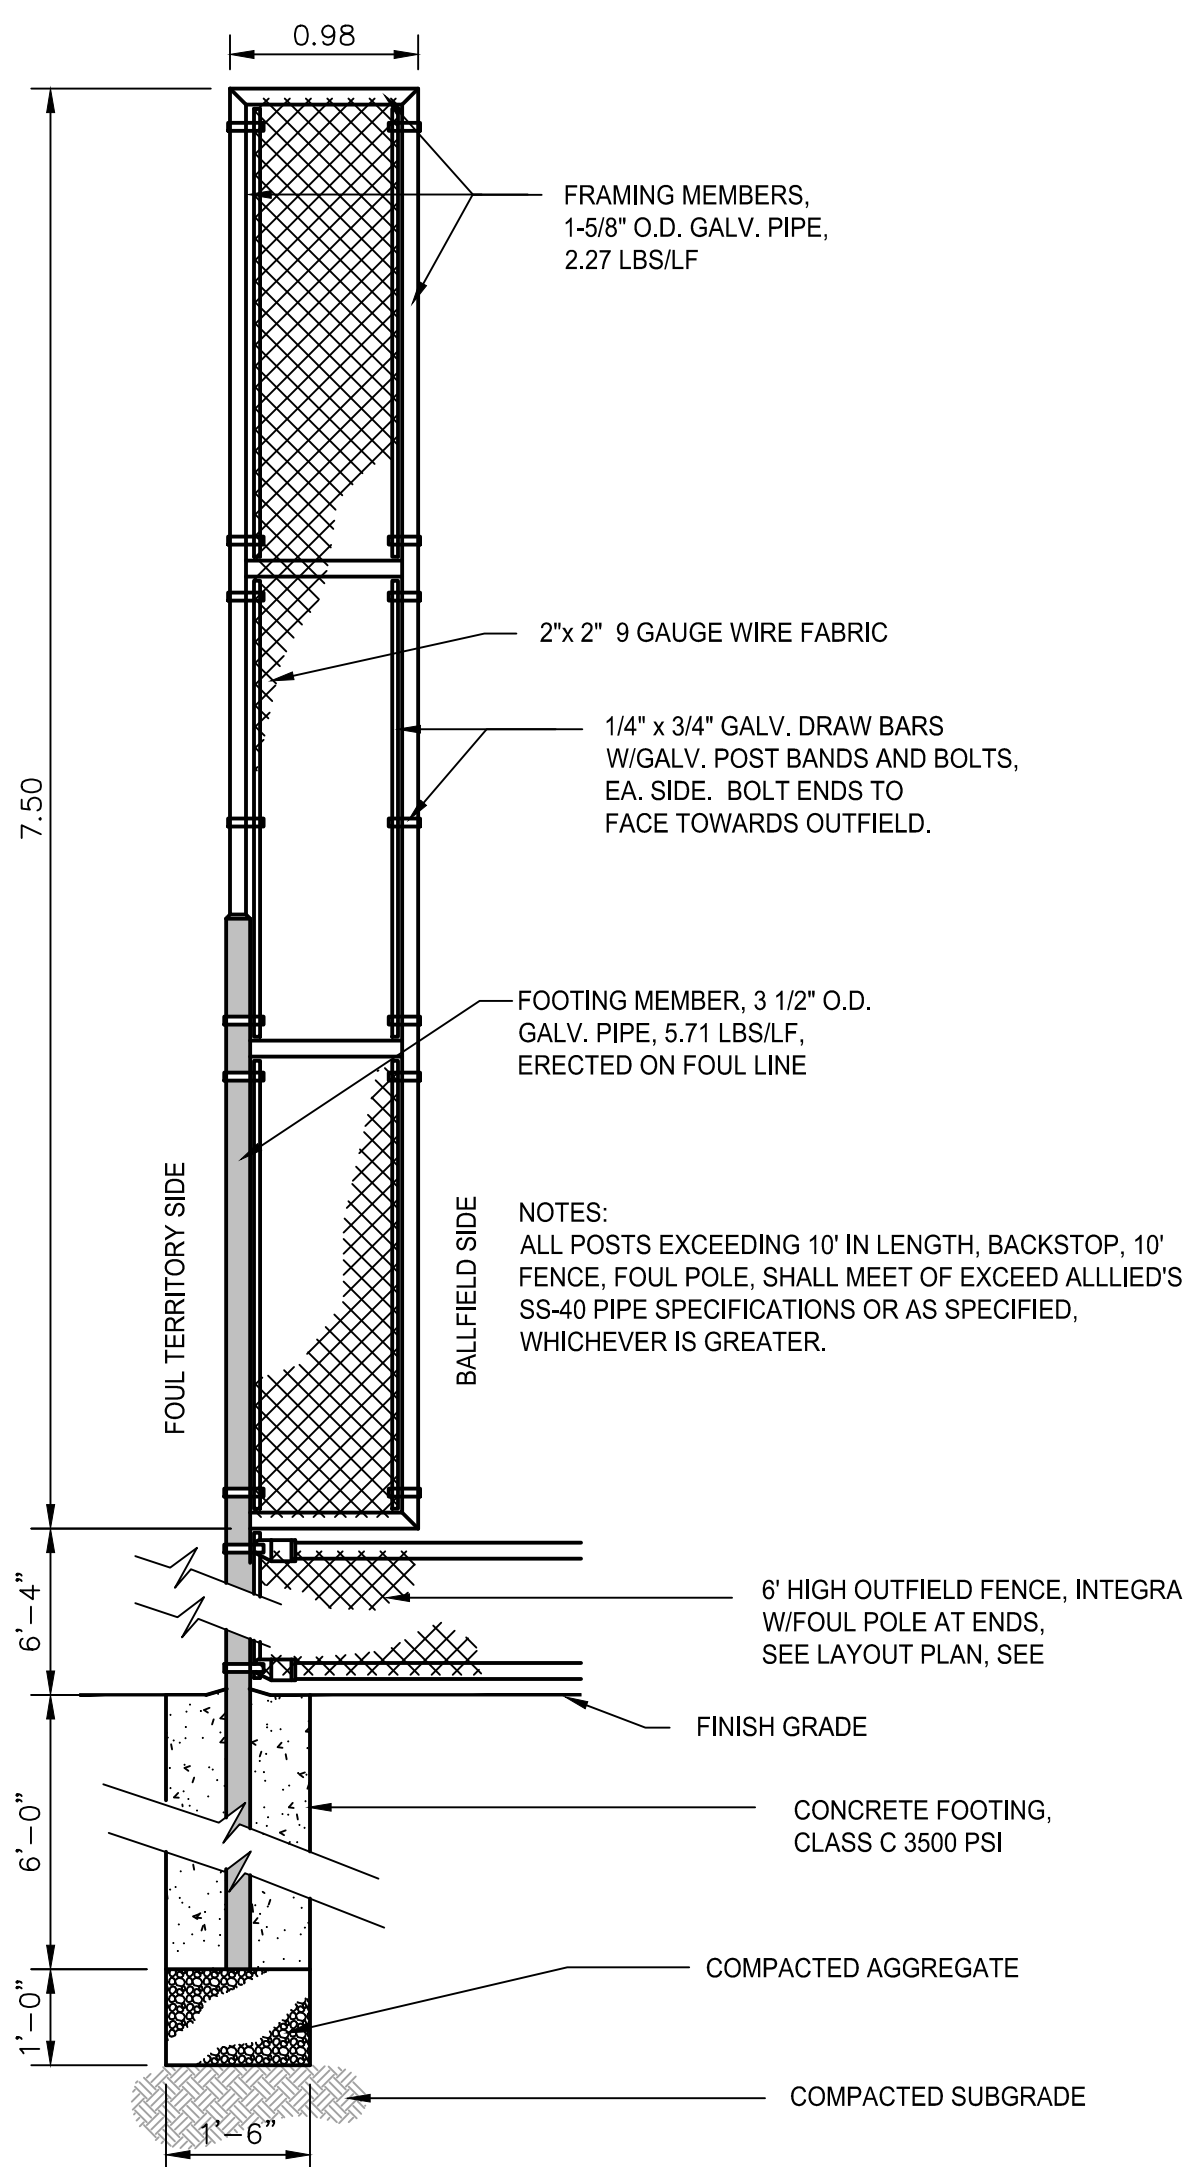


FOUL POST
NOT TO SCALE
(ALTERNATE)

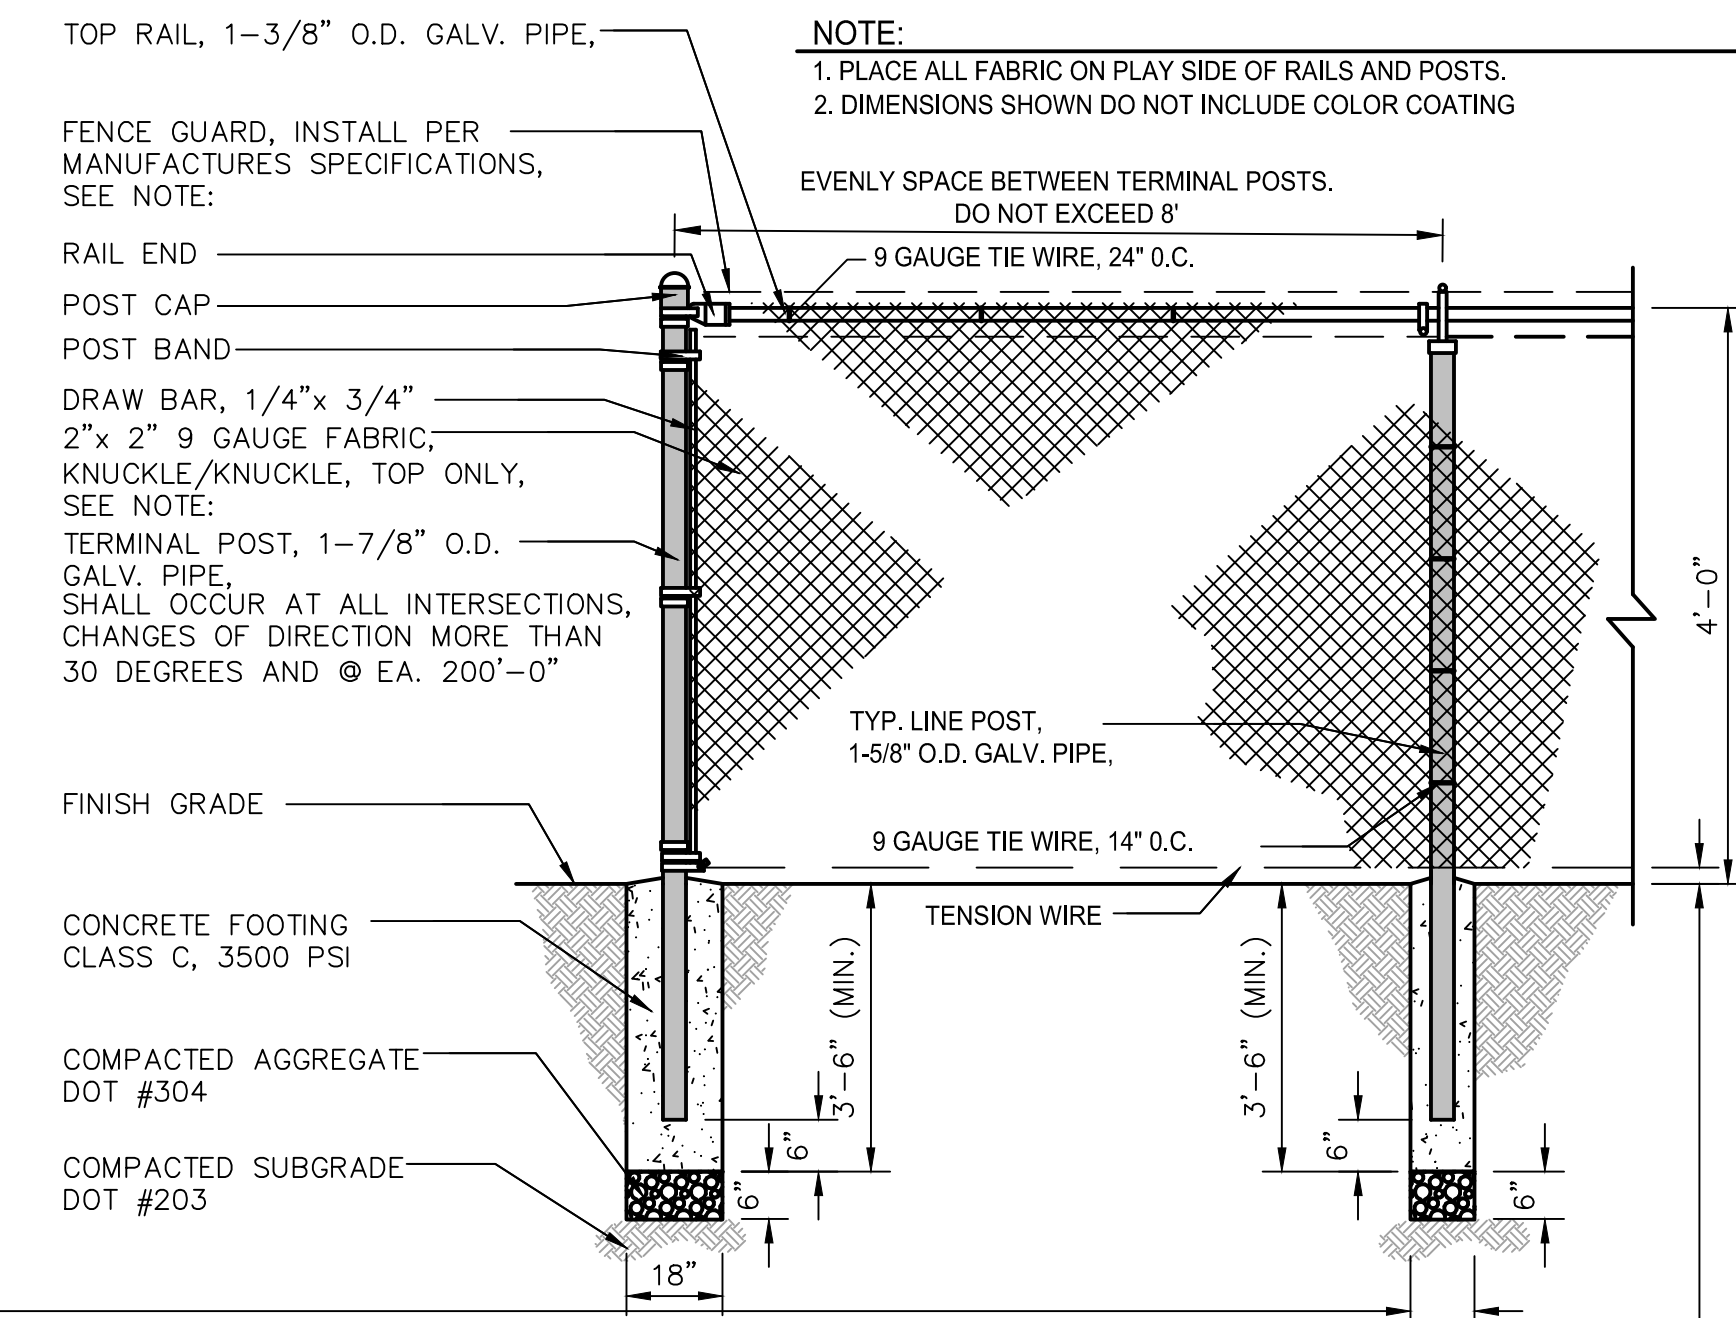

4' CHAINLINK FENCE
NOT TO SCALE
(ALTERNATE)

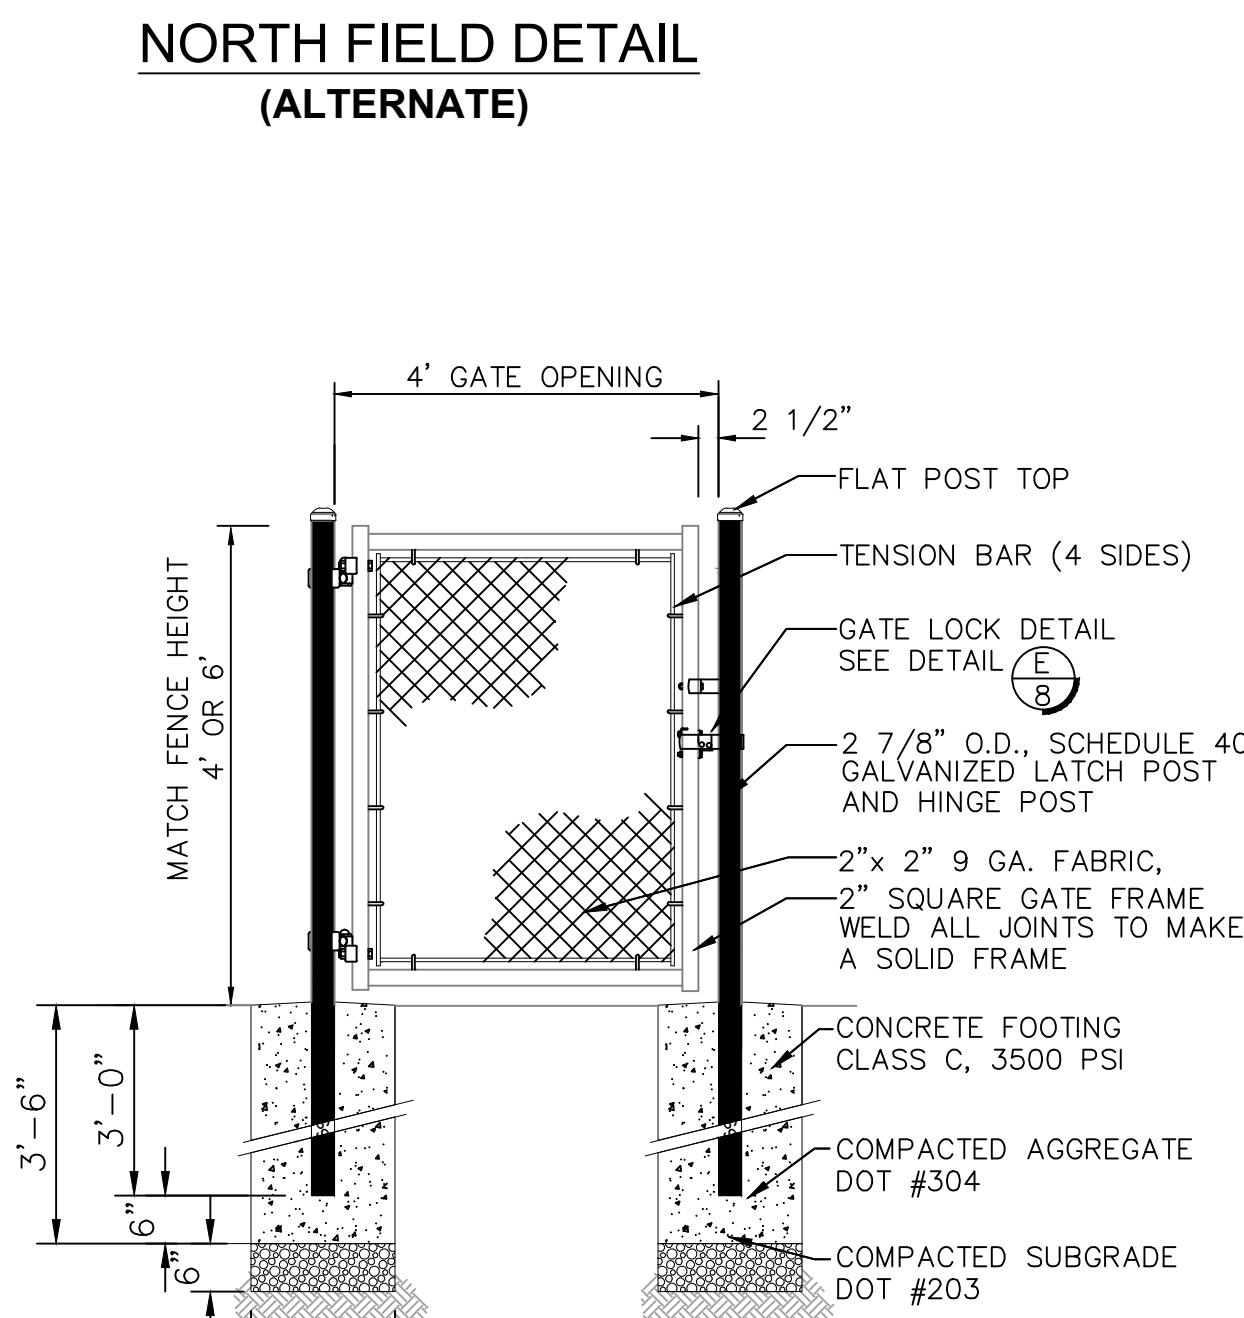

4' CHAINLINK GATE
NOT TO SCALE
(ALTERNATE)

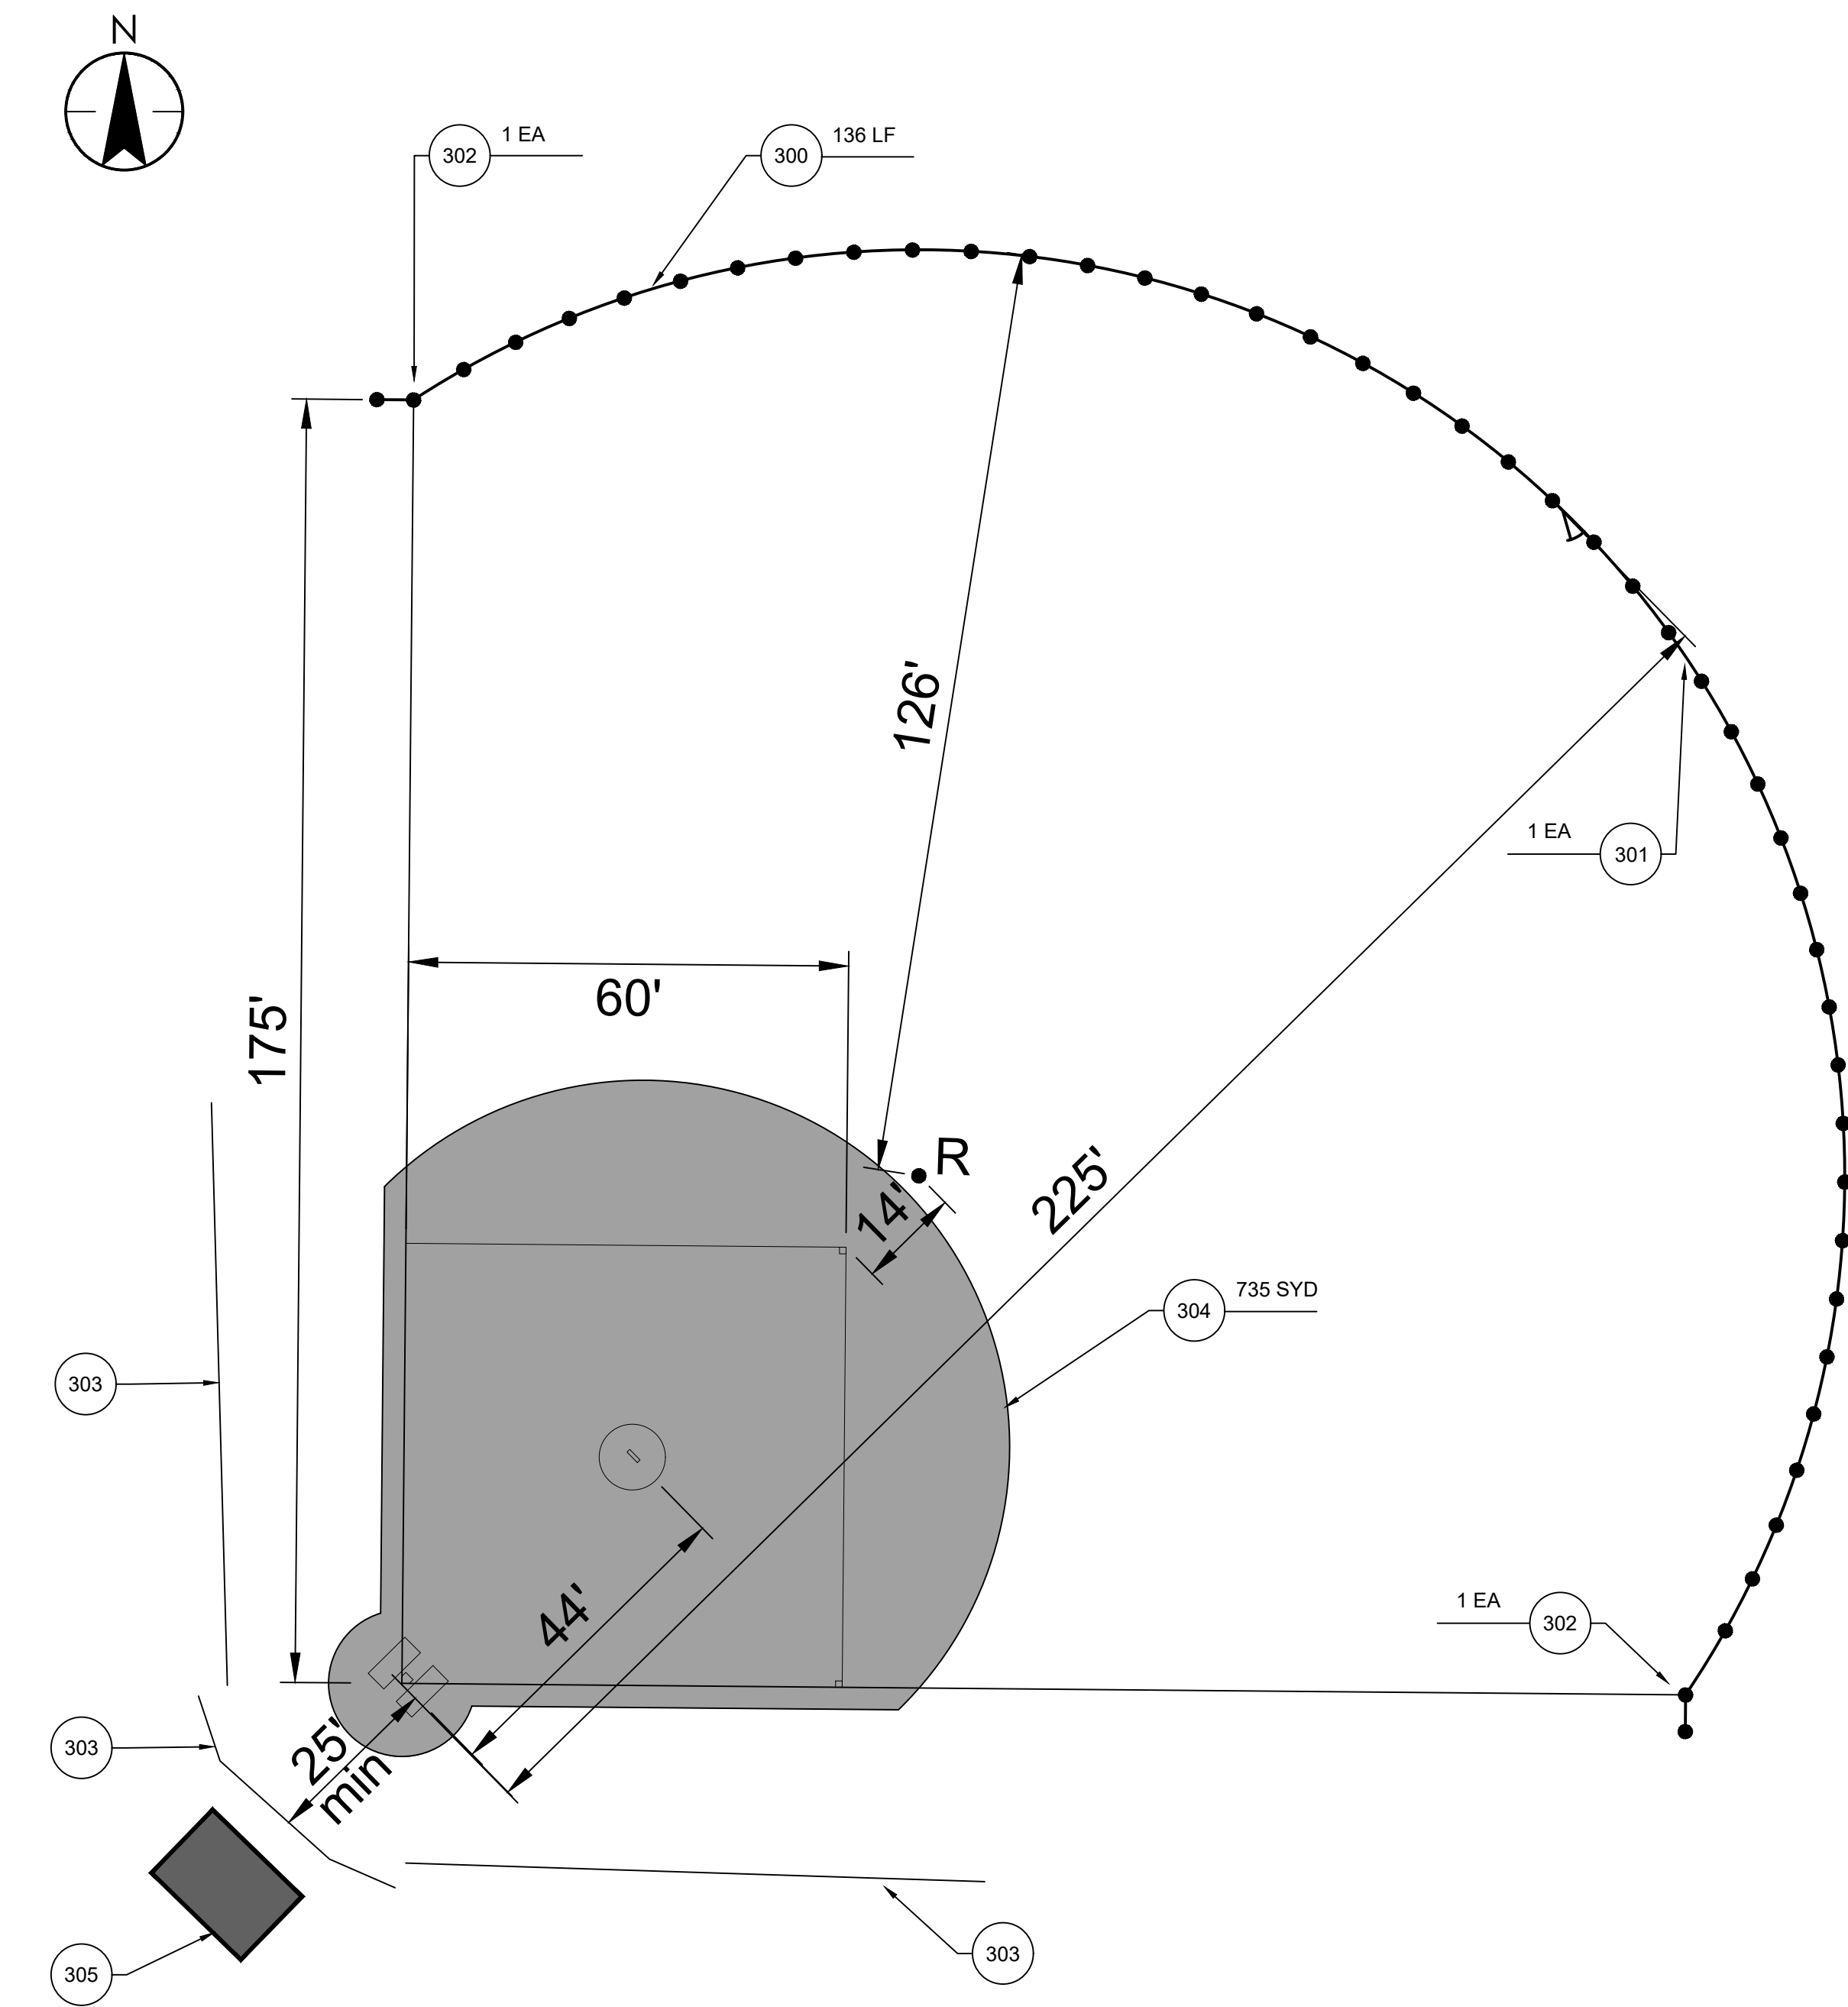

BALLFIELD DIMENSIONS

MUSTANG: AGES 9-10
60 FEET BASE LINES
44 FEET PITCHER MOUND TO HOME PLATE
225 FEET HOMERUN FENCE - POCKET
175 FEET HOMERUN FENCE - BASE LINES
20 FEET HOME PLATE TO BACKSTOP
50 FEET RADIUS ON INFIELD SKIN, RUBBER RADIUS POINT


GIRLS FAST PITCH SOFTBALL: AGE 16+
60 FEET BASE LINES
43 FEET PITCHER MOUND TO HOME PLATE
185-235 FEET HOMERUN FENCE
25 FEET HOME PLATE TO BACKSTOP
60 FEET RADIUS ON INFIELD SKIN, RUBBER RADIUS POINT

KEY NOTES:



- 700 4" BLUE PAVEMENT MARKINGS
- 701 BLUE ACCESSIBLE PARKING DETAIL

NOTE:
SEE SHEET C301 FOR GRADES.

| | | | | |
|------------|-----------------|------|-------|------------|
| A | BID SET PHASE 2 | CRW | MDP | 2023.01.26 |
| Issued | | By | Appd | YYYY.MM.DD |
| File Name: | 140801C-402 | JDA | AHIS | MDP |
| | | Dwn. | Dsgn. | Chkd. |
| | | | | YYYY.MM.DD |

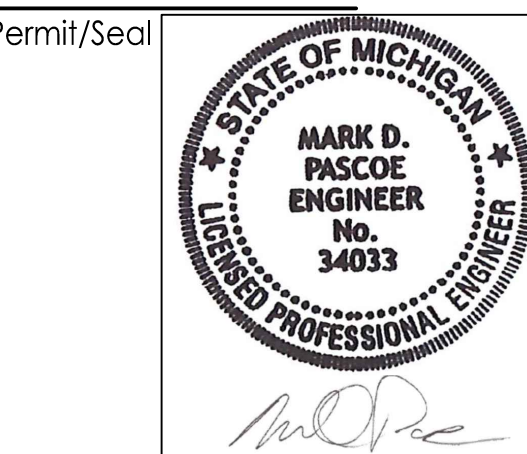

Client/Project Logo

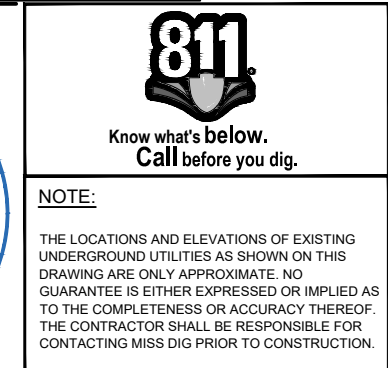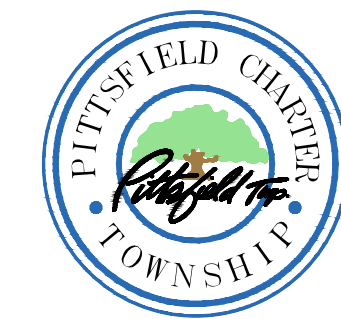

Client/Project
PITTSFIELD CHARTER TOWNSHIP

MONTIBELLER PARK IMPROVEMENTS
PHASE 2

Pittsfield Township, Michigan

Title


DETAILED SITE PLAN - MISCELLANEOUS

Project No.
2075140801


Revision Sheet
0 19 of 24

Scale
0 10' 20'


Drawing No.
C402

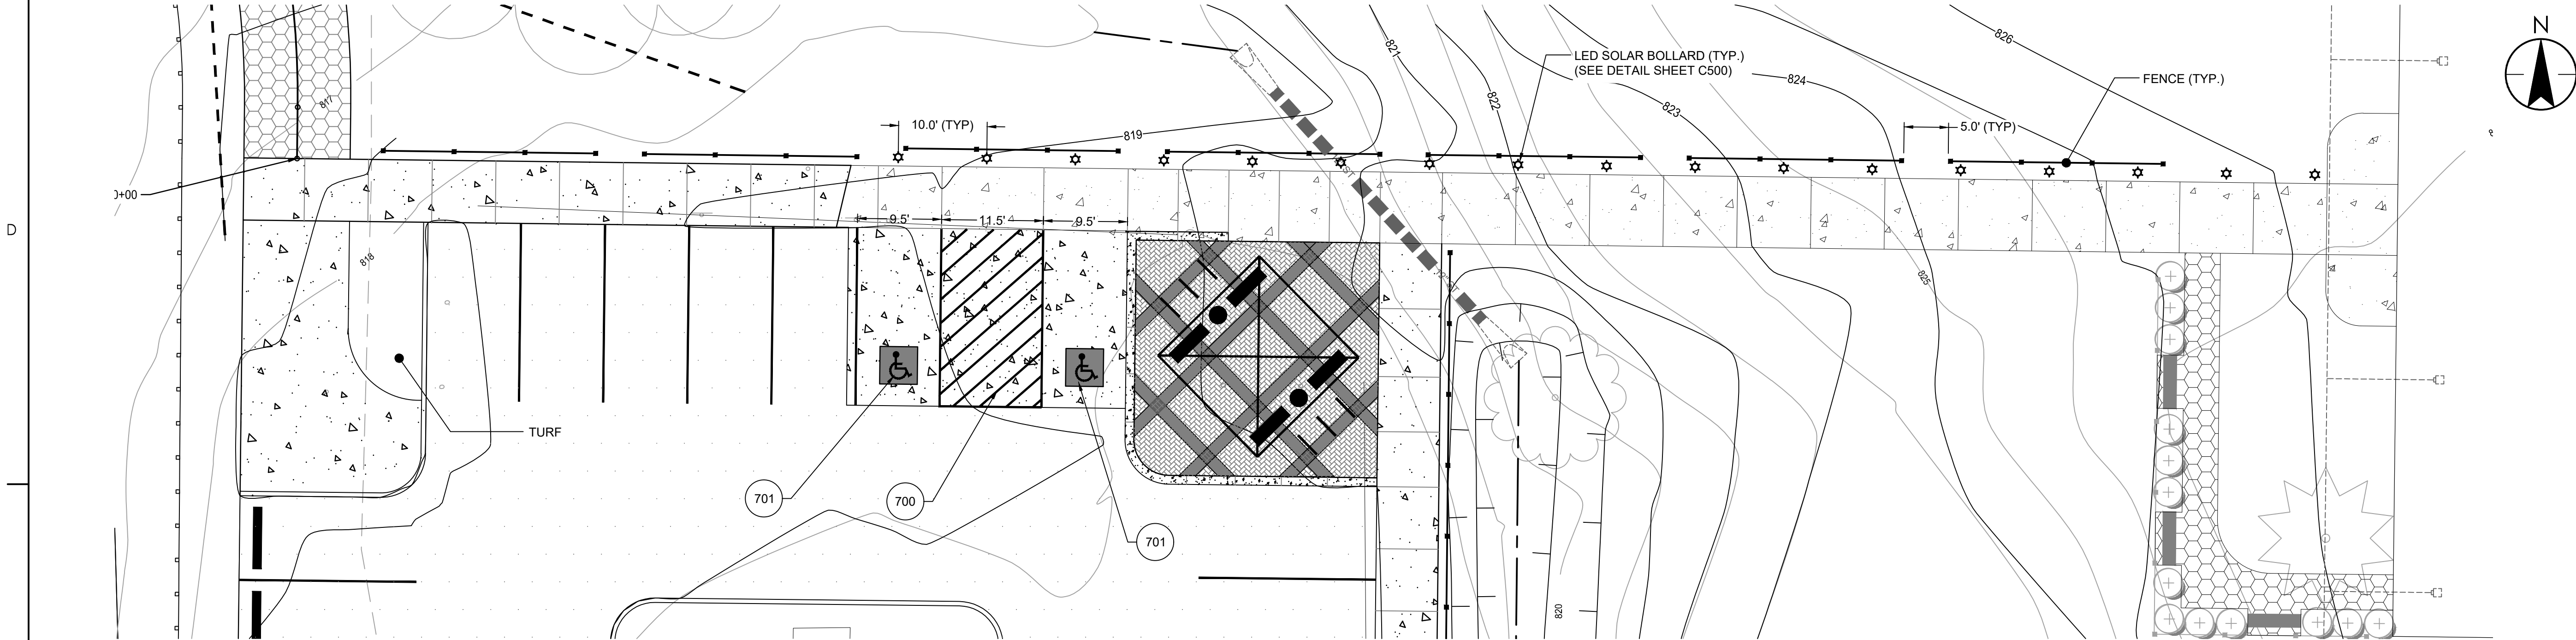

**WEST ADA PARKING AND ARRIVAL POINT DETAIL
(ALTERNATE)**

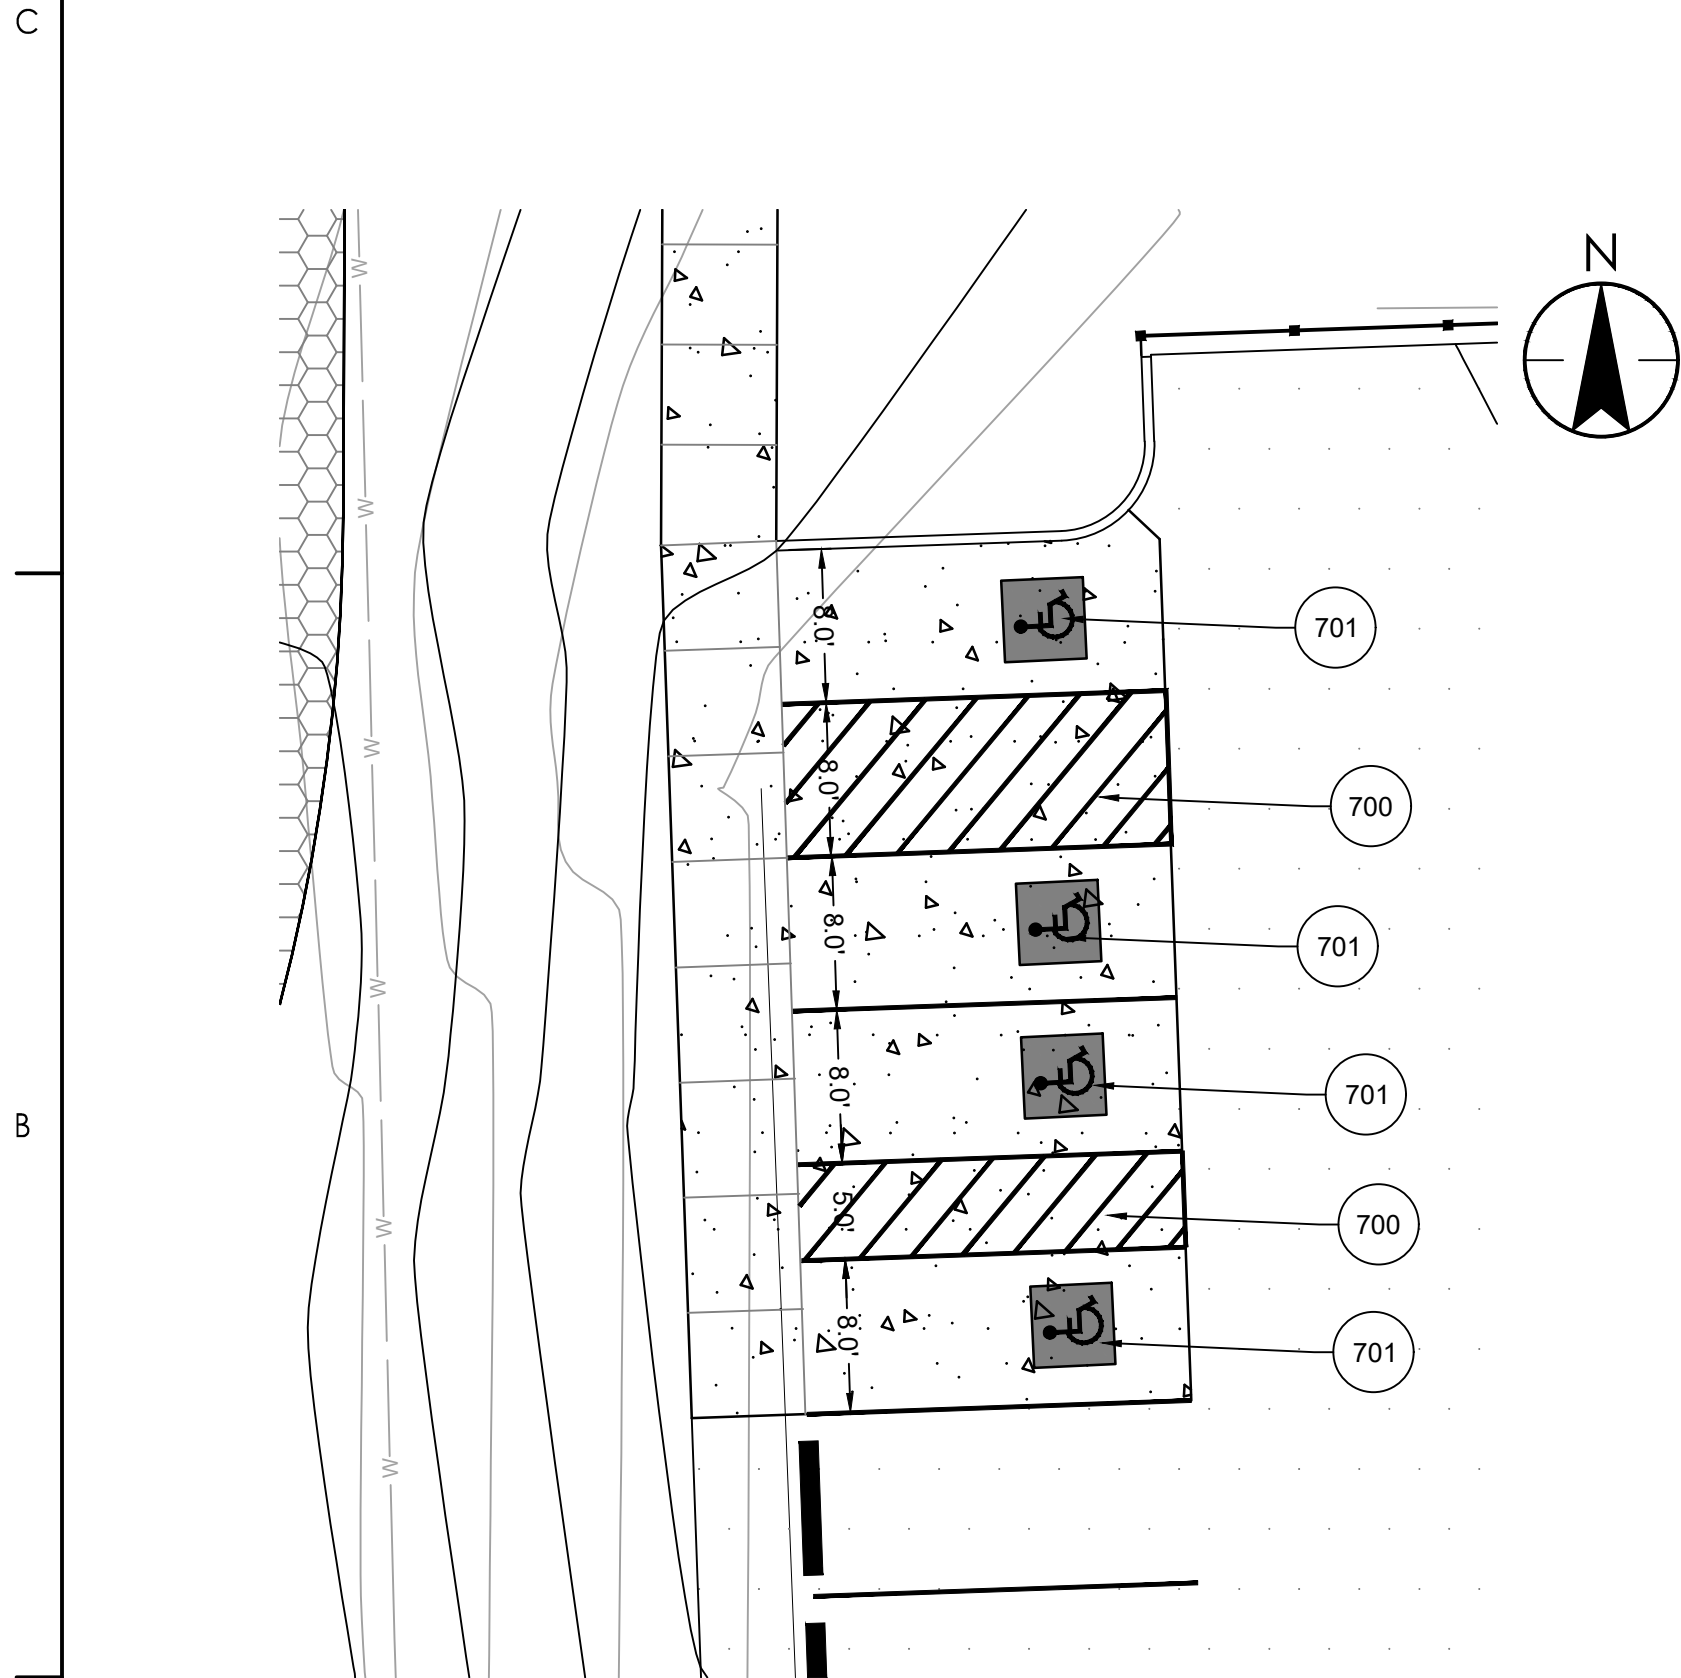

PROPOSED EAST ADA PARKING DETAIL

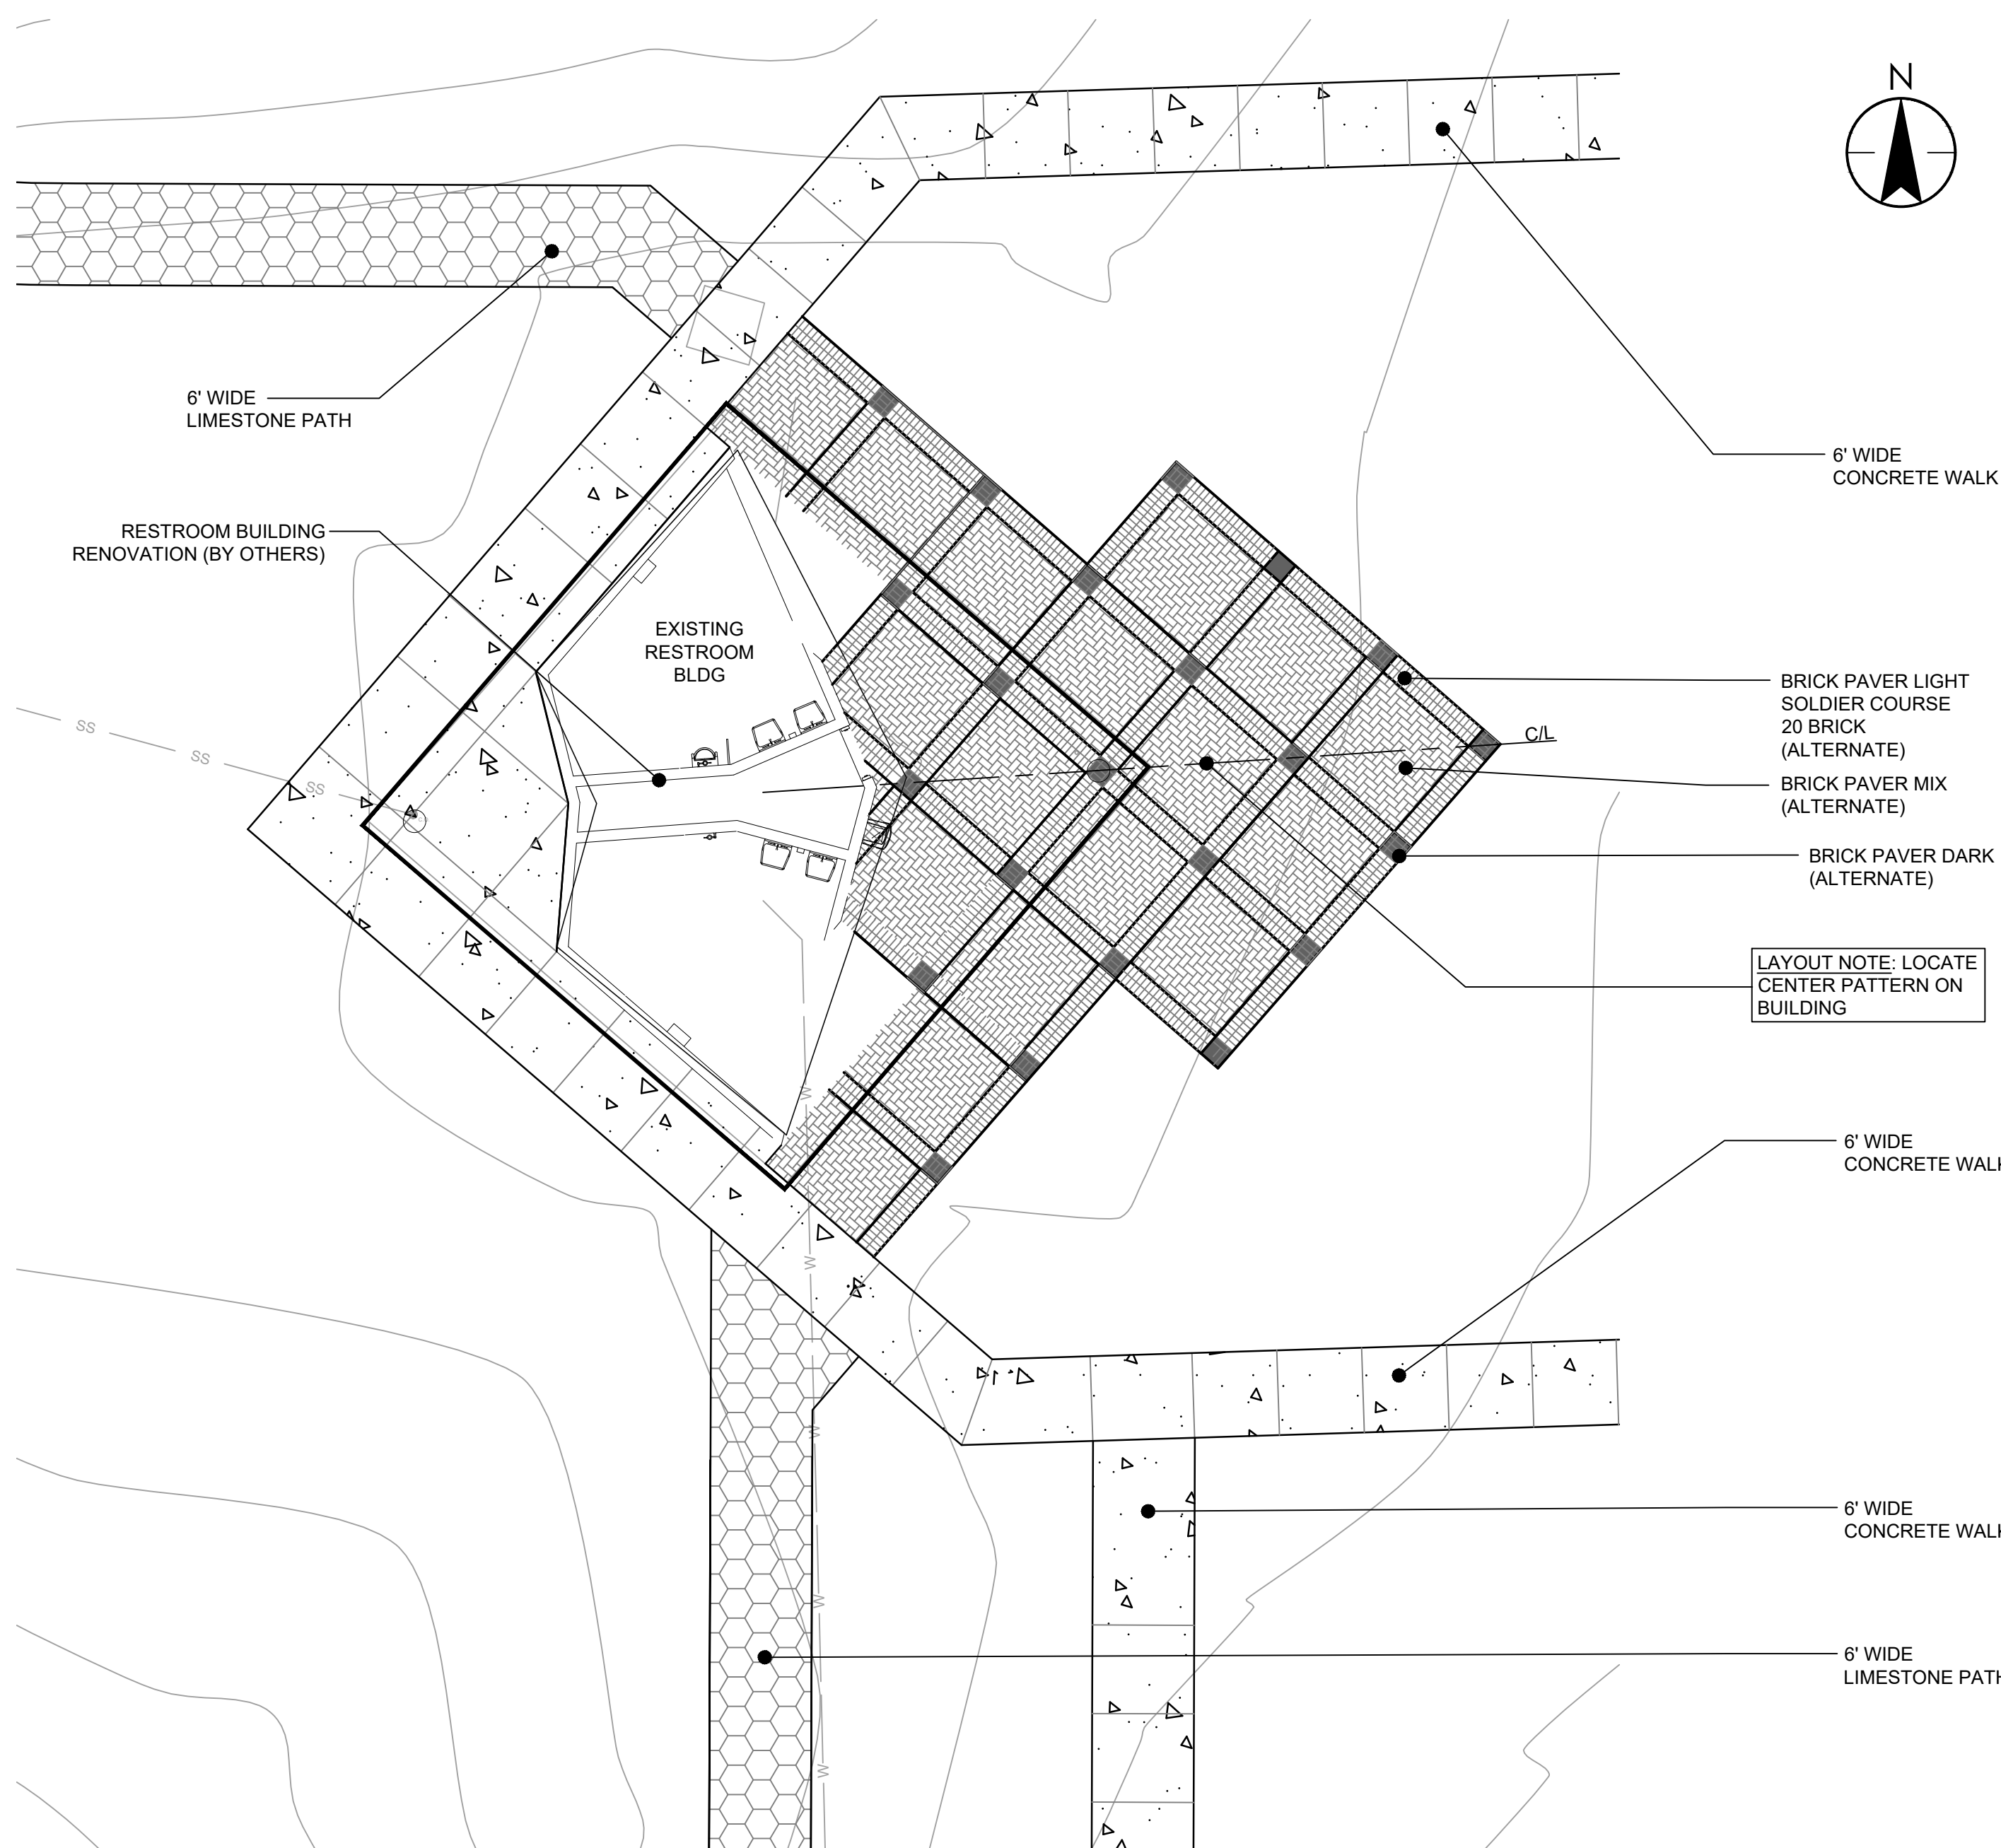

**RESTROOM PLAZA DETAIL
SCALE: 1" = 8'**

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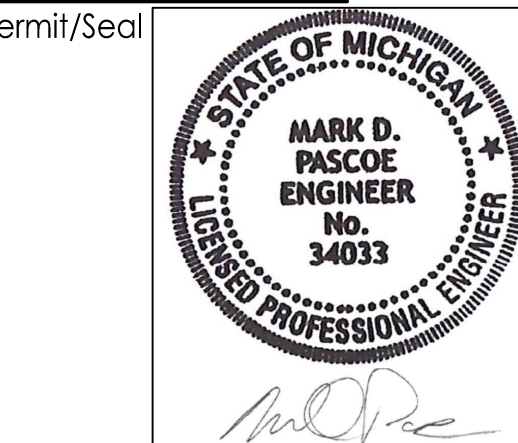
NOTES:

- SEE SHEET C302 FOR PICKBALL COURT GRADING.
- PICKLEBALL EQUIPMENT:
PICKLEBALL EQUIPMENT SHALL BE AS MANUFACTURED BY JAYPRO SPORTS AVAILABLE AT WWW.JAYPRO.COM. POSTS SHALL BE MODEL PPR10GR DELUXE PICKLEBALL POST 2 7/8". HEAVY DUTY SELF LOCKING WINCH WITH REMOVABLE HANDLE. INCLUDE GROUND SLEEVES AND COVERS, TP278G. PICKLEBALL NET SHALL BE PT-2IN. INSTALL PICKBALL EQUIPMENT WITH GROUND SLEEVES AND PER THE MANUFACTURER'S RECOMMENDATION FOR LOCATION, METHODS, FOOTINGS, AND HEIGHT. EXCEPTION IS THAT FOOTING MUST BE TO A DEPTH OF NOT LESS THAN 42".


KEY NOTES:

- 800 PROPOSED 10' HIGH CHAIN LINK FENCE, PER SPEC SHEET C401
- 801 PROPOSED 6' WIDE GATE, 10' TALL
- 802 PROPOSED PICKLEBALL NOVA PROBOUNCE SURFACE, SEE DETAIL SHEET C501
- 803 PROPOSED PICKLEBALL COURT STRIPING
- 804 PROPOSED PICKLEBALL COURT NETS
- 805 CRACK SEAL EXISTING SURFACE, TOP WITH NOVA PROBOUNCE SURFACE, SEE DETAIL SHEET C501
- 806 TENNIS COURT STRIPING OF 2 COURTS WITH LATEX LINE PAINT PER USTA REQUIREMENTS
- 807 SALVAGE AND RE-INSTALL TENNIS COURT NETS AFTER RESURFACING

| | | | | |
|------------|-----------------|------|-------|------------|
| A | BID SET PHASE 2 | CRW | MDP | 2023.01.26 |
| Issued | | By | Appd | YYYY.MM.DD |
| File Name: | 140801C-403 | JDA | AHS | MDP |
| | | Dwn. | Dsgn. | Chkd. |



Client/Project Logo

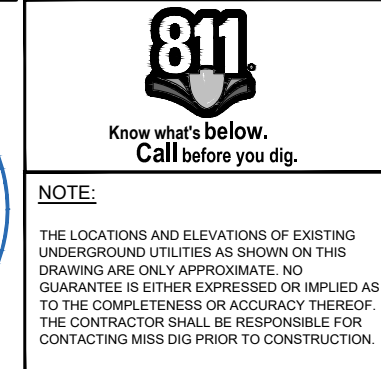

Client/Project

PITTSFIELD CHARTER TOWNSHIP

MONTIBELLER PARK IMPROVEMENTS
PHASE 2

Pittsfield Township, Michigan

Title

DETAILED SITE PLAN -
COURTS SITE PLAN

Project No.
2075140801

Revision Sheet
0 20 of 24

Scale
0 10' 20'

Drawing No.













C403

D

C




B

A

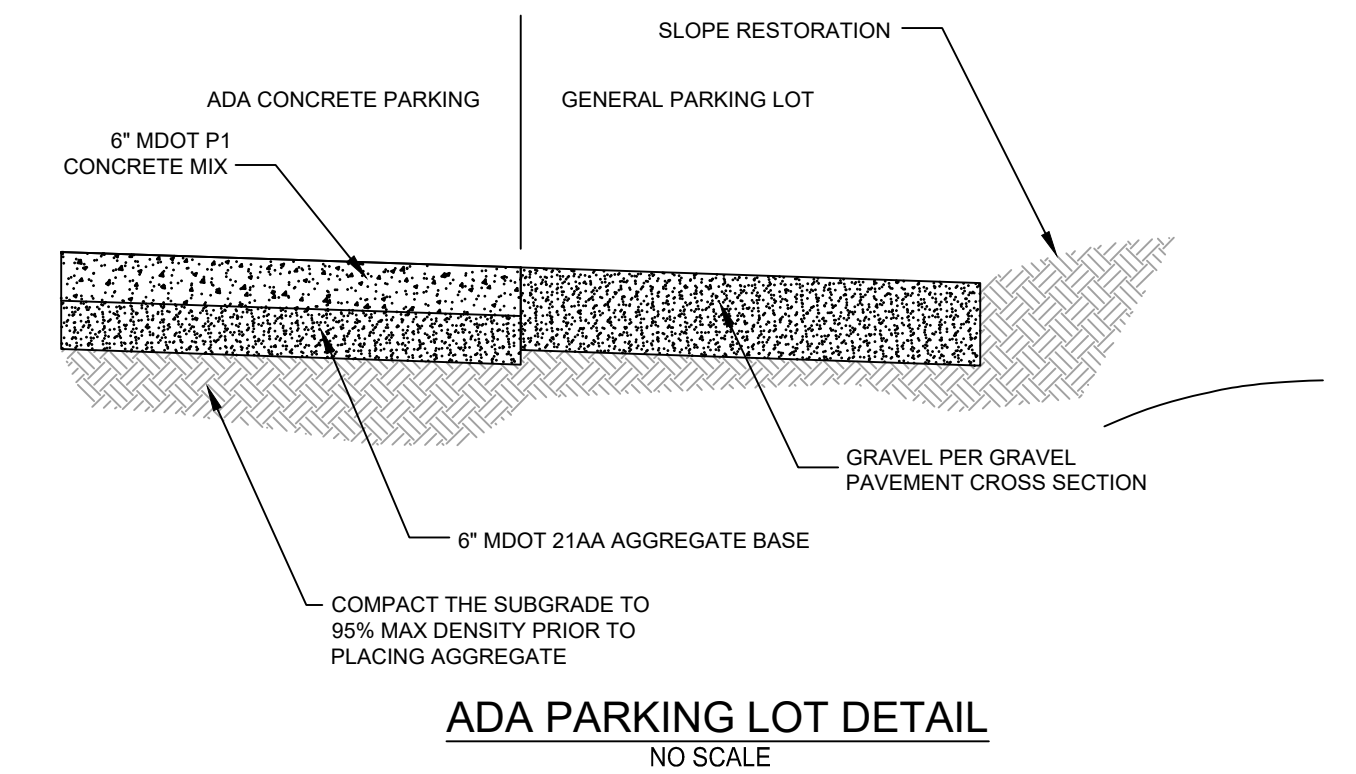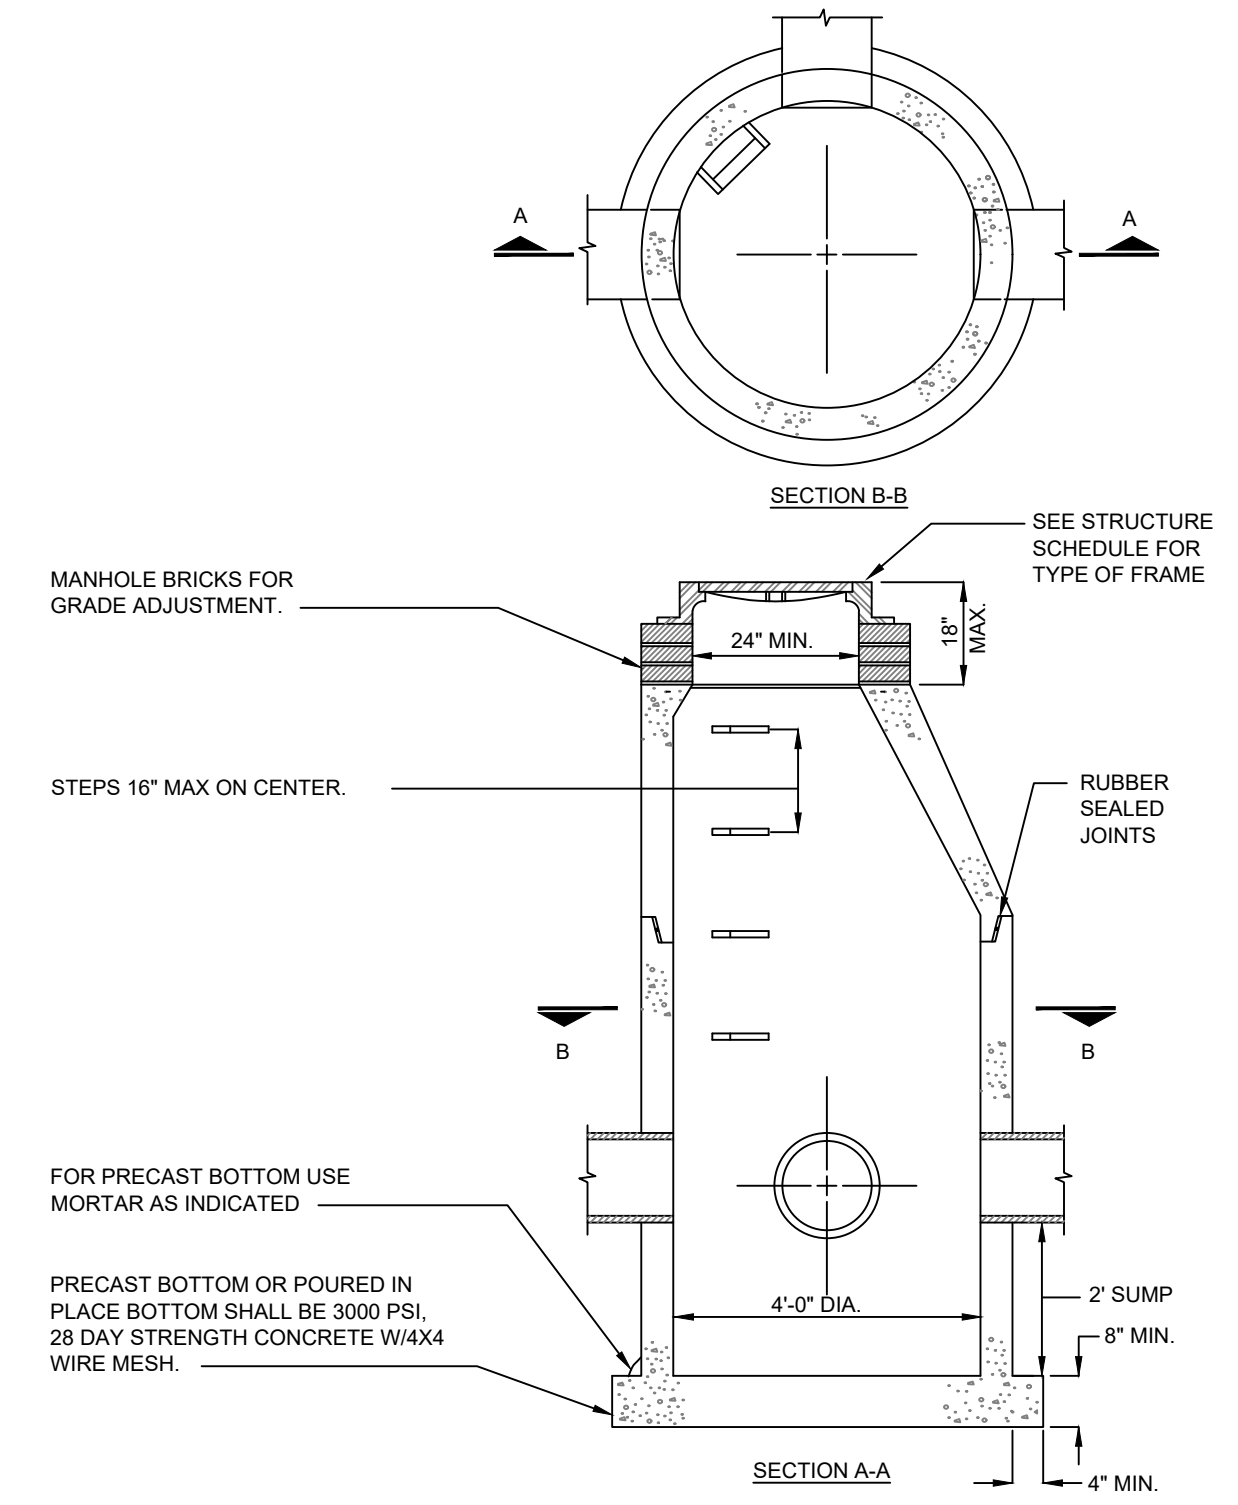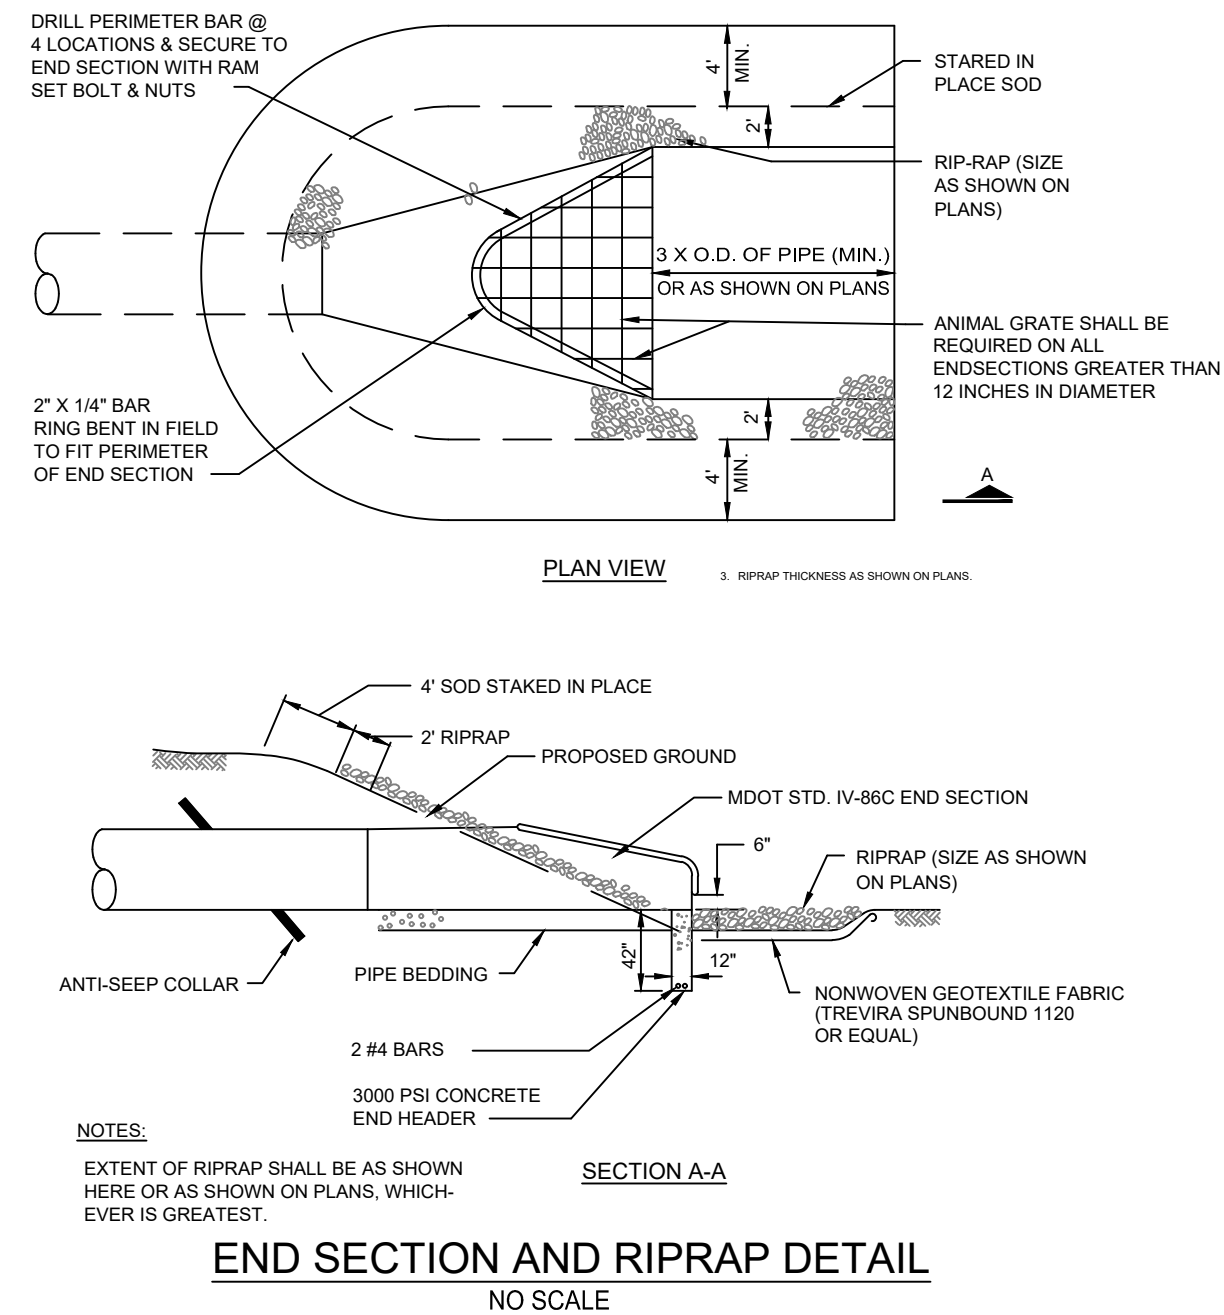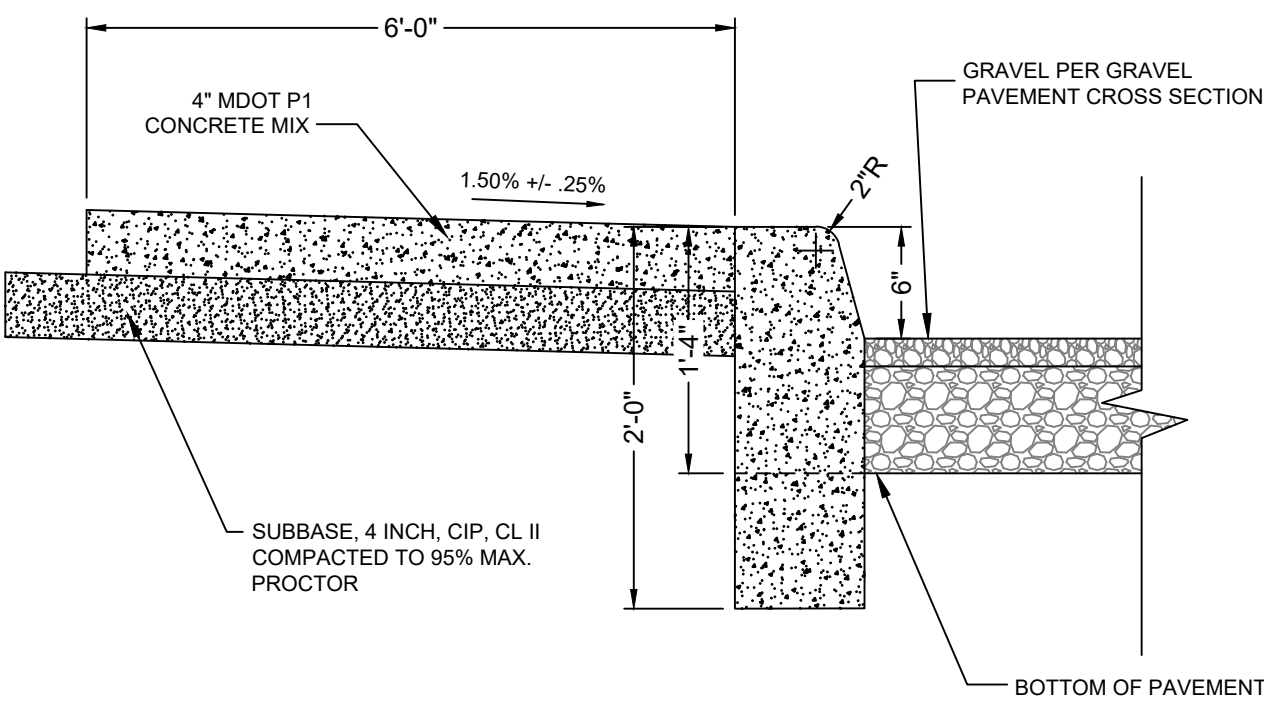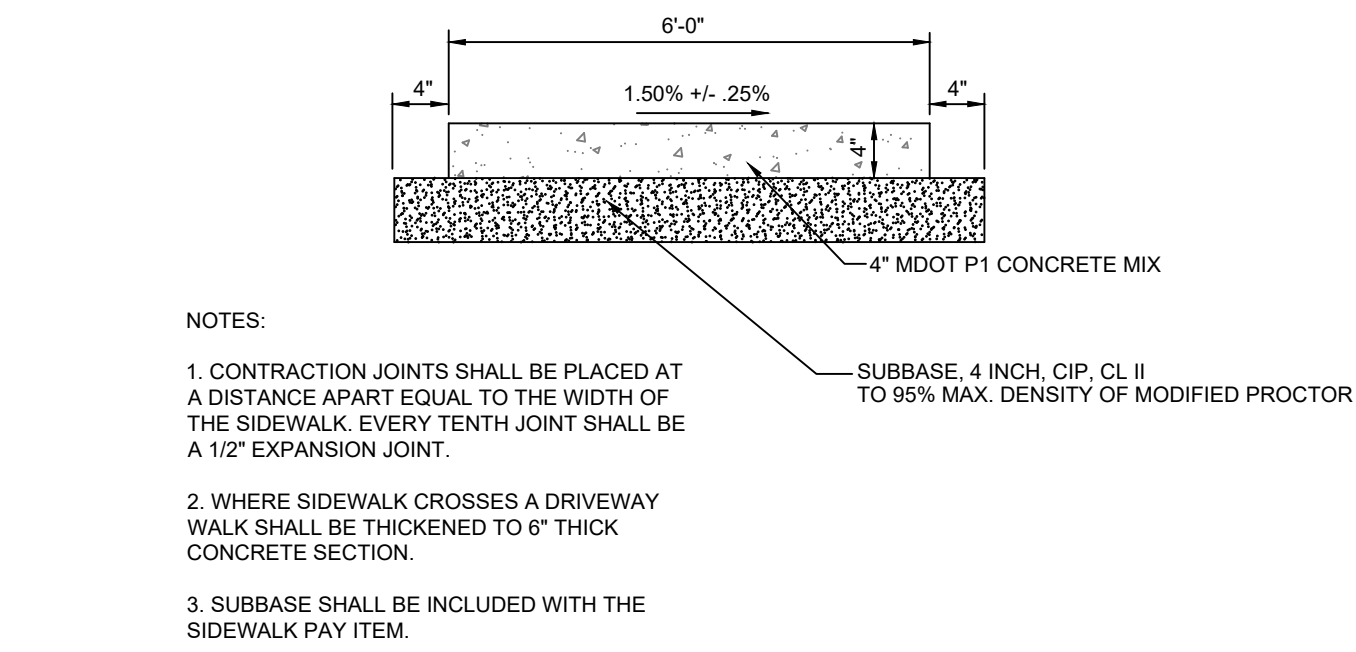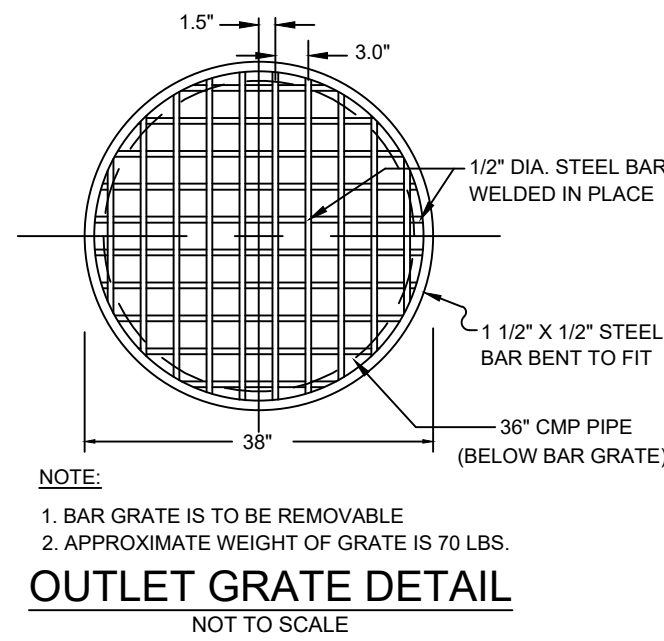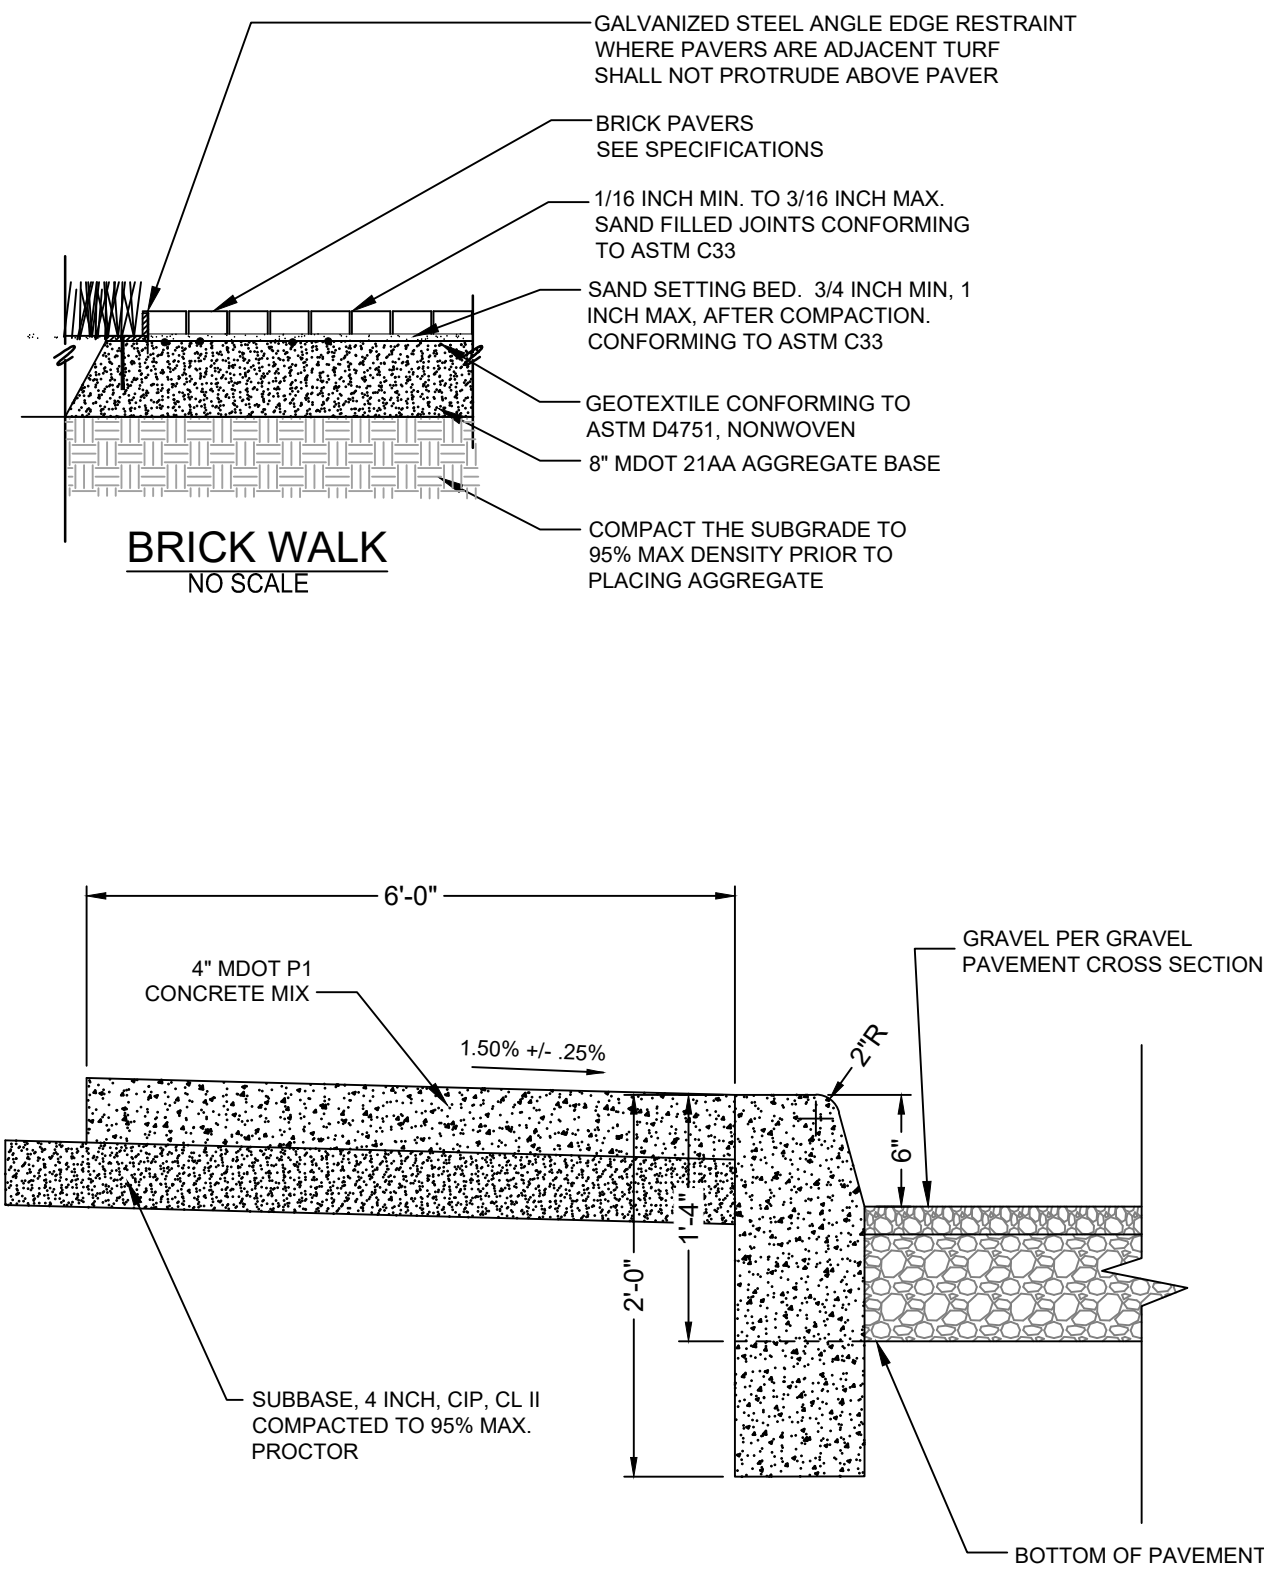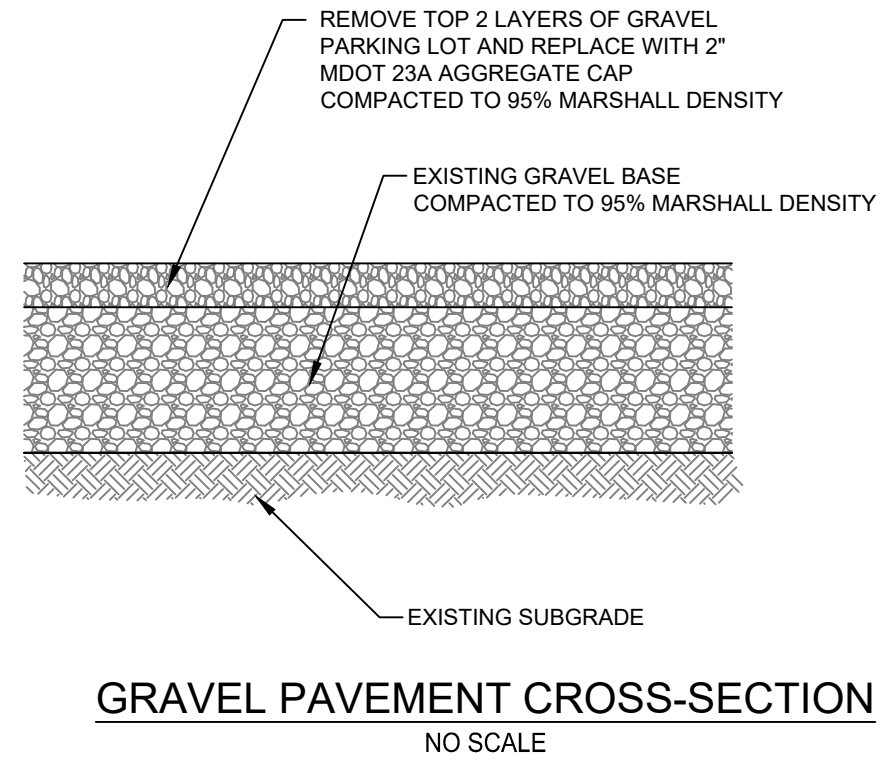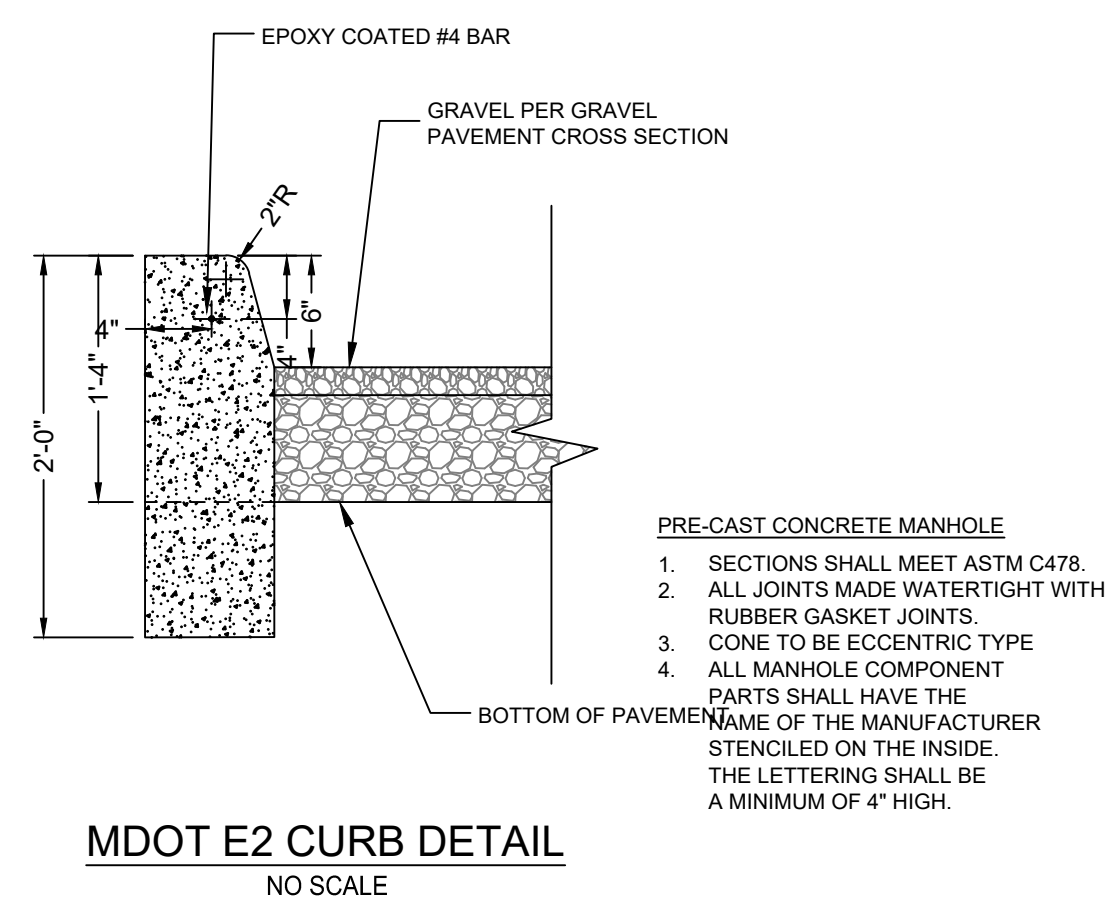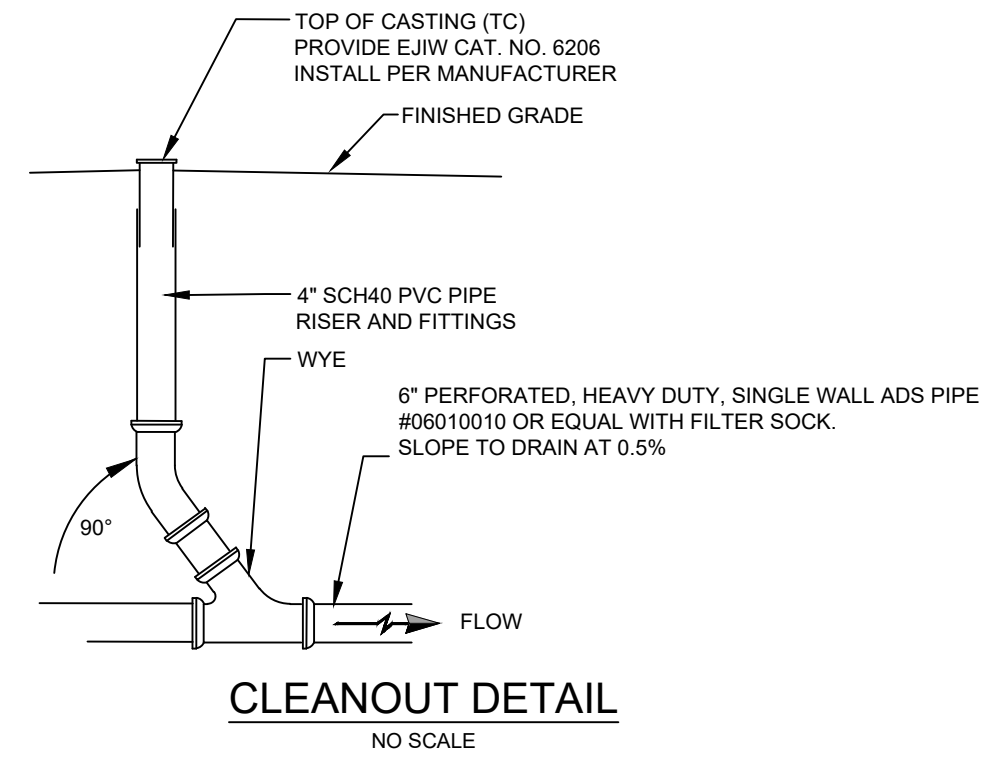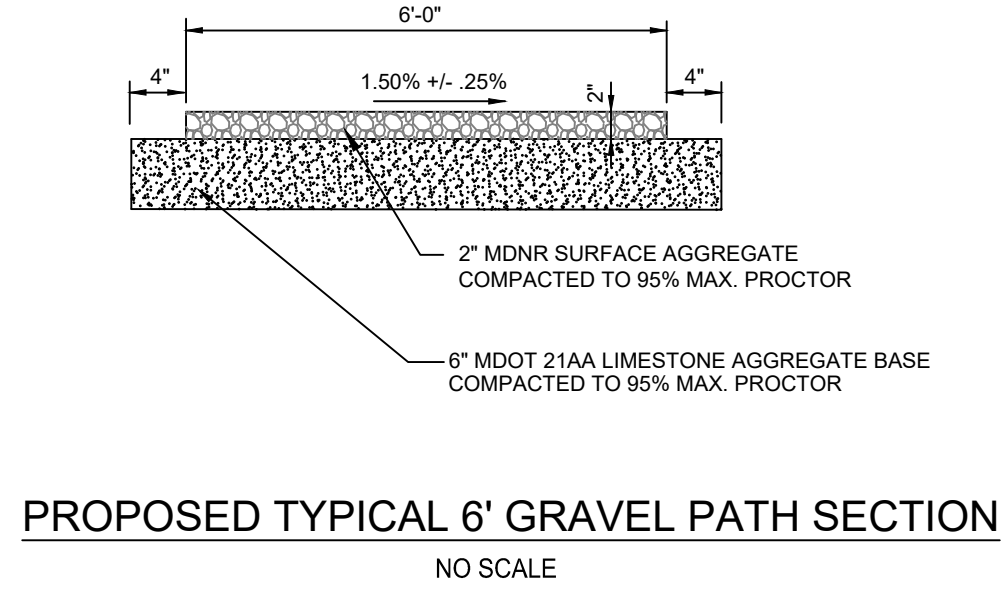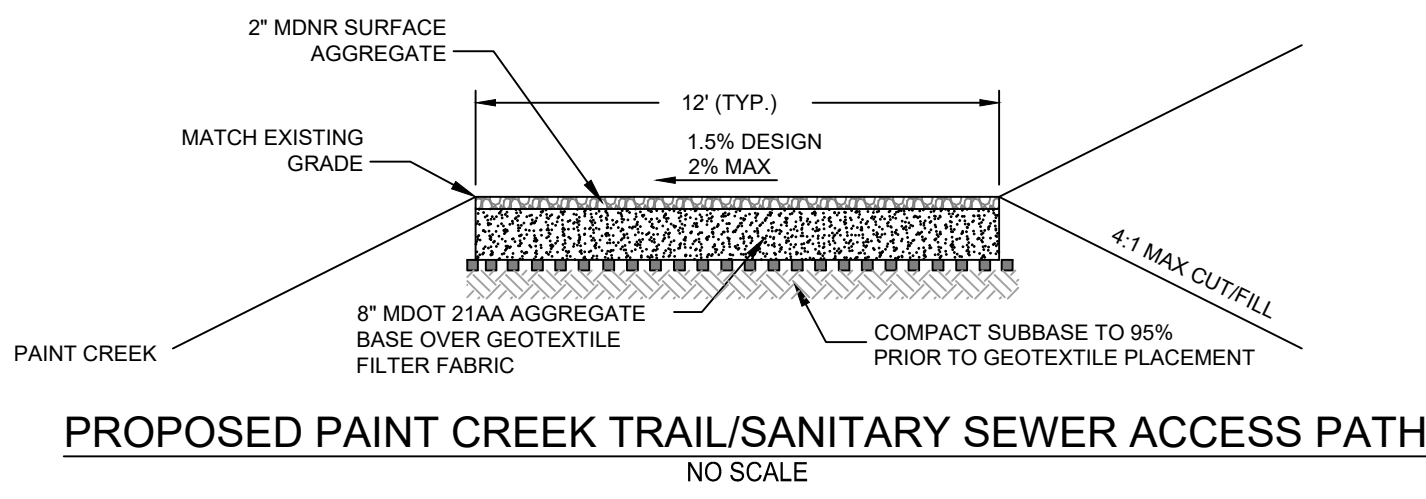

| | | | | | |
|-------|-----|-----|----|-----|----|
| SP018 | 40K | BLK | WD | AKE | 1S |
|-------|-----|-----|----|-----|----|

Motion Sensor Detection
SP-018 Smart Solar Illuminating Bollard incorporates the latest infrared motion sensor. Dimming mode is set at 1/3 brightness and lights to 100% brightness for 1 minute when motion sensor is triggered. The high performance motion sensor detects abrupt changes in temperature within a 16.5ft radius. Movement within designated radius is necessary to trigger sensor to turn on.

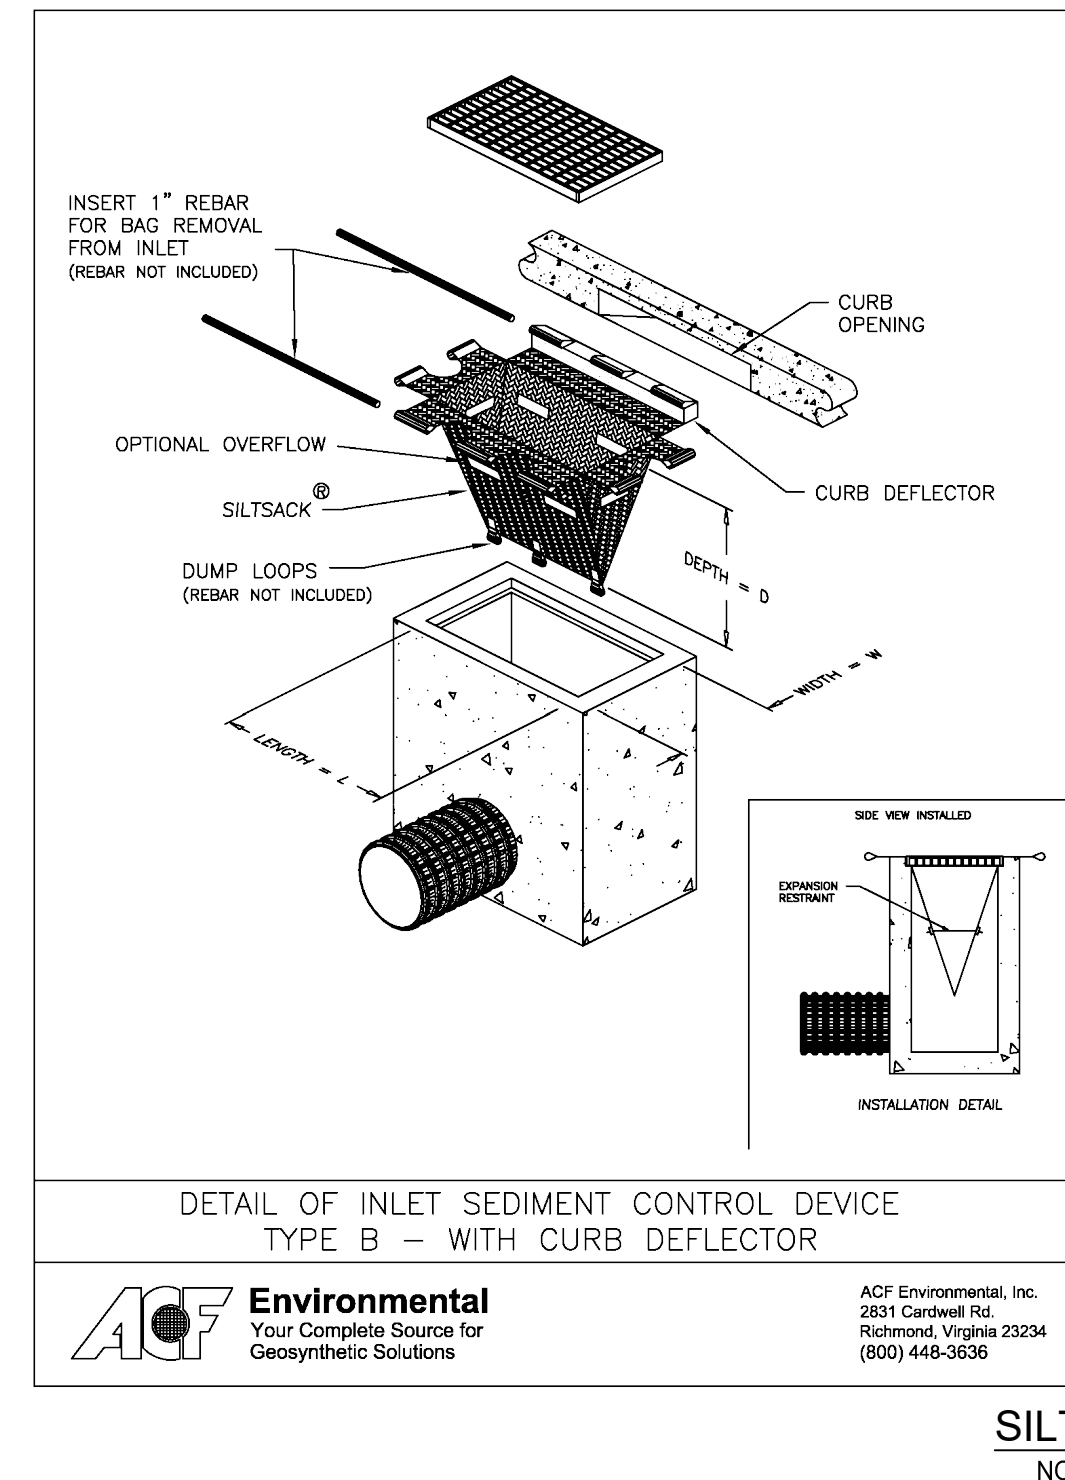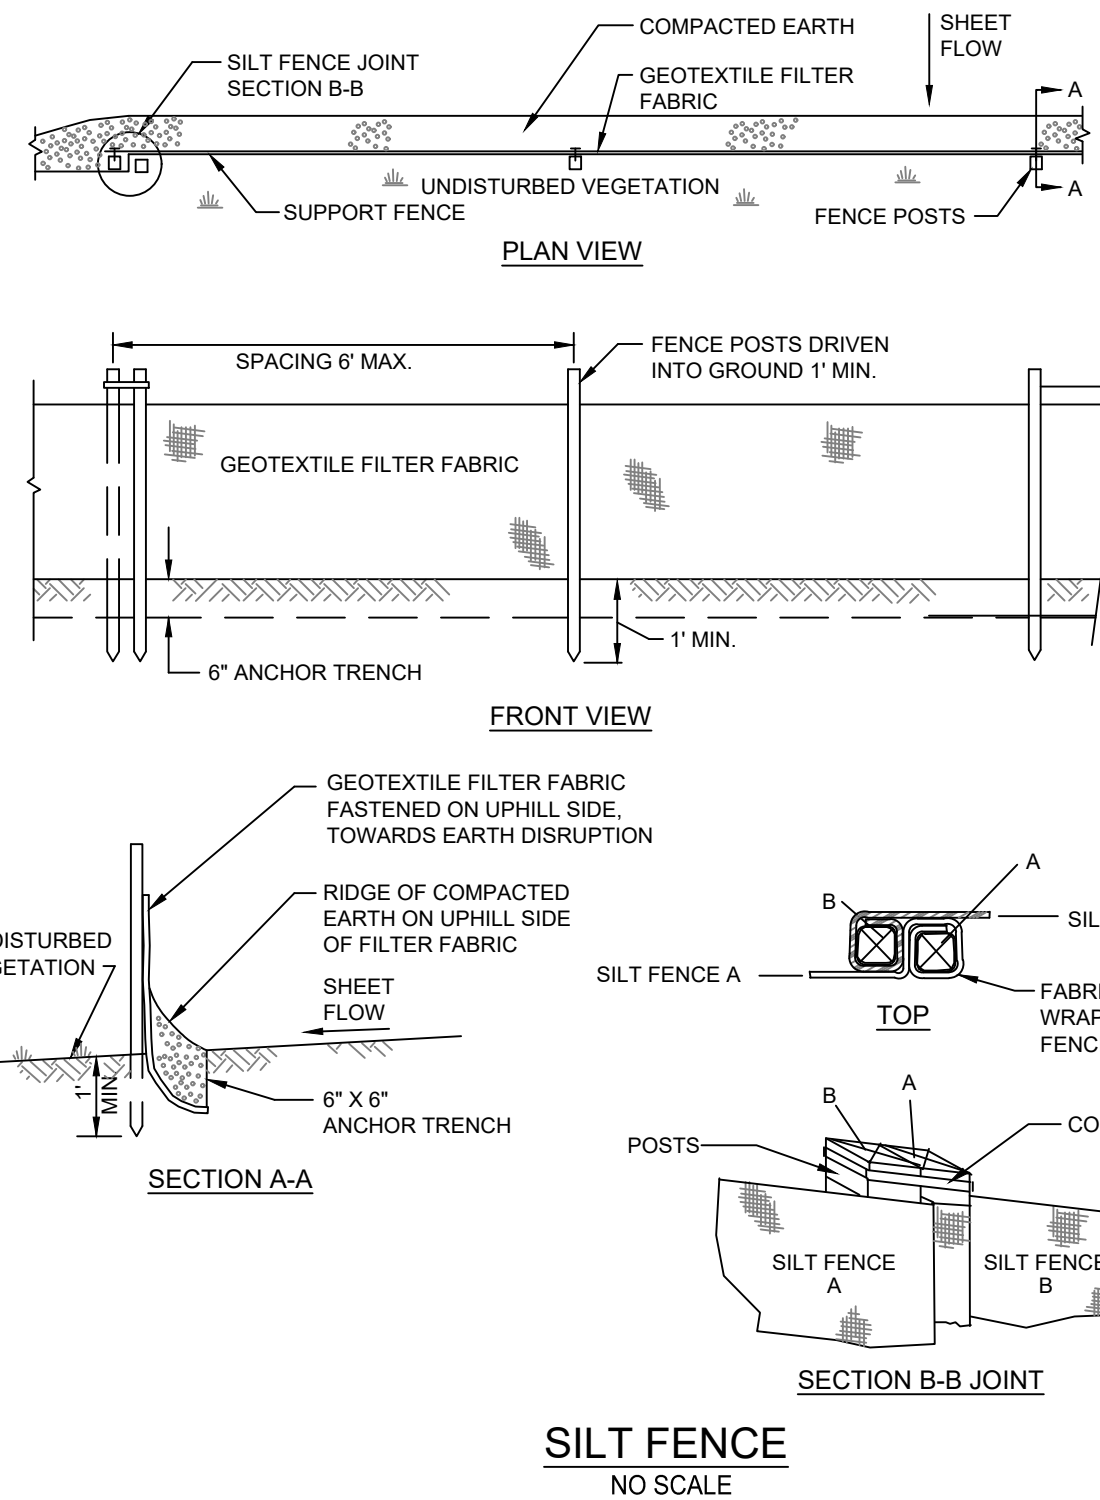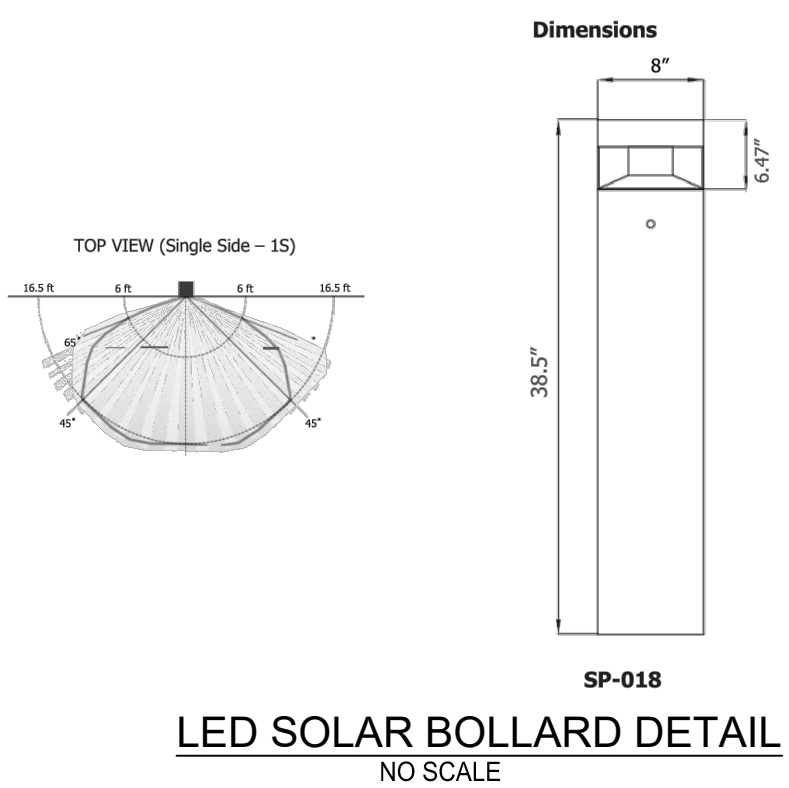

| SILTSACK® SPECIFICATIONS | | | |
|--|-------------|-------------------|--|
| NOTE: THE SILTSACK® WILL BE MANUFACTURED FROM A WOVEN POLYPROPYLENE FABRIC THAT MEETS OR EXCEEDS THE FOLLOWING SPECIFICATIONS. | | | |
| REGULAR FLOW SILTSACK® (FOR AREAS OF LOW TO MODERATE PRECIPITATION AND RUN-OFF) | | | |
| PROPERTIES | TEST METHOD | UNITS | |
| GRAB TENSILE STRENGTH | ASTM D-4632 | 300 LBS | |
| GRAB TENSILE ELONGATION | ASTM D-4632 | 20 % | |
| PUNCTURE | ASTM D-4633 | 300 LBS | |
| MULLER BURST | ASTM D-3786 | 800 PSI | |
| TRAPEDDIT TEAR | ASTM D-4333 | 80 LBS | |
| UV RESISTANCE | ASTM D-4335 | 80 % | |
| APPEARANT OPENING SIZE | ASTM D-4701 | 48 US SIEVE | |
| FLOW RATE | ASTM D-4491 | 48 GAL/MIN/25 FT | |
| PERMITTIVITY | ASTM D-4491 | 15 SEC - 1 | |
| HI-FLOW SILTSACK® (FOR AREAS OF MODERATE TO HEAVY PRECIPITATION AND RUN-OFF) | | | |
| PROPERTIES | TEST METHOD | UNITS | |
| GRAB TENSILE STRENGTH | ASTM D-4632 | 250 LBS | |
| GRAB TENSILE ELONGATION | ASTM D-4632 | 20 % | |
| PUNCTURE | ASTM D-4633 | 125 LBS | |
| MULLER BURST | ASTM D-3786 | 400 PSI | |
| TRAPEDDIT TEAR | ASTM D-4333 | 45 LBS | |
| UV RESISTANCE | ASTM D-4335 | 80 % | |
| APPEARANT OPENING SIZE | ASTM D-4701 | 20 US SIEVE | |
| FLOW RATE | ASTM D-4491 | 200 GAL/MIN/25 FT | |
| PERMITTIVITY | ASTM D-4491 | 15 SEC - 1 | |
| OIL-ABSORBANT SILTSACK® (FOR AREAS WHERE THERE IS A CONCERN FOR OIL RUN-OFF OR SPILLS) | | | |
| DEPENDING ON YOUR PARTICULAR APPLICATION, THE SILTSACK CAN BE MADE FROM EITHER ONE OF THE ABOVE FABRICS WITH AN OIL-ABSORBANT PILLION INSERT OR, MADE COMPLETELY FROM AN OIL-ABSORBANT SILTSACK WITH A WOVEN PILLION INSERT. | | | |
| SILTSACK DISTRIBUTORS: | | | |
| PRICE & COMPANY (www.priceandcompany.com) METRO GRAND RAPIDS, MI 425 36TH STREET SW WYOMING, MI 49648-2108 1-800-248-8235 | | | |
| METRO DETROIT, MI 29165 WALL STREET WIXOM, MI 48393-3525 1-888-962-4300 | | | |

| | | | | |
|------------------------|------|-------|-------|------------|
| File Name: 140801C-500 | JDA | AH5 | MDP | 2020.03.10 |
| Issued | By | Appd | MDP | 2023.01.26 |
| Permit/Seal | Dwn. | Dsgn. | Chkd. | YYYY.MM.DD |

Client/Project Logo

PITTSFIELD CHARTER TOWNSHIP

Client/Project
PITTSFIELD CHARTER TOWNSHIP

Montbeller Park Improvements
Phase 2

Pittsfield Township, Michigan

Title

PROJECT DETAILS I

| | | | |
|---------------------------|------------|-------------------|----------------------------|
| Project No. 2075140801 | Sheet 0 | Scale 21 of 24 | Drawing No. C500 |
|---------------------------|------------|-------------------|----------------------------|




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Notes



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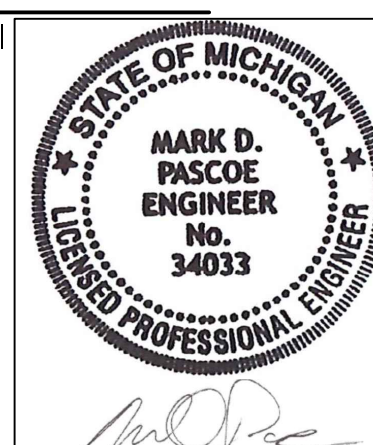
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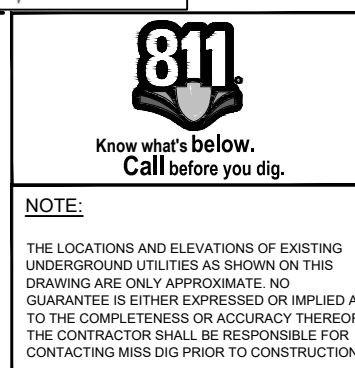
KEY NOTES

| | | | | |
|---------------|-----------------|------|-------|------------|
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| | | | | |
| A | BID SET PHASE 2 | CRW | MDP | 2023.01.26 |
| Issued | | By | Appd | YYYY.MM.DD |
| File Name: | 140801L-100 | JDA | AMS | MDP |
| | | Dwn. | Dgan. | Chkd. |
| | | | | YYYY.MM.DD |

Permit/Sea

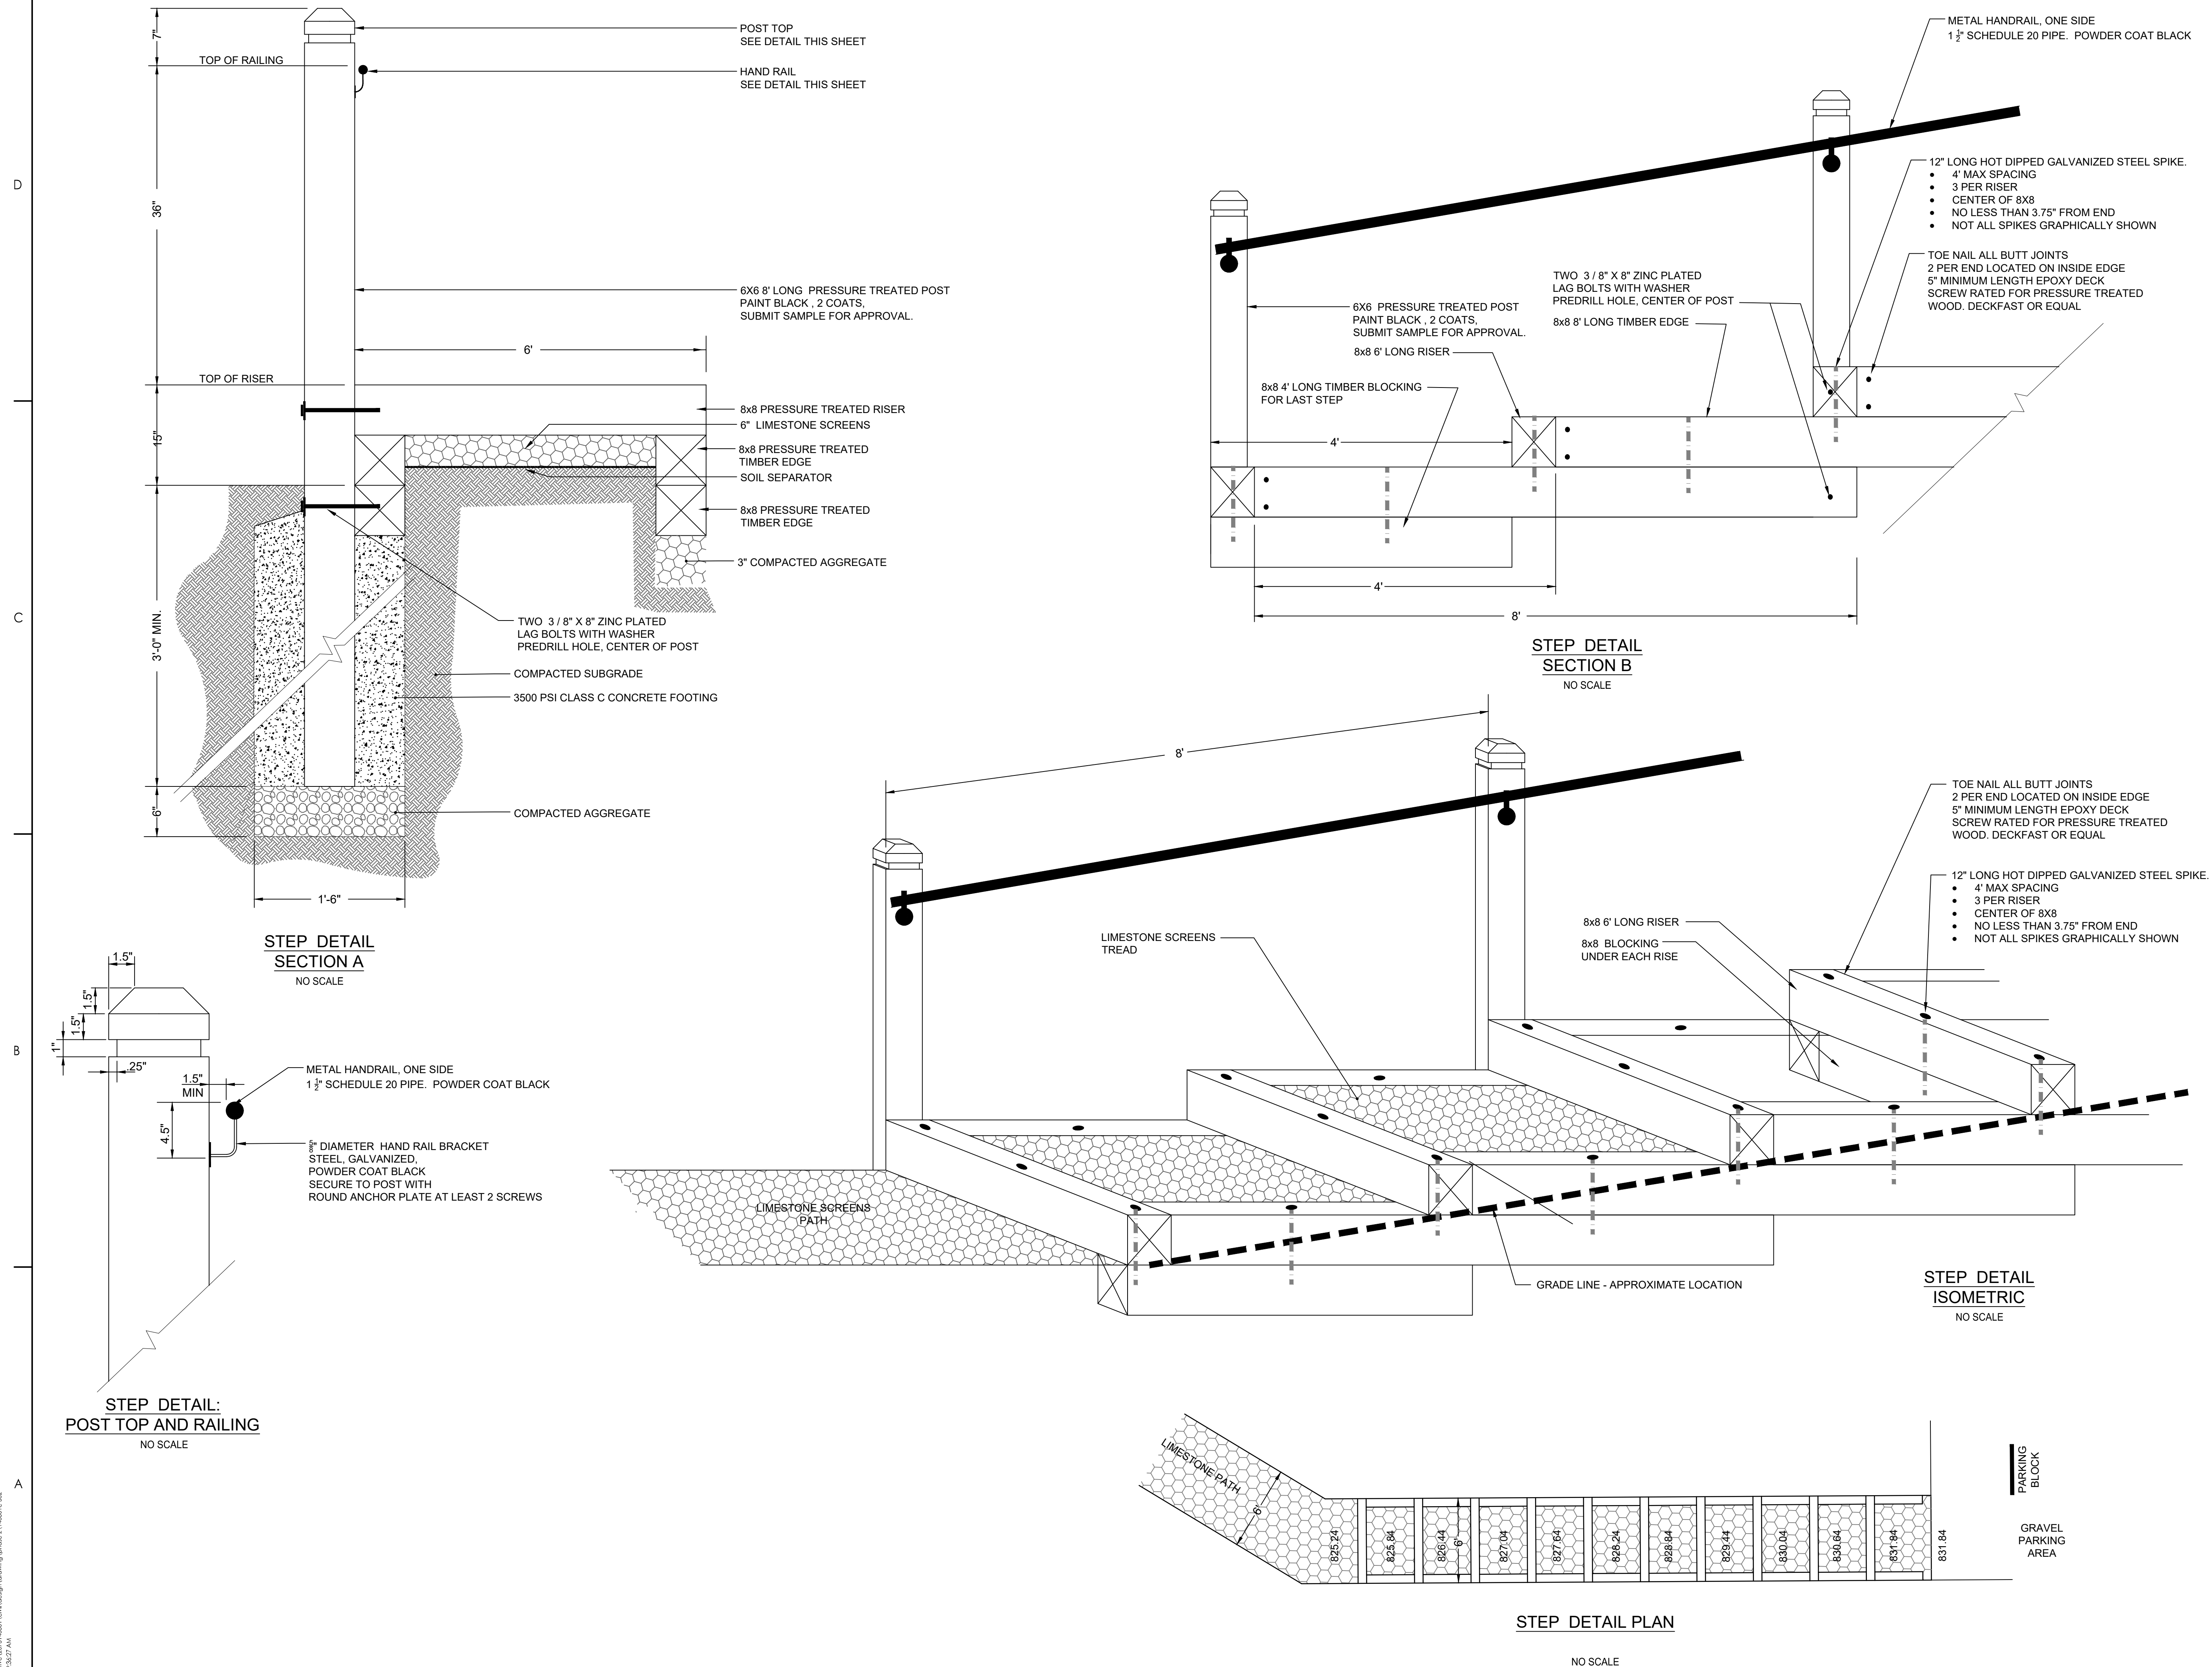

Client/Project Logo



Client/Project

PITTSFIELD CHARTER TOWNSHIP

MONTIBELLER PARK IMPROVEMENTS
PHASE 2

Pittsfield Township, Michigan

Title


LANDSCAPE PLAN

Project No.
207514080

Scale
0 40' 80'

Revision Sheet
0 24 of 24

Drawing No.
L100

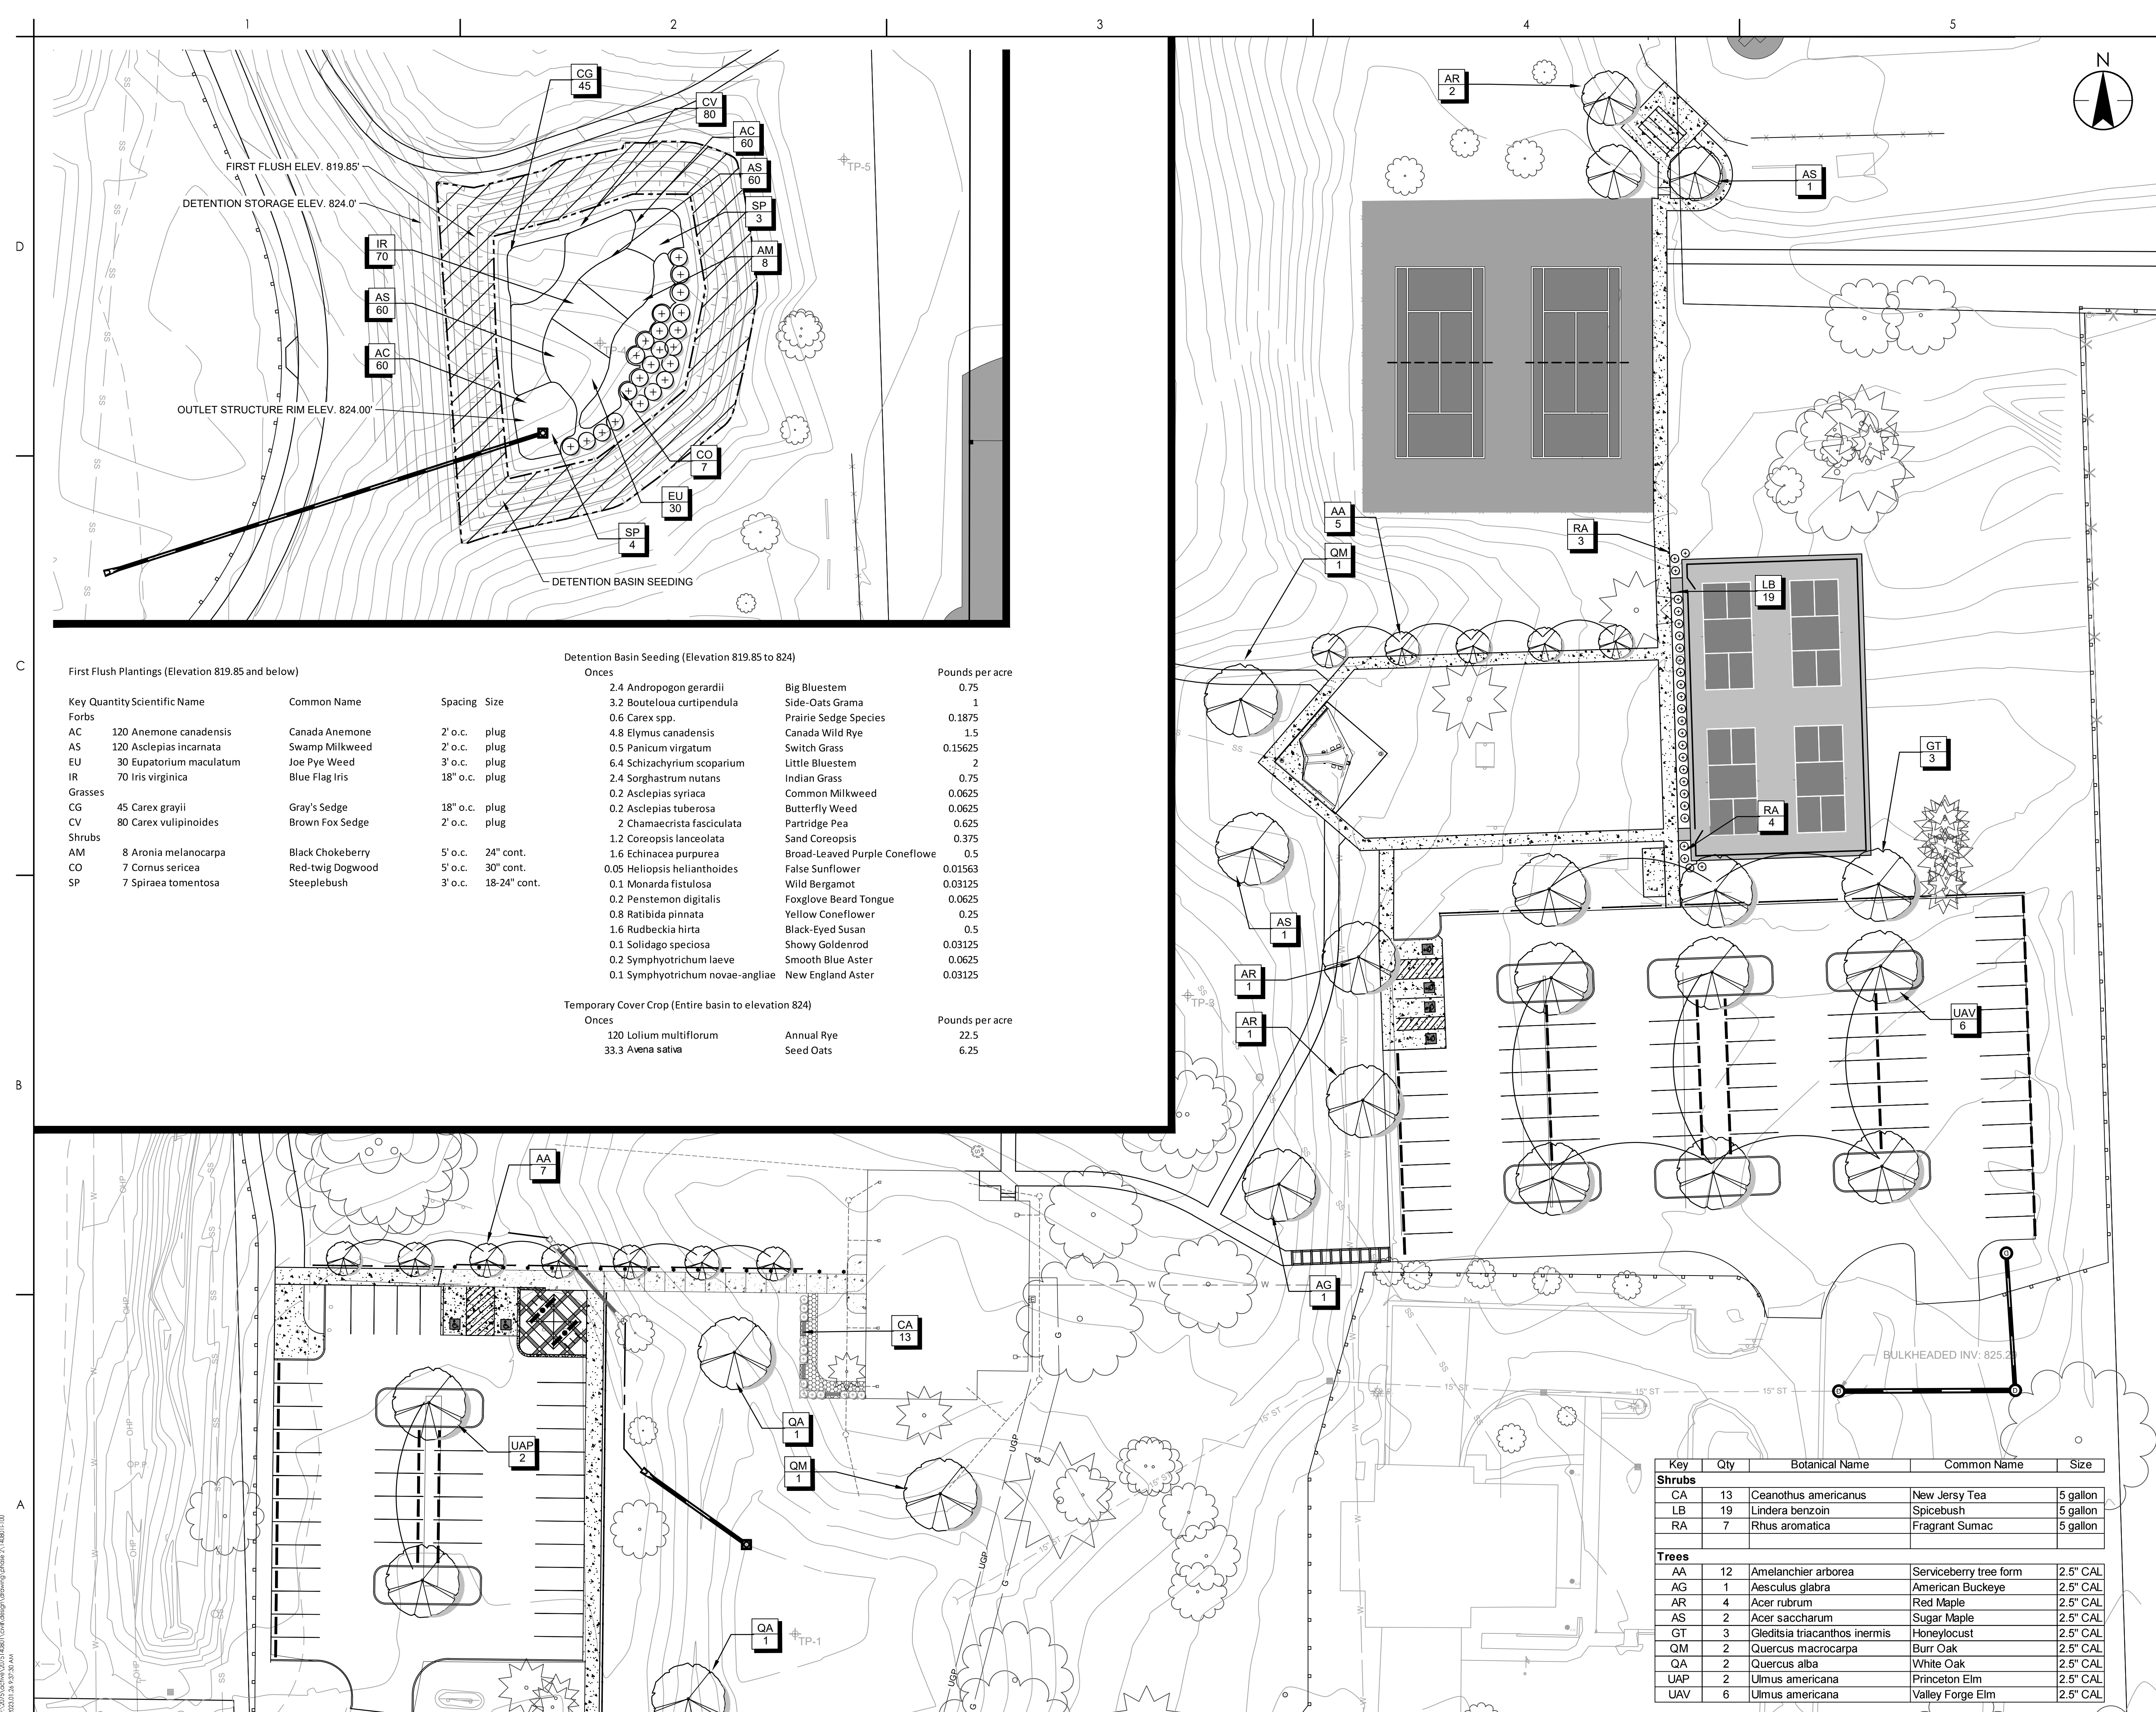

\\2075\active\2075140601\civil\design\drawing\phase 2\140601H100