CONSTRUCTION PLANS

FOR

INDEPENDENCE TOWNSHIP

- Bay Court Park Pole Barn -



SOIL EROSION CONTROL PERMIT
CONTRACTOR SHALL OBTAIN SESC PERMIT FROM THE OAKLAND COUNTY
PRIOR TO PERFORMING ANY PROPOSED WORK ON THE PROJECT

BUILDING PERMIT


CONTRACTOR SHALL OBTAIN BUILDING PERMIT FROM INDEPENDENCE TOWNSHIP PRIOR TO PERFORMING ANY PROPOSED WORK ON THE PROJECT

ELECTRICAL PERMIT


CONTRACTOR SHALL OBTAIN ELECTRICAL PERMIT FROM INDEPENDENCE TOWNSHIP PRIOR TO PERFORMING ANY PROPOSED WORK ON THE PROJECT

MECHANICAL PERMIT

CONTRACTOR SHALL OBTAIN MECHANICAL PERMIT FROM INDEPENDENCE TOWNSHIP PRIOR TO PERFORMING ANY PROPOSED WORK ON THE PROJECT

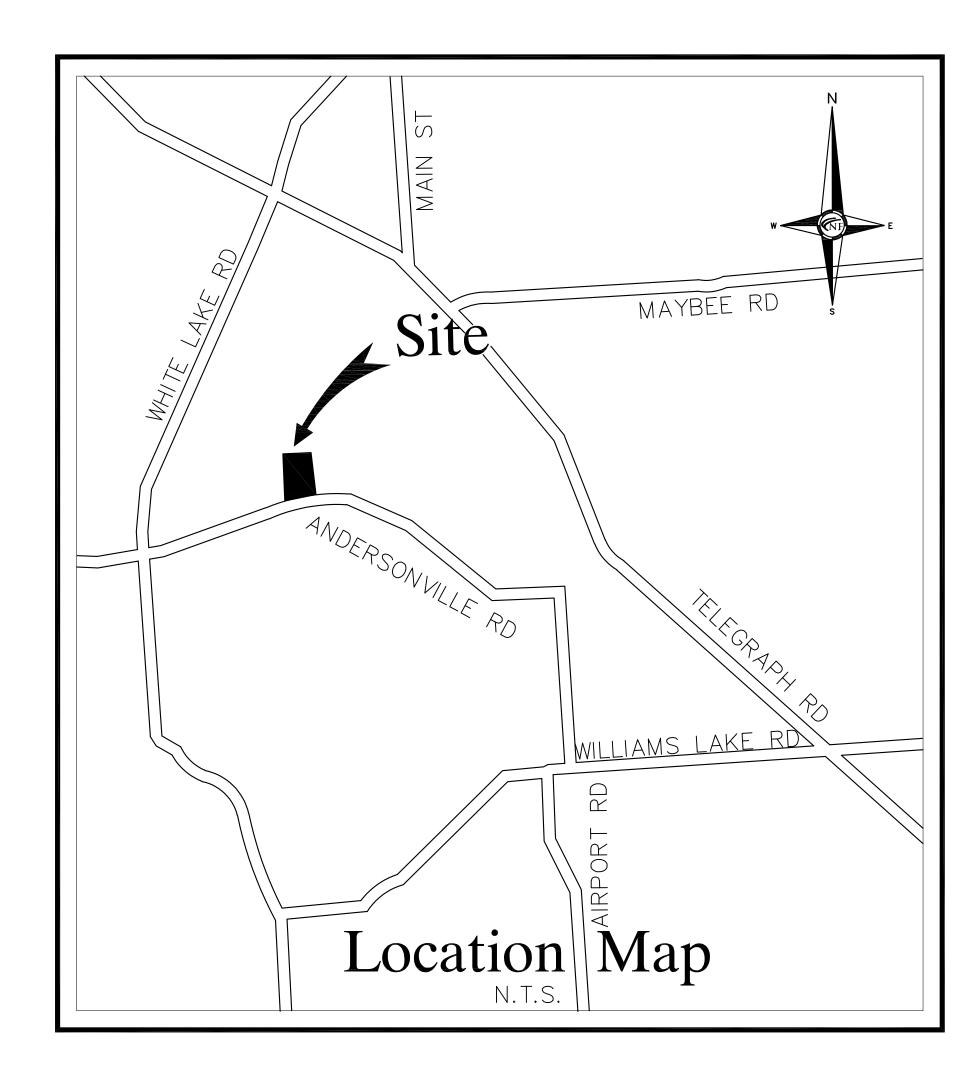

Section 32 T.4N., R.9E. Independence Township, Oakland County, Michigan

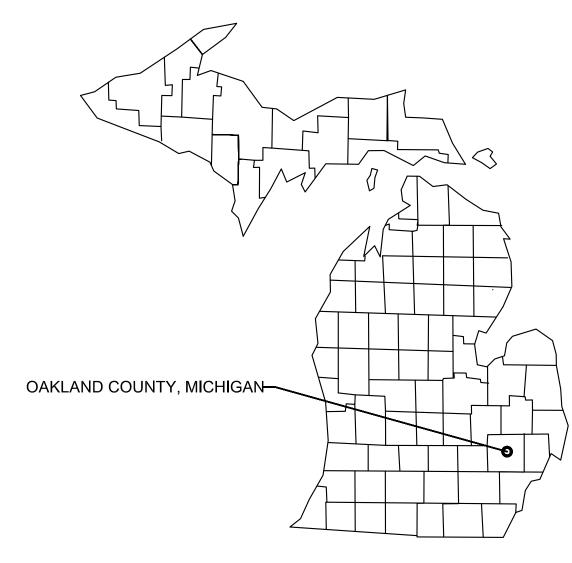

VICINITY MAP

ENGINEERS CIVIL ENGINEERS LAND SURVEYORS

NOWAK & FRAUS ENGINEERS 46777 WOODWARD AVE. PONTIAC, MI 48342-5032 TEL. (248) 332-7931 FAX. (248) 332-8257

LAND PLANNERS

SEAL

PROJECT

Independence Township -Bay Court Park Pole Barn

CLIENT
Independence Township

macpendence 10 mamp

Contact: Derek Smith

Phone: (248)-625-8223 Fax: (248)-620-7454 Email: dosmith@nfe-engr.com

PROJECT LOCATION

Part of the SW ½
of Section 32
T. 4N, R. 9E
City of Clarkston,
Oakland County, Michigan

SHEET

Topographic Survey



DATE	ISSUED/REVISED
8-02-22 OW	NER REVIEW
8-23-22 OWI	NER REVIEW
9-16-22 ISSU	ED FOR BID

DRAWN BY:

DESIGNED BY:

APPROVED BY:

EMAIL CONTACT:

9/16/22

SCALE:

M383-01 SHEET NO.
Title

CIVIL ENGINEER

NF

CIVIL ENGINEERS
LAND SURVEYORS
LAND PLANNERS

46777 WOODWARD AVENUE PONTIAC, MI 48342-5032 TEL. (248) 332-7931 FAX. (248) 332-8257 **ELECTRICAL ENGINEER**



DS ARCHITECTS, INC
7300 DIXIE HWY. #600


ARCHITECT


DSARCHITECTS.COM

T1 Cover Sheet C1 Topographic

Sheet Index

T1	Cover Sheet
C1	Topographic Survey of Project Area
C2	Site RemovalsPlan
C3	Proposed Site Plan
C4	Site Grading Plan
C5	SESC Plan
A1	Building Design Criteria
A2	Building Demolition/Foundation/Anchor Bolt Plans
A3	Building Floor/Shear Wall Panel/Framing & Roof Plans
A4	Building/Wall Section Details
A5	Building Elevations and Details
M100	Mechanical Plans
E100	Electrical Symbols/Abbreviations/Notes/Schedules
E300	Electrical Floor Plan - Demolition
E400	Electrical Floor Plan - Lighting and Power
E900	Electrical Panel-A Schedules

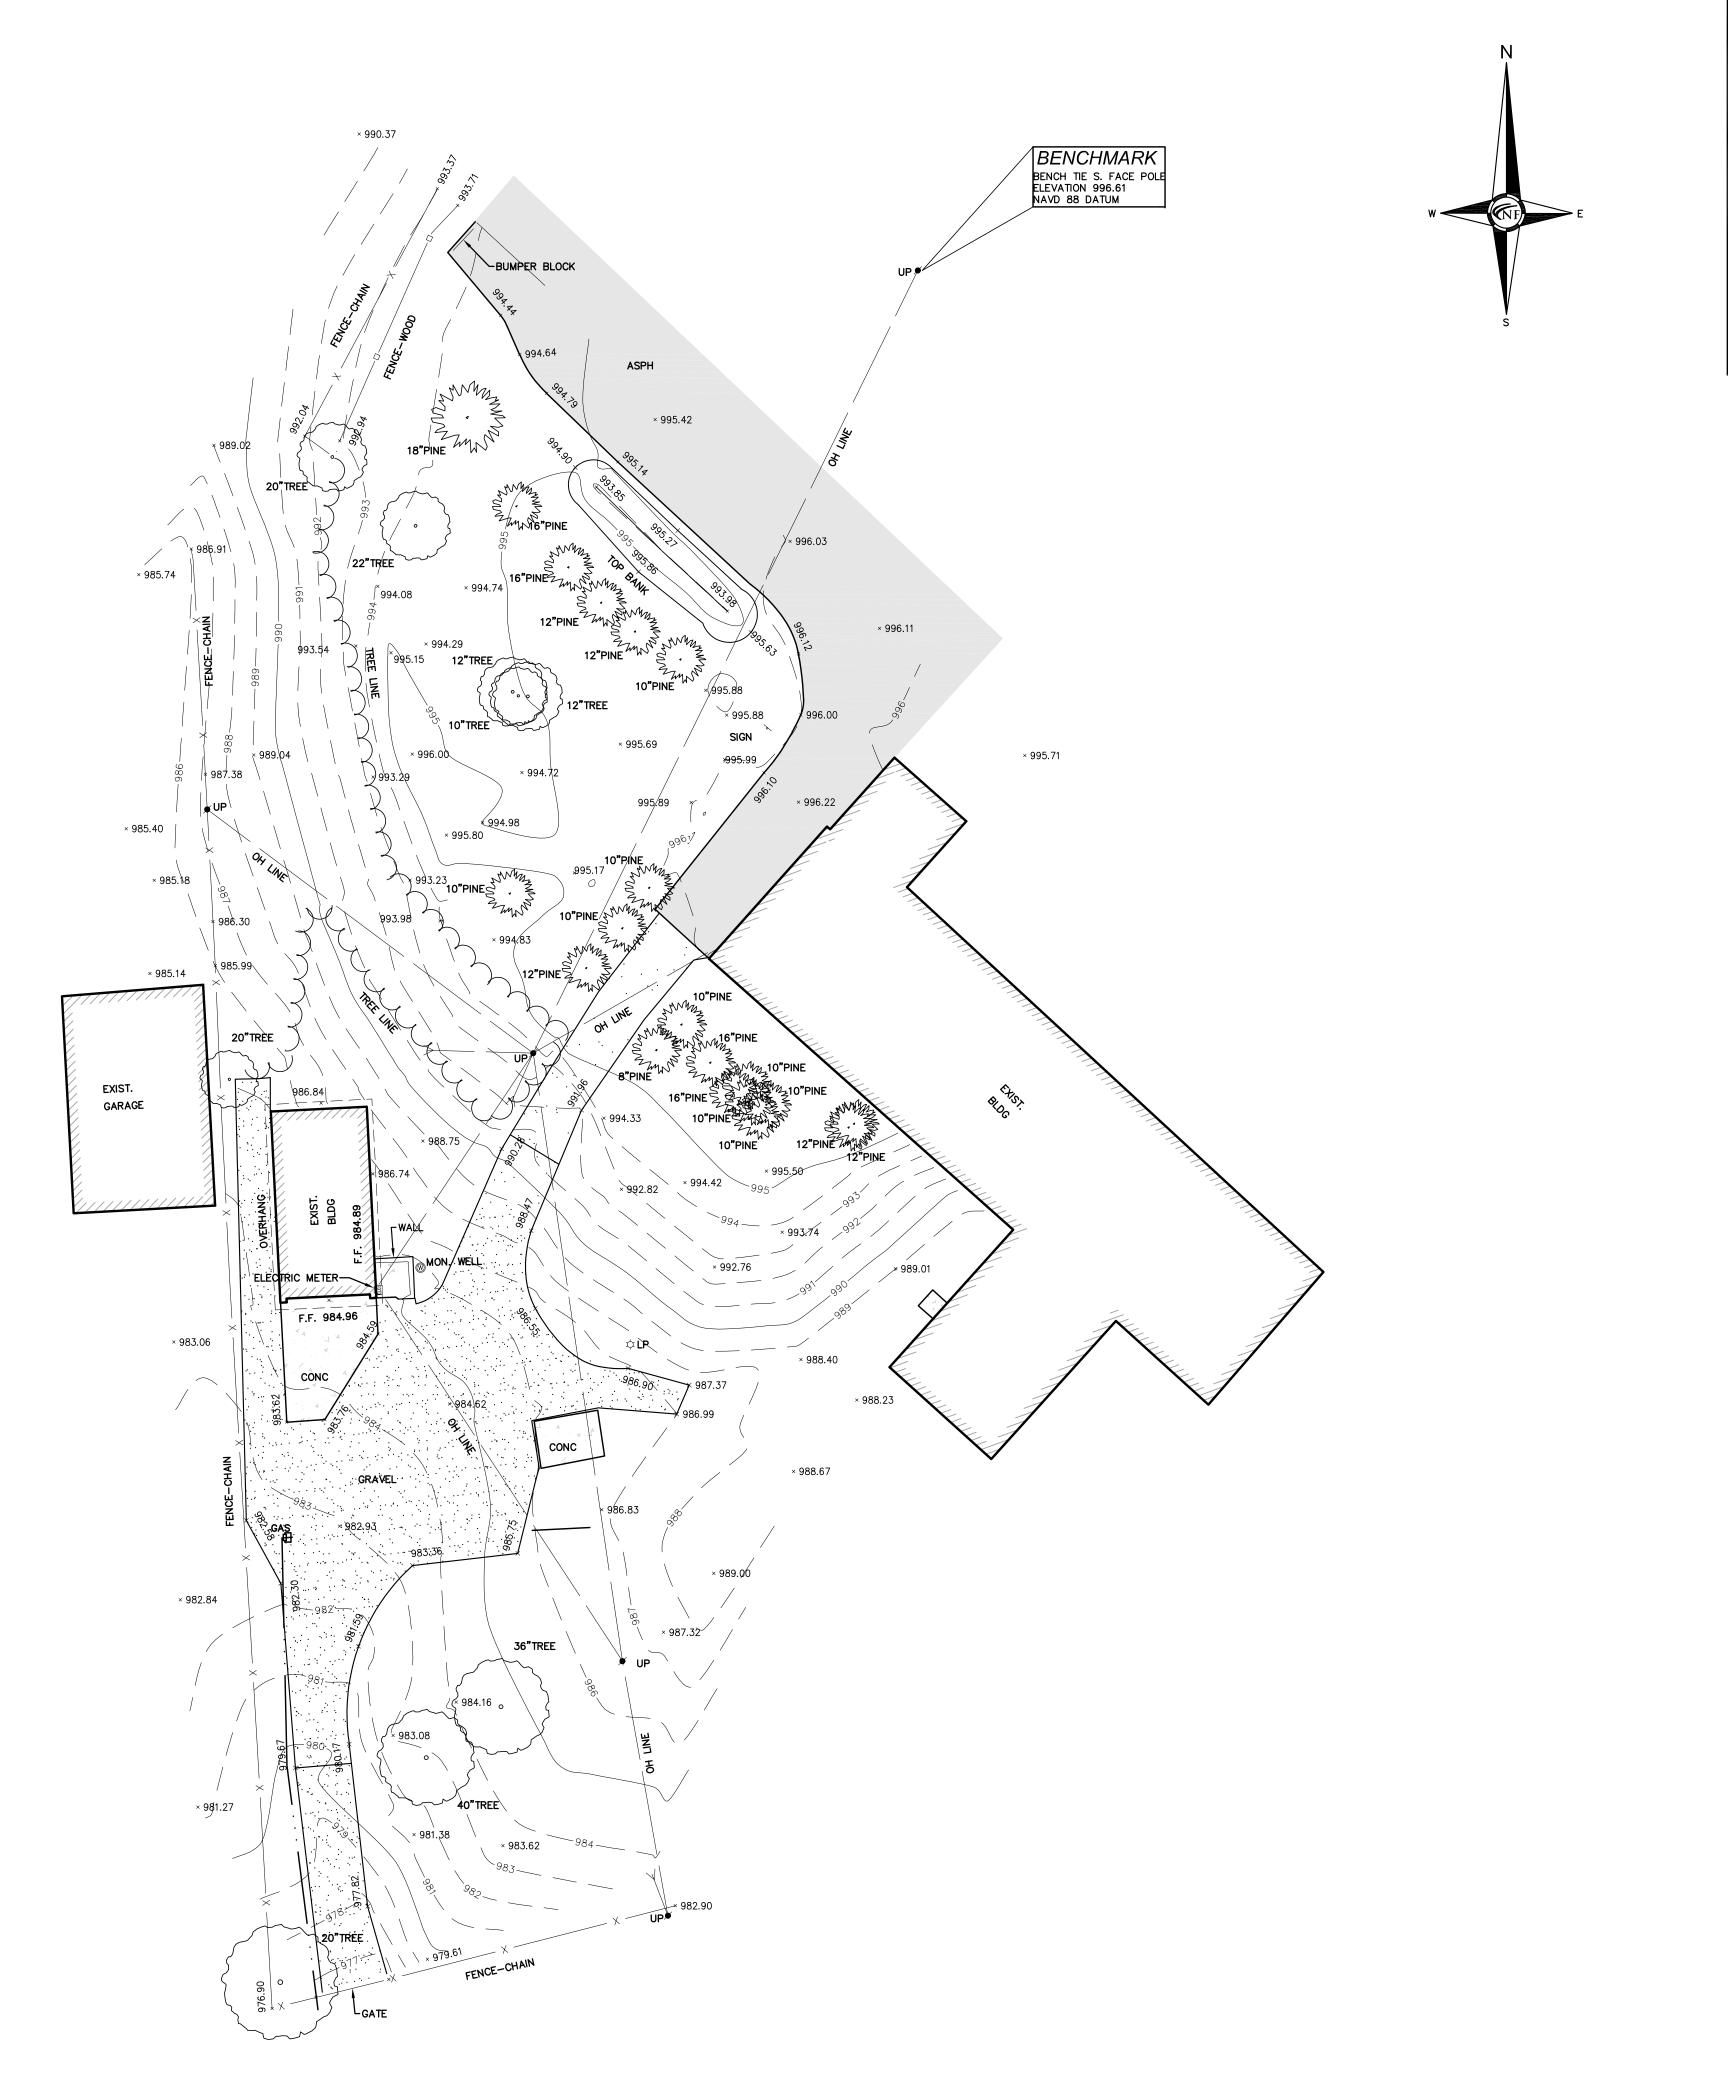

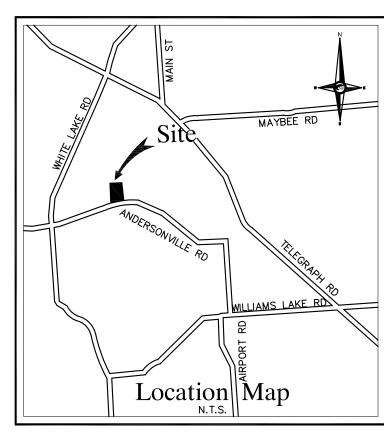



CIVIL ENGINEERS Land Surveyors Land Planners

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Independence Township -Bay Court Park Pole Barn

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PROJECT LOCATION

Part of the SW 1/4

of Section 32
T. 4N, R. 9E
City of Clarkston,
Oakland County, Michigan

SHEET

Topographic Survey



MISS DIG / UTILITY DISCLAIMER NOTE

A MISS DIG TICKET NUMBER 2022052300854, PURSUANT TO MICHIGAN PUBLIC ACT 174 WAS ENTERED FOR THE SURVEYED PROPERTY. DUE TO THE EXTENDED REPORTING PERIOD FOR UNDERGROUND FACILITY OWNERS TO PROVIDE THEIR RECORDS, THE SURVEY MAY NOT REFLECT ALL THE UTILITIES AT THE TIME THE SURVEY WAS ISSUED ON 5/25/22. THE SURVEY ONLY REFLECTS THOSE UTILITIES WHICH COULD BE OBSERVED BY THE SURVEYOR IN THE FIELD OR AS DEPICTED BY THE UTILITY COMPANY RECORDS FURNISH PRIOR TO THE DATE THIS SURVEY WAS ISSUED. THE CLIENT AND/OR THEIR AUTHORIZED AGENT SHALL VERIFY WITH THE FACILITY OWNERS AND/OR THEIR AUTHORIZED AGENTS, THE COMPLETENESS AND EXACTNESS OF THE UTILITIES LOCATION.

TOPOGRAPHIC SURVEY NOTES

ALL ELEVATIONS ARE EXISTING ELEVATIONS, UNLESS OTHERWISE

UTILITY LOCATIONS WERE OBTAINED FROM MUNICIPAL OFFICIALS AND RECORDS OF UTILITY COMPANIES, AND NO GUARANTEE CAN BE MADE TO THE COMPLETENESS, OR EXACTNESS OF LOCATION.

THIS SURVEY MAY NOT SHOW ALL EASEMENTS OF RECORD UNLESS AN UPDATED TITLE POLICY IS FURNISHED TO THE SURVEYOR BY THE OWNER.

LEGEND	
MANHOLE S	EXISTING SANITARY SEWER
——————————————————————————————————————	EXISTING SAN. CLEAN OU
GATE VALVE	EXISTING WATER MAIN
MANHOLE CATCH BASIN ————————————————————————————————————	EXISTING STORM SEWER
X	EX. R.Y. CATCH BASIN
UTILITY POLE GUY POLE	EXISTING BURIED CABLES
₩ GUY \ WIRE	OVERHEAD LINES
禁	LIGHT POLE
4	SIGN
· · · ·	EXISTING GAS MAIN


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8-02-22 OWN	NER REVIEW
8-23-22 OWN	IER REVIEW
9-16-22 ISSU	ED FOR BID


C. Herren DESIGNED BY: APPROVED BY:	
TZ NT 1'	
K. Navaroli	
EMAIL CONTACT:	
knavaroli@nfe-engr.com	
DATE:	
6/2/22	

NFE JOB NO. **M383-01**

SHEET NO.

C1

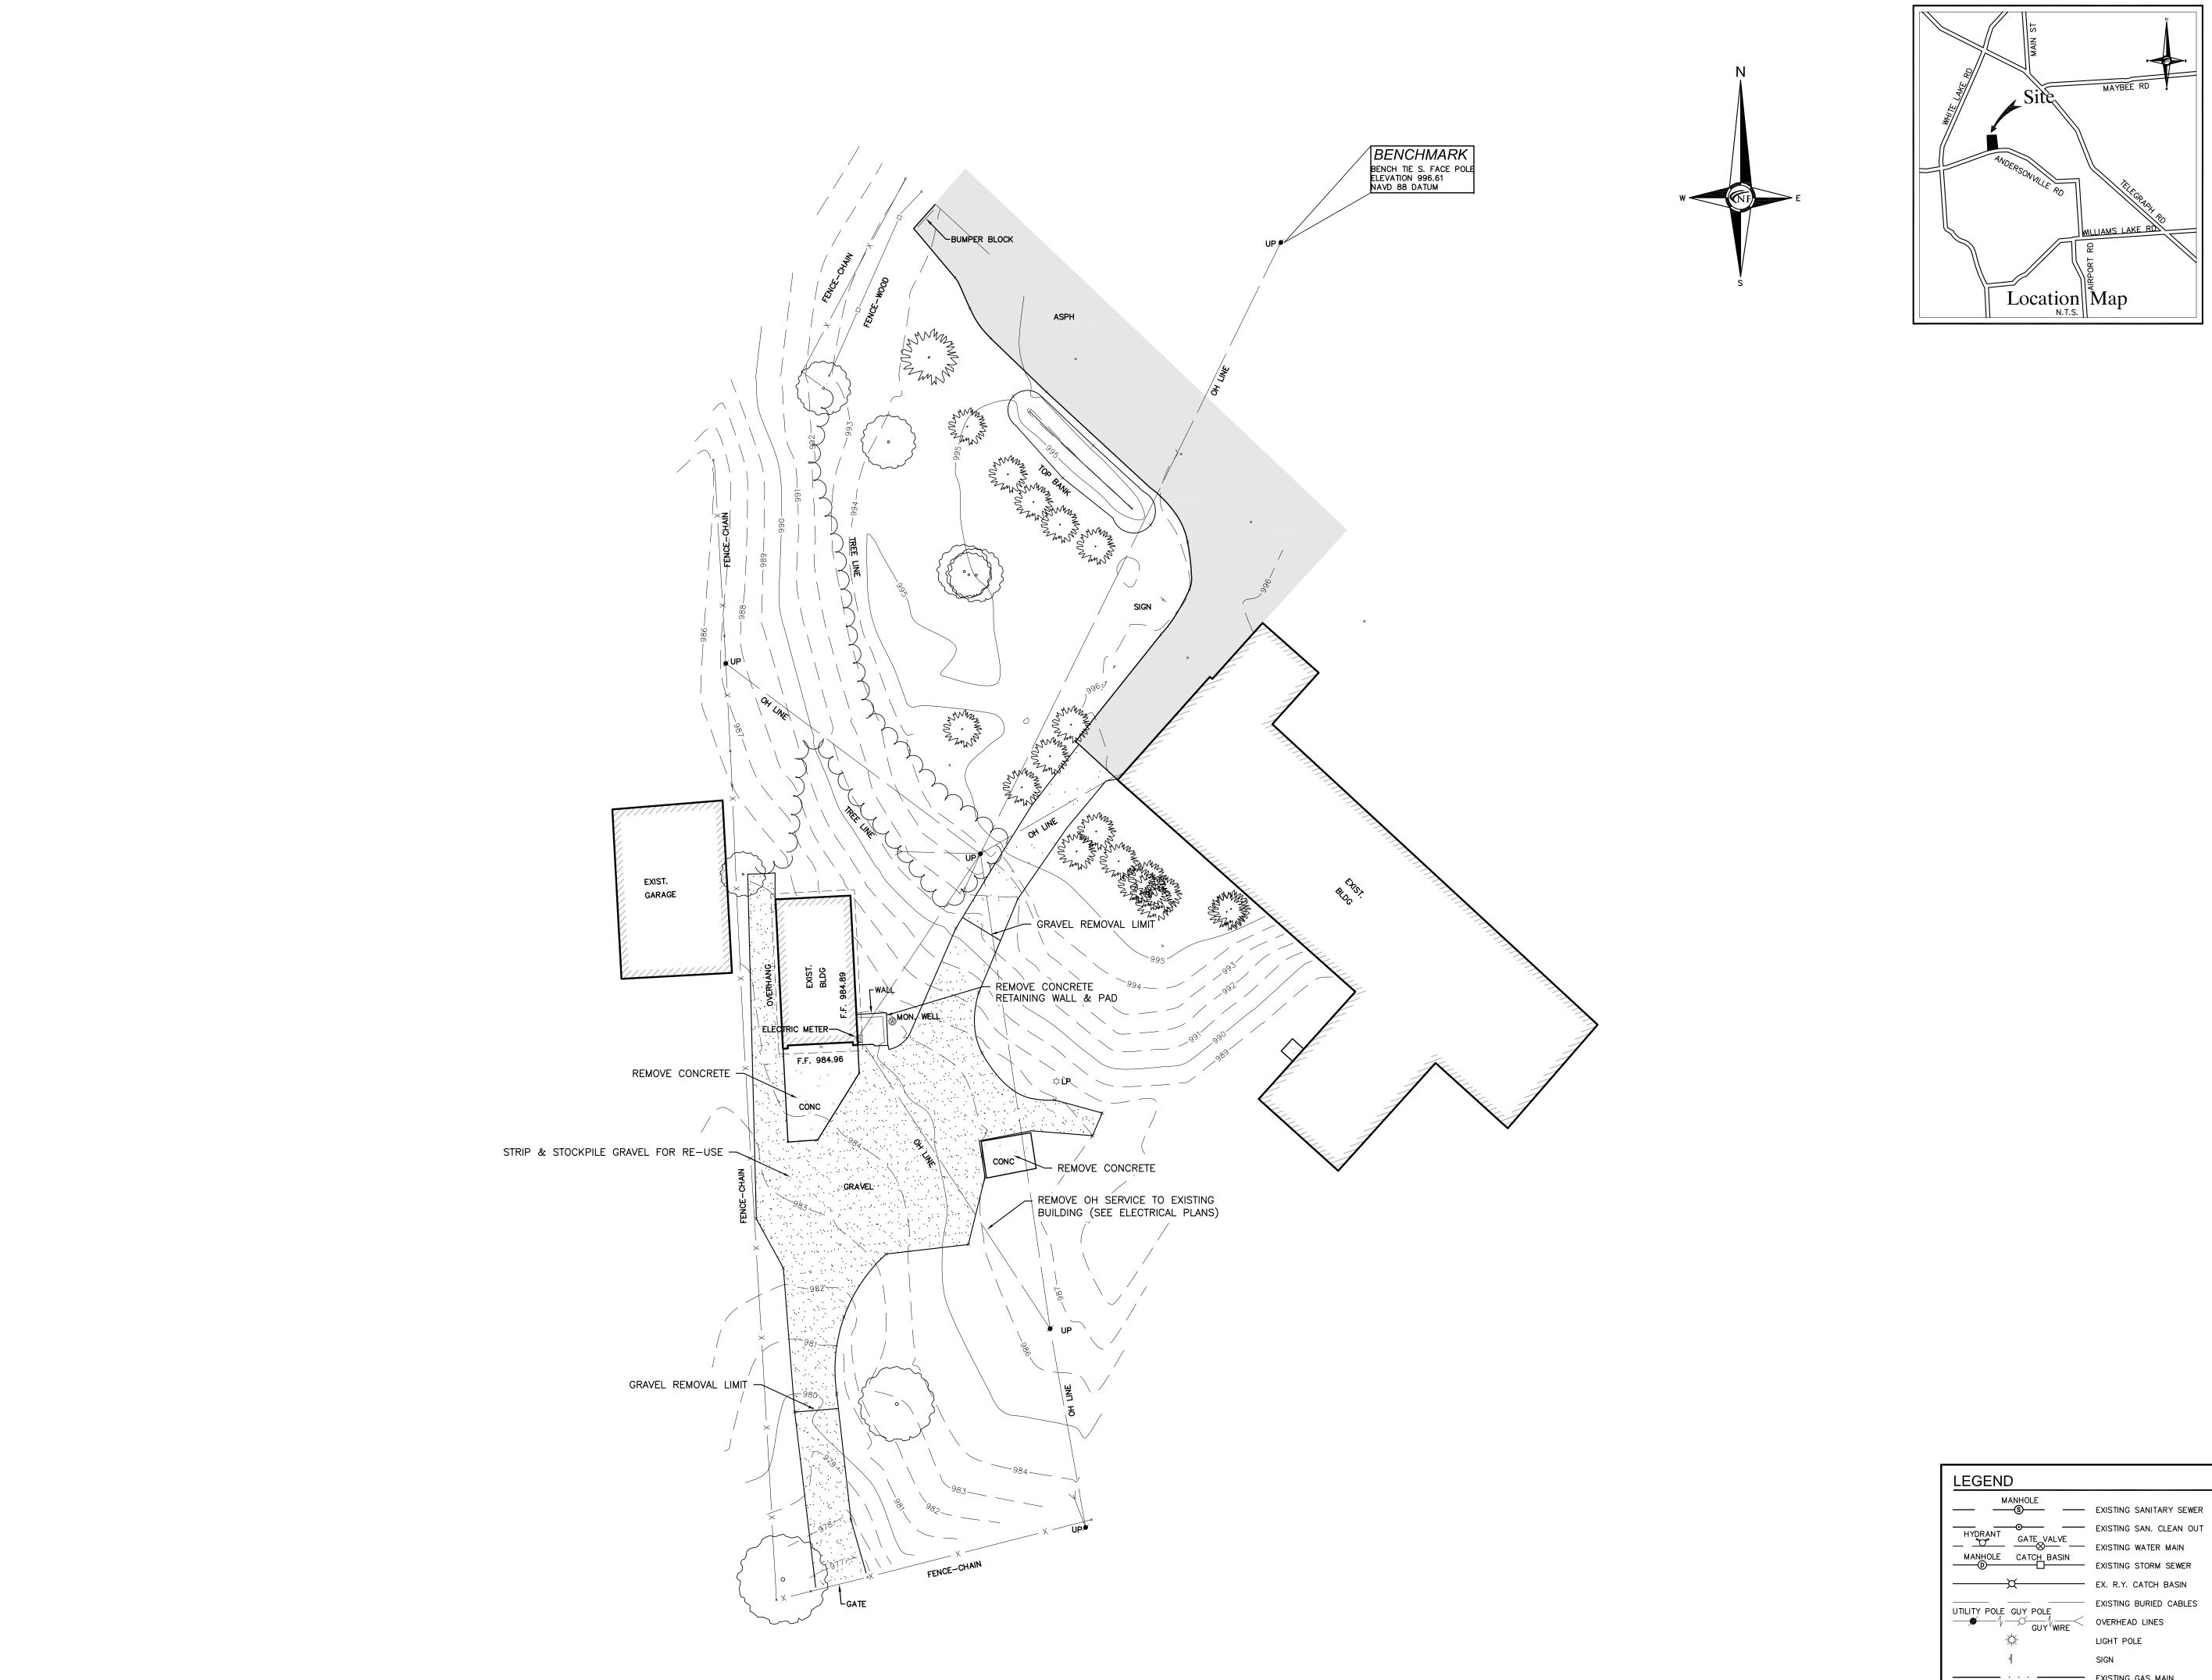

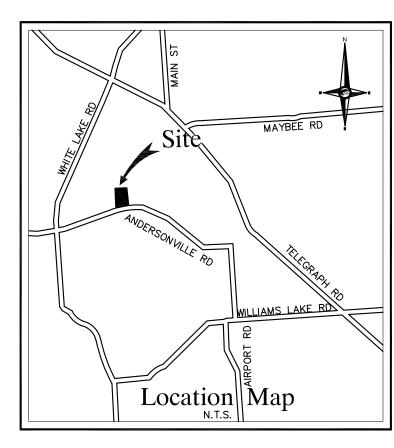



LAND SURVEYORS LAND PLANNERS

NOWAK & FRAUS ENGINEERS 46777 WOODWARD AVE. PONTIAC, MI 48342-5032 TEL. (248) 332-7931 FAX. (248) 332-8257

Independence Township -Bay Court Park Pole Barn

Independence Township

Contact: Derek Smith Phone: (248)-625-8223 Fax: (248)-620-7454 Email: dosmith@nfe-engr.com

PROJECT LOCATION Part of the SW ½ of Section 32 T. 4N, R. 9E City of Clarkston,

Oakland County, Michigan

SHEET

Site Removals Plan



DATE ISSUED/REVISED 8-02-22 OWNER REVIEW 8-23-22 OWNER REVIEW 9-16-22 ISSUED FOR BID

DRAWN BY: K. Ruiter **DESIGNED BY:** K. Ruiter APPROVED BY:

S. Sutton EMAIL CONTACT:

kruiter@nfe-engr.com DATE:

8/02/22 SCALE: 1'' = 20'


MANHOLE CATCH BASIN EXISTING STORM SEWER

EXISTING BURIED CABLES

SIGN

· · · EXISTING GAS MAIN

SHEET NO. NFE JOB NO. M383-01 **C2**

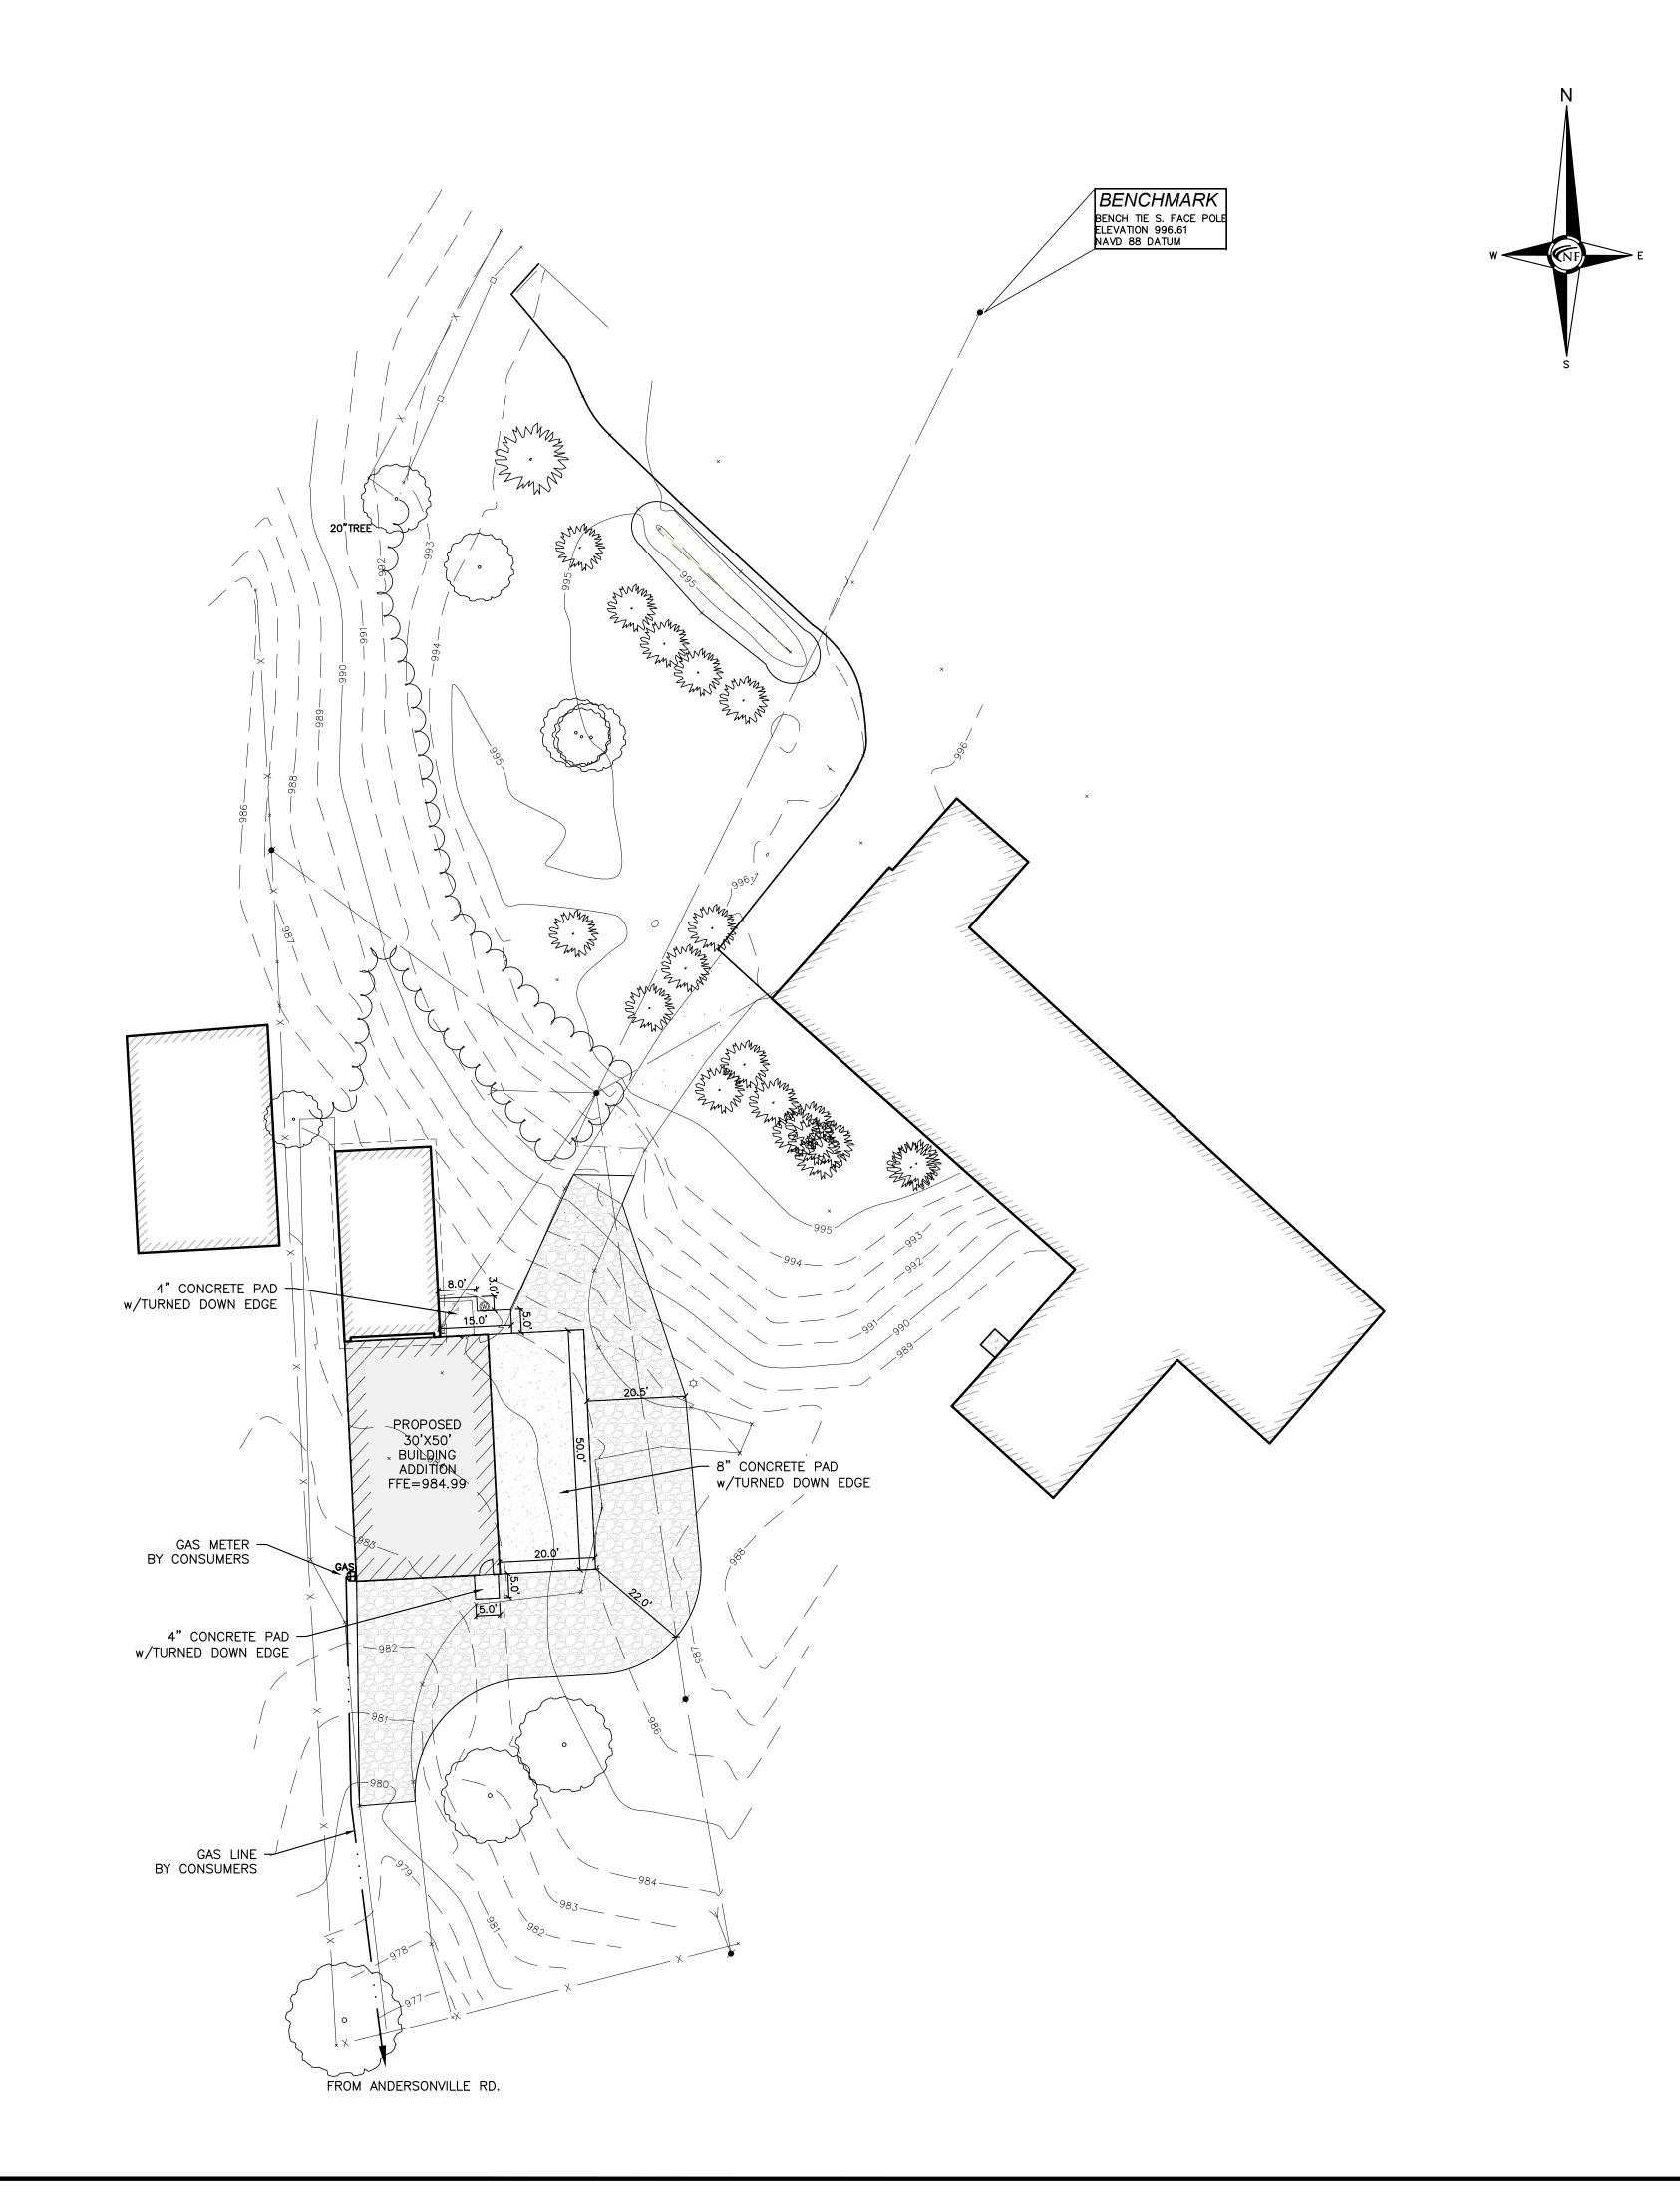

8" MDOT 21AA COMPACTED TO 95% BY PROCTOR

- EPOXY COATED RE-MESH MID SLAB 6x6 W1.4/W1.4 PER ASTM A884

— CLASS A CONCRETE (3500 PSI MIN.) - M.D.O.T. CLASS II

(OR SALVAGE GRAVEL)

— CLASS A CONCRETE (3500 PSI MIN.)

- M.D.O.T. 21AA COMPACT TO 95% BY PROCTOR

SLOPE PER PLANS

PROOF-ROLLED SUB BASE


PROOF-ROLLED SUB BASE

AGGREGATE DRIVE DETAIL

4" CONCRETE DETAIL

8" CONCRETE DETAIL

APPROVED SUBGRADE -

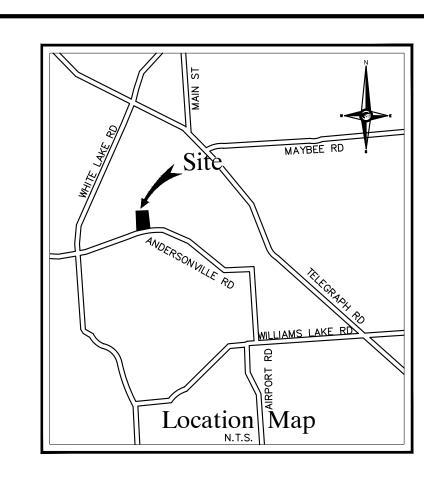



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dosmith@nfe-engr.com

PROJECT LOCATION Part of the SW ½ of Section 32 T. 4N, R. 9E City of Clarkston, Oakland County, Michigan

SHEET

Overall Site Plan

PROPOSED HATCH LEGEND

PROPOSED AGGREGATE SURFACE

PROPOSED CONCRETE SURFACE


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HYDRANT OATE WALVE	EXISTING SAN. CLEAN OUT
MANHOLE CATCH BASIN	EXISTING WATER MAIN
MANHOLE CATCH BASIN	EXISTING STORM SEWER
$-\!$	EX. R.Y. CATCH BASIN
UTILITY POLE GUY POLE	EXISTING BURIED CABLES
GUY WIRE	OVERHEAD LINES
禁	LIGHT POLE
٩	SIGN
···	EXISTING GAS MAIN





DATE ISSUED/REVISED 8-02-22 OWNER REVIEW 8-23-22 OWNER REVIEW 9-16-22 ISSUED FOR BID


DRAWN BY: K. Ruiter DESIGNED BY: K. Ruiter APPROVED BY: S. Sutton EMAIL CONTACT: kruiter@nfe-engr.com DATE: 8/02/22 SCALE: 1'' = 20'NFE JOB NO. SHEET NO. M383-01 **C3**

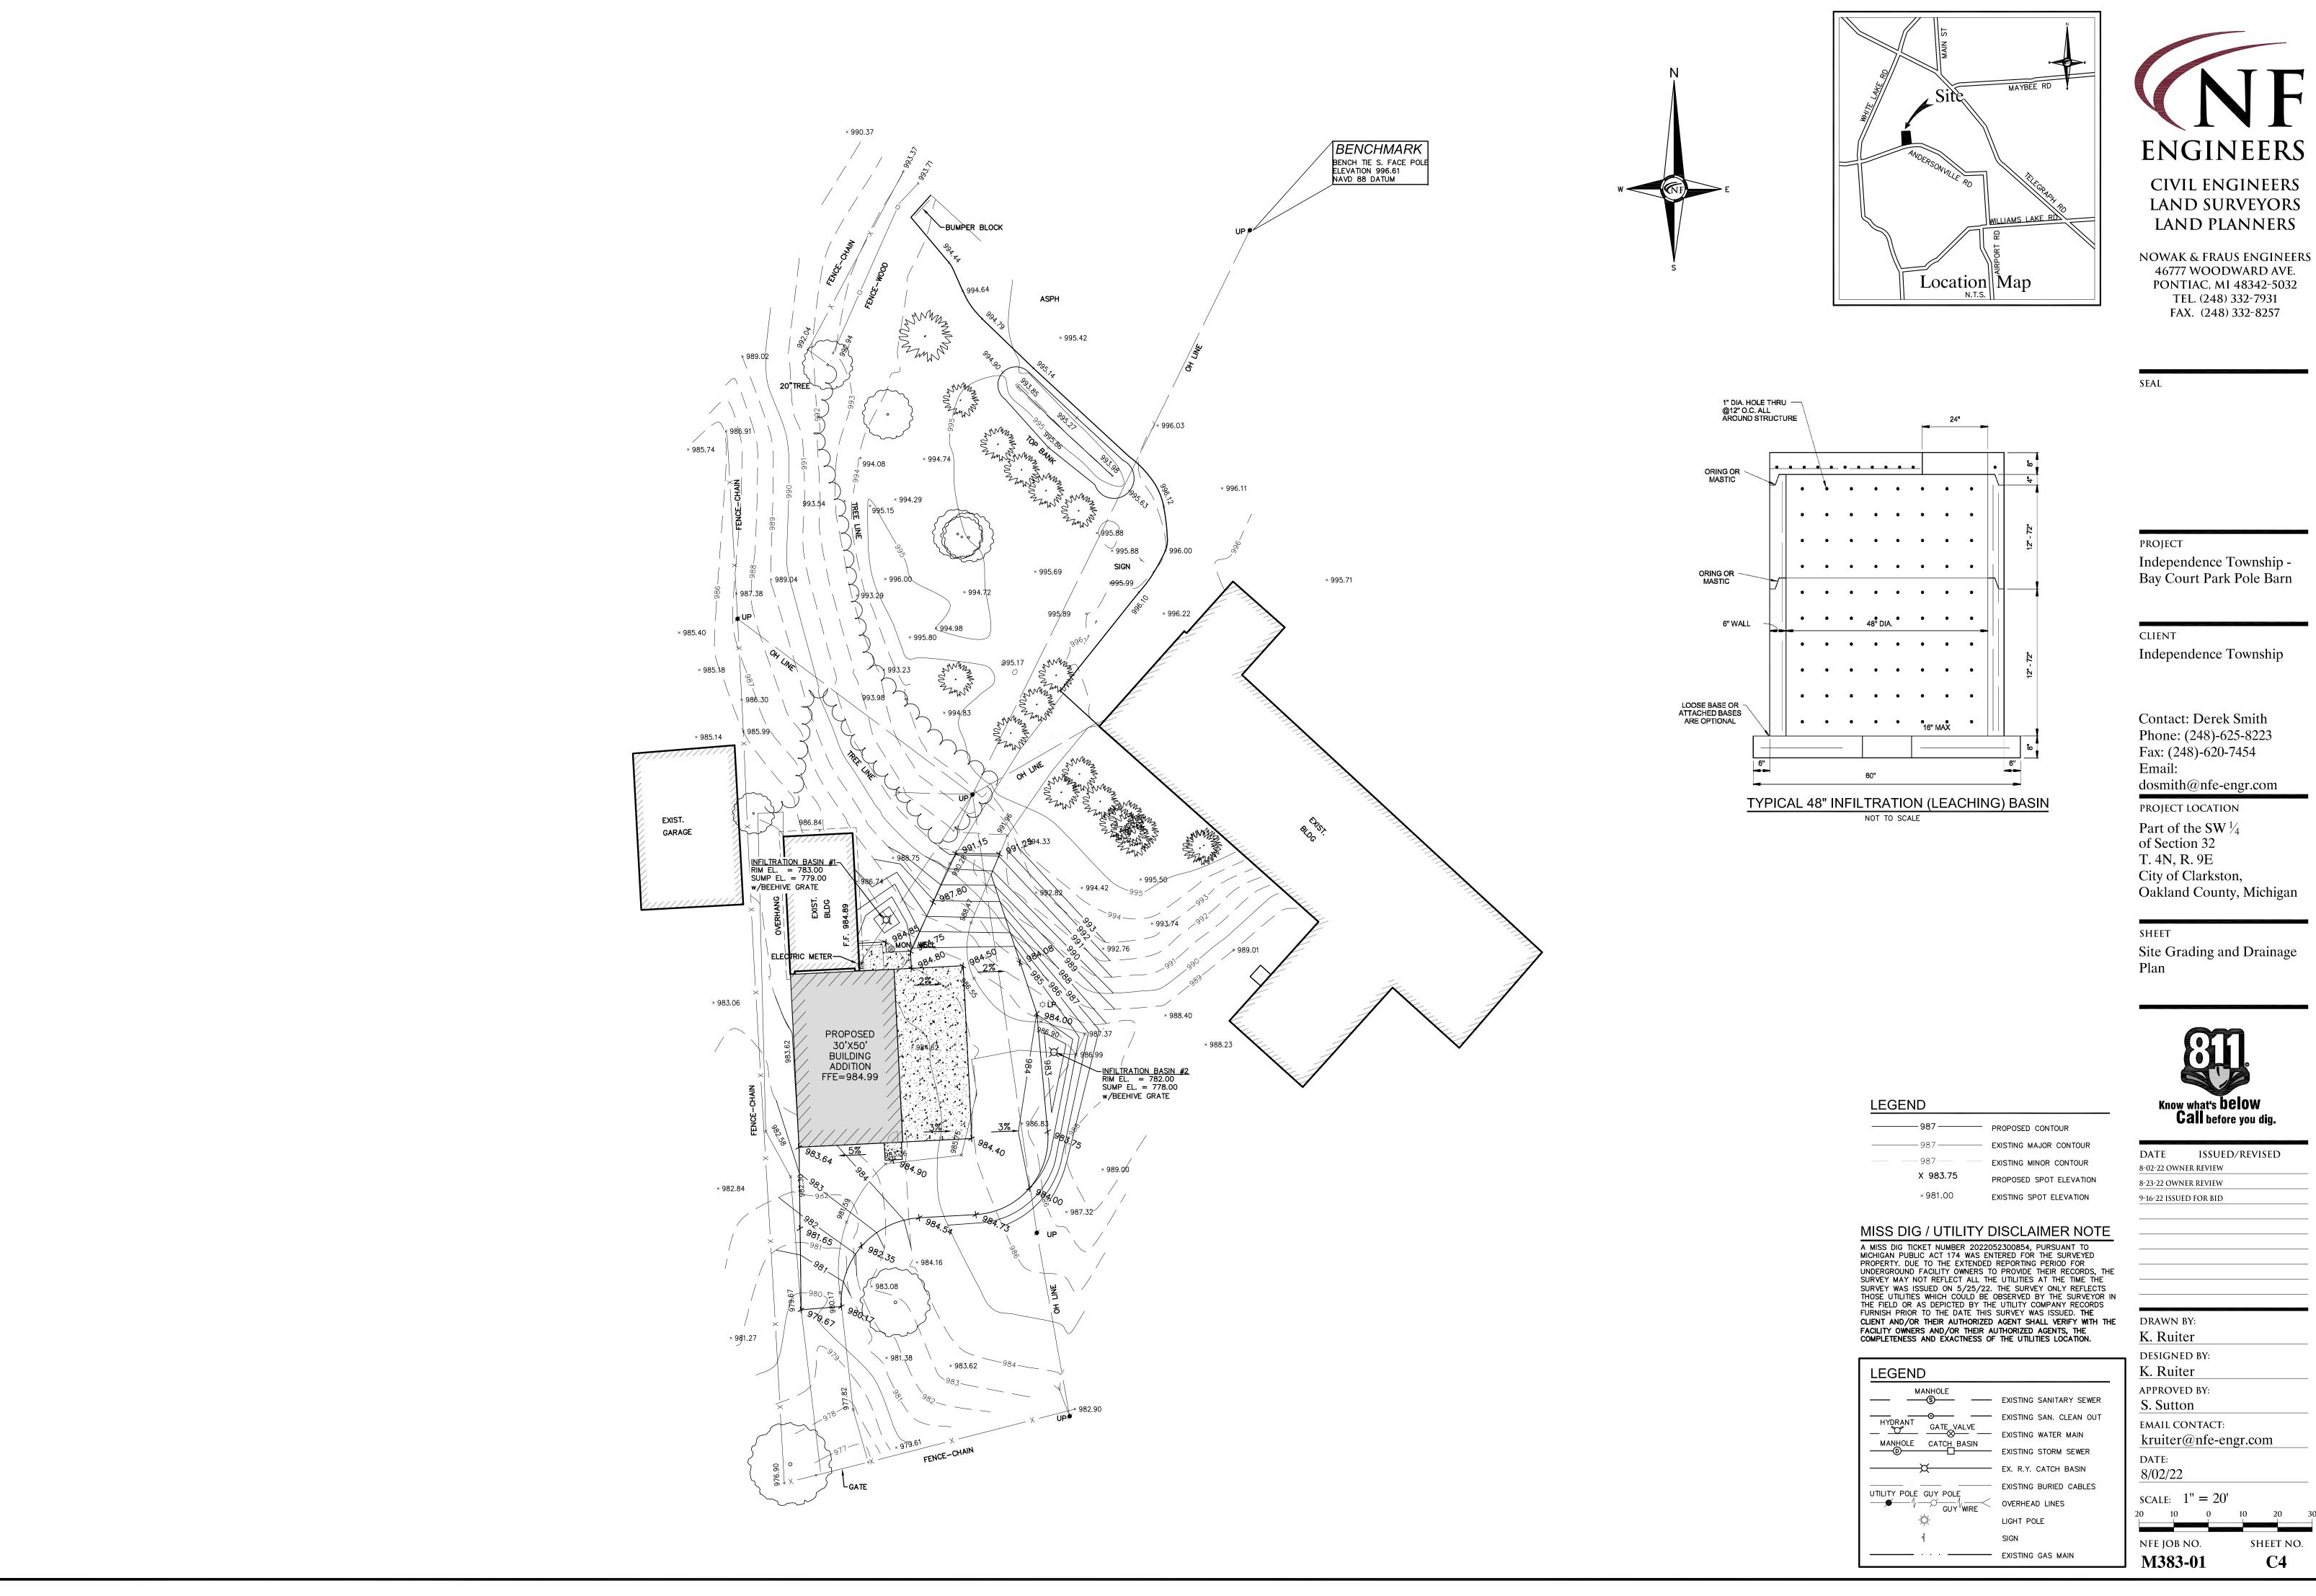


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DRAWN BY:		
K. Ruiter		_
DESIGNED BY:		
K. Ruiter		_
APPROVED BY:		
S. Sutton		_
MAIL CONTACT:		
kruiter@nfe-eng	gr.com	_
DATE:		
8/02/22		_
CALE: $1'' = 20'$		
$\begin{array}{ccc} \text{CALE.} & 1 & -20 \\ 10 & 0 \end{array}$	10 20	30
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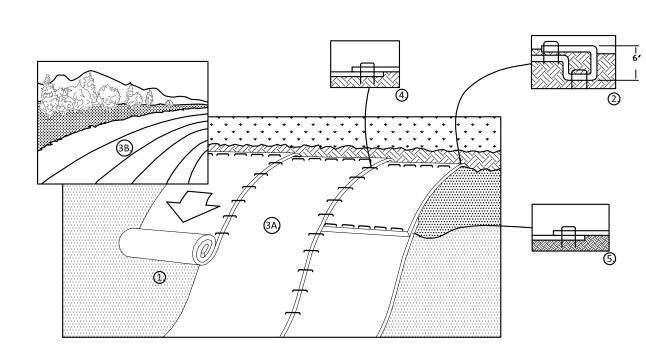


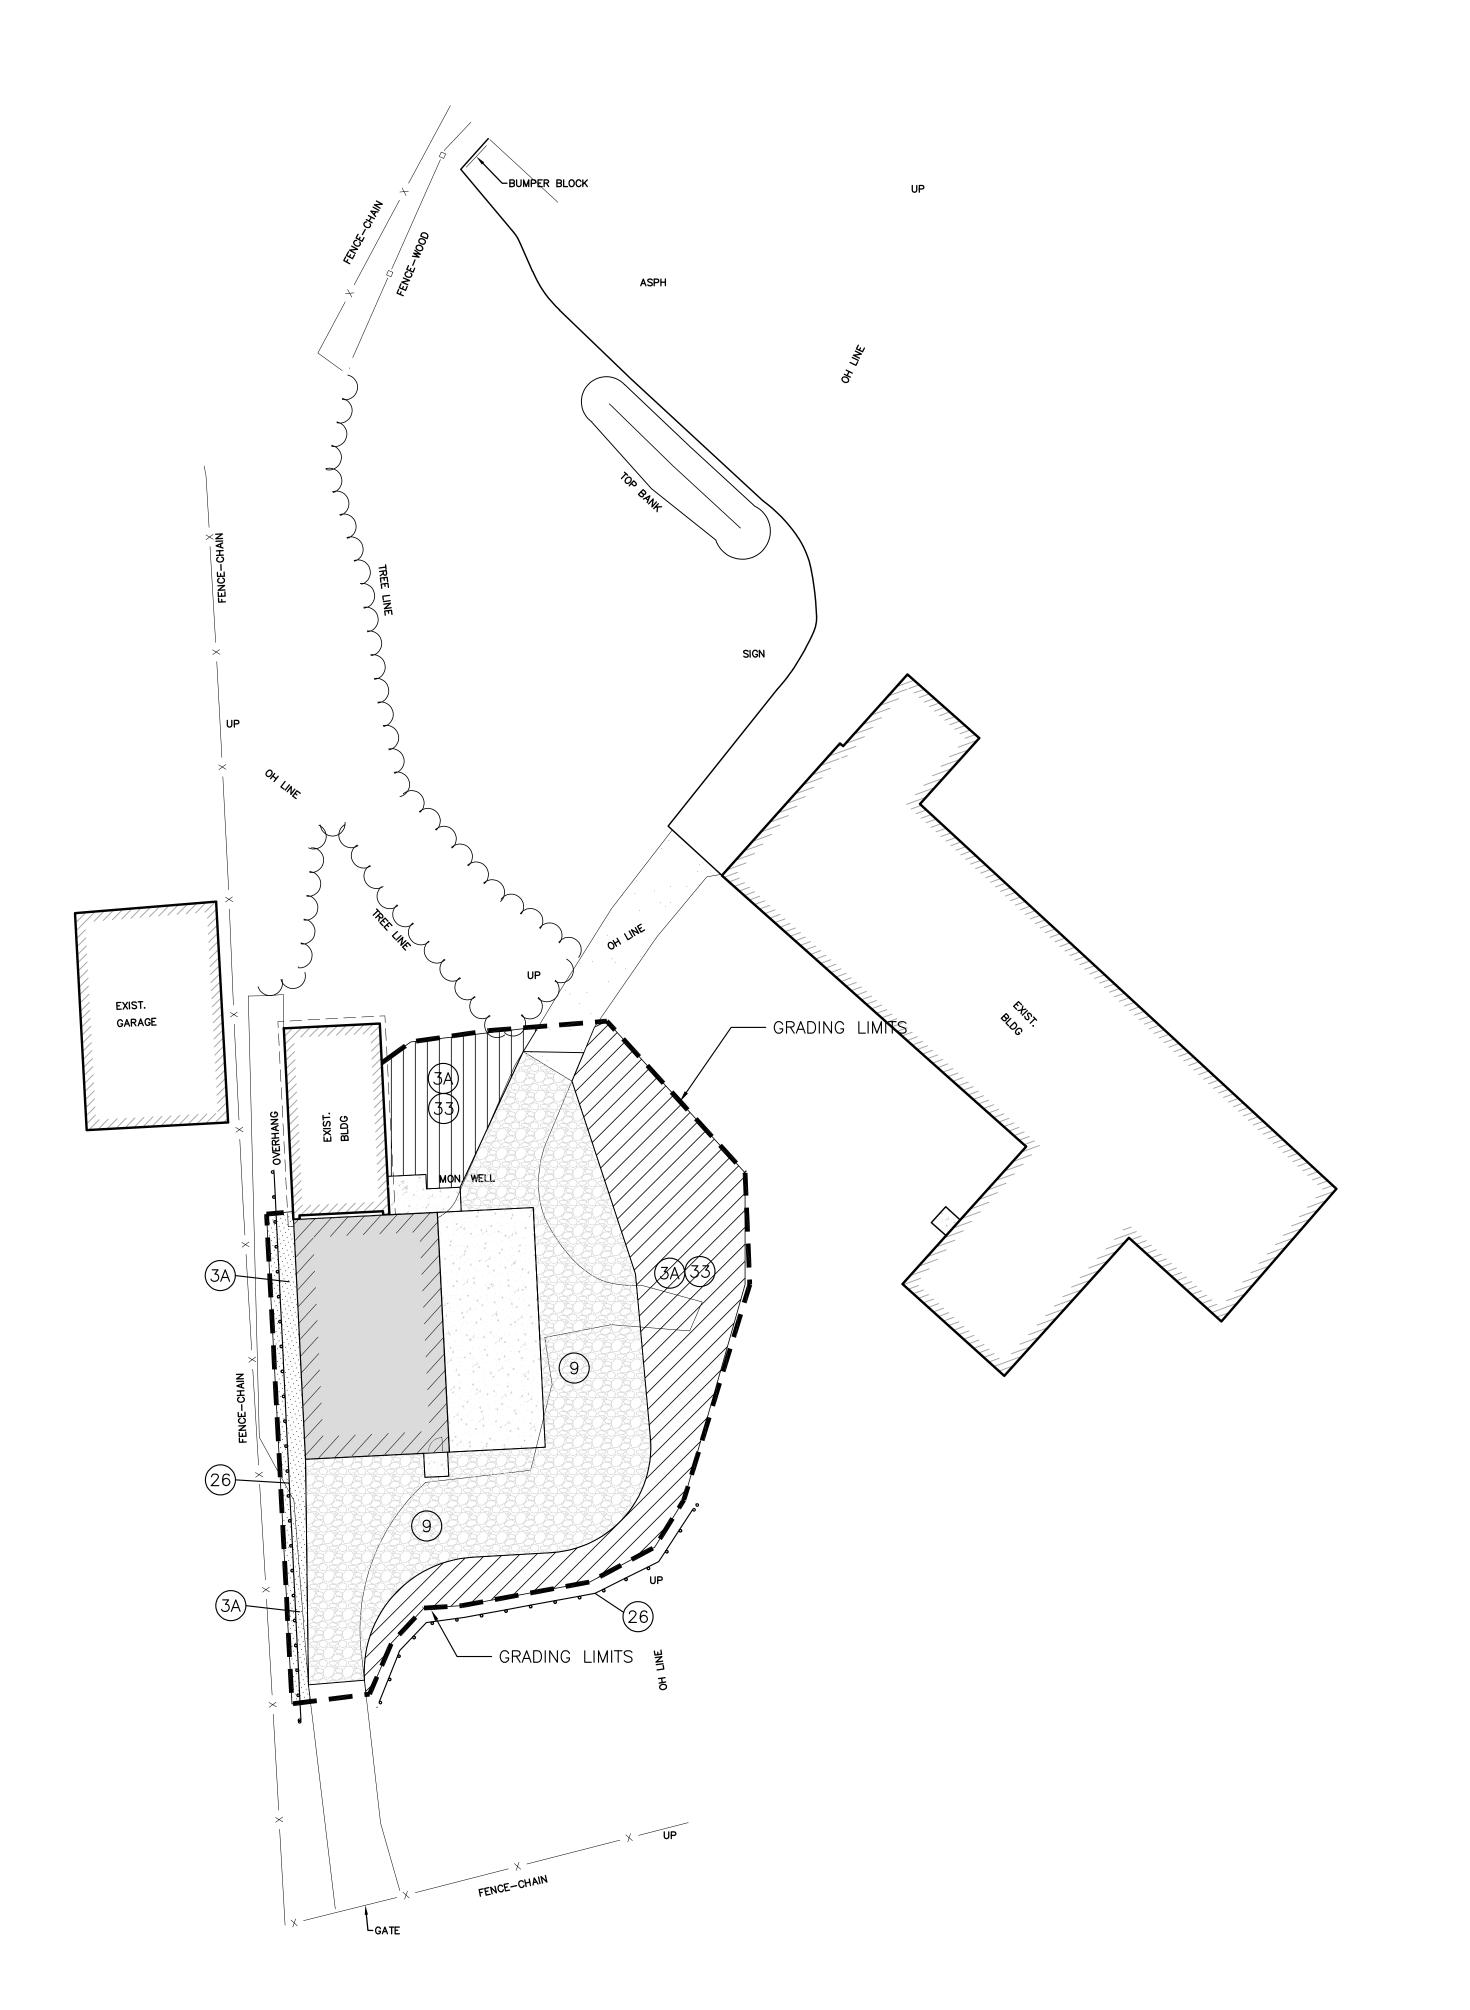

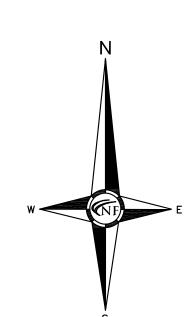

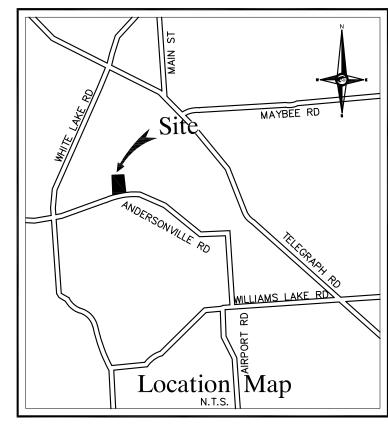

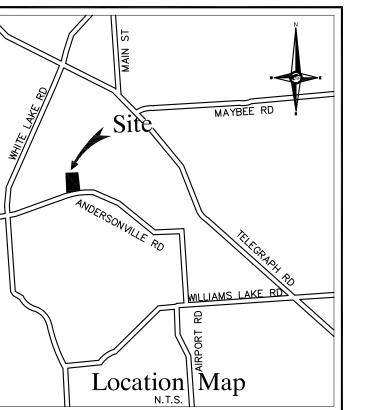S.E.S.C. TEMPORARY AND PERMANENT MEASURE LEGEND								
PLAN SYMBOL	KEY #	DESCRIPTION	NOTES					
	(3A)	PERMANENT SEEDING	TOPSOIL SEED AND STRAW MULCH					
	9	AGGREGATE COVER	PERMANENT AGGREGATE PARKING SURFACE					
	26)	SILT FENCE	REFER TO SILT FENCE DETAIL THIS SHEET					
	(33)	HIGH VELOCITY MULCH BLANKET	REFER TO "HIGH VELOCITY STRAW MULCH EROSION BLANKET" DETAIL THIS SHEET.					




INSTALLATION BEST PRACTICES 1. PREPARE SOIL BEFORE INSTALLING BLANKETS, APPLICATION OF SEED, FERTILIZER, AND MULCH.

- 2. BEGIN AT THE TOP OF THE SLOPE BY ANCHORING THE BLANKET IN A 6" DP X 6" W TRENCH WITH APPROXIMATELY 12" OF BLANKET EXTENDED BEYOND THE UP—SLOPE PORTION OF THE TRENCH. ANCHOR THE BLANKET WITH A ROW OF STAPLES/STAKES APPROXIMATELY 12" APART IN THE BOTTOM OF THE TRENCH. BACKFILL AND COMPACT THE TRENCH AFTER STAPLING. APPLY SEED TO COMPACTED SOIL AND FOLD REMAINING 12" PORTION OF BLANKET BACK OVER SEED AND COMPACTED SOIL. SECURE BLANKET OVER COMPACTED SOIL WITH A ROW OF STAPLES/STAKES SPACED APPROXIMATELY 12"APART ACROSS THE WIDTH OF THE BLANKET.
- 3. ROLL THE BLANKETS (A.) DOWN OR (B.) HORIZONTALLY ACROSS THE SLOPE. BLANKETS WILL UNROLL WITH APPROPRIATE SIDE AGAINST THE SOIL SURFACE. ALL BLANKETS MUST BE SECURELY FASTENED TO SOIL SURFACE BY PLACING STAPLES/STAKES IN APPROPRIATE LOCATIONS AS SHOWN IN THE MANUFACTURERS STAPLE PATTERN
- 4. THE EDGES OF PARALLEL BLANKETS MUST BE STAPLED WITH APPROXIMATELY 2"-5" OVERLAP DEPENDING ON BLANKET TYPE. TO ENSURE PROPER SEAM ALIGNMENT, PLACE THE EDGE OF THE OVERLAPPING BLANKET (BLANKET BEING INSTALLED ON TOP) EVEN WITH THE COLORED SEAM STITCH ON THE PREVIOUSLY INSTALLED BLANKET.
- 5. CONSECUTIVE BLANKETS SPLICED DOWN THE SLOPE MUST BE PLACED END OVER END (SHINGLE STYLE) WITH AN APPROXIMATE 3" OVERLAP. STAPLE THROUGH OVERLAPPED AREA, APPROXIMATELY 12" (30cm) APART ACROSS


*IN LOOSE SOIL CONDITIONS, THE USE OF STAPLE OR STAKE LENGTHS GREATER THAN 6" MAY BE NECESSARY TO PROPERLY SECURE THE BLANKETS.
 FOR USE IN AREAS WHERE SLOPE EXCEEDS 1H: 3V.

HIGH VELOCITY STRAW MULCH EROSION BLANKET

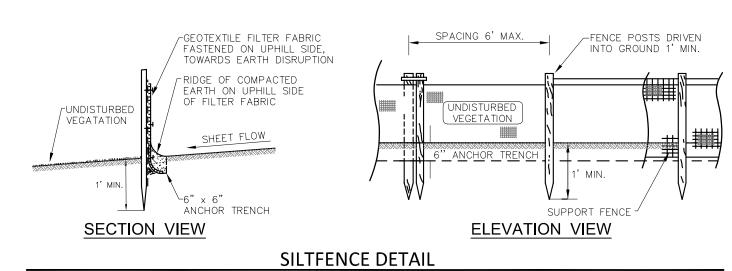

CONSTRUCTION SEQUENCE / TIMING SCHEDULE	ANTIQIDATED
(TO BE COMPLETED BY CONTRACTOR)	ANTICIPATED DATE
1. INSTALL SILT FABRIC FENCING AND TEMP. CONSTRUCTION ACCESS PER PLAN.	
2. CONDUCT DEMOLITION AND SITE CLEARING AS REQUIRED PER PLAN.	
3. STRIP AND STOCK PILE OR REMOVE TOPSOIL PER PLAN	
4. COMMENCE MASS GRADING OF SITE.	
5. COMPLETE ALL BUILDING CONSTRUCTION, LANDSCAPE ACTIVITY AND SITE RESTORATION.	
6. COMPLETE PERMANENT SEEDING (BEGIN MAINTENANCE PERIOD).	

7. REMOVE ALL TEMPORARY SOIL EROSION MEASURES.

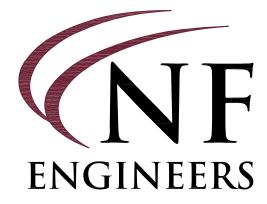

CIVIL ENGINEERS LAND SURVEYORS LAND PLANNERS

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Independence Township -Bay Court Park Pole Barn

CLIENT Independence Township

Contact: Derek Smith Phone: (248)-625-8223 Fax: (248)-620-7454 Email: dosmith@nfe-engr.com PROJECT LOCATION

of Section 32 T. 4N, R. 9E City of Clarkston, Oakland County, Michigan

> SHEET S.E.S.C. Plan

Part of the SW 1/4



DATE ISSUED/REVISED 8-02-22 OWNER REVIEW 8-23-22 OWNER REVIEW 9-16-22 ISSUED FOR BID DRAWN BY: K. Ruiter **DESIGNED BY:** K. Ruiter

> EMAIL CONTACT: kruiter@nfe-engr.com SCALE: 1'' = 20'

APPROVED BY:

S. Sutton

SHEET NO. M383-01 **C5**

DESIGN CRITERIA CODE INFO.

USE GROUP: U - UTILITY CONSTRUCTION TYPE: 5B OCCUPANT LOAD: 8

AREA OF NEW BUILDING - 1,500 S.F. AREA OF EXISTING BUILDING - 800 S.F. TOTAL BUILDING AREA - 2,300

DESIGN LOADS

ROOF LOADS

DEAD LOAD: TOP CHORD: 10 PSF

BOTTOM CHORD: 5 PSF

WIND LOADS: 3 SECONDS GUST WIND SPEED


> VASD= 89 MPH VULT= 115 MPH


EXPOSURE= C RISK= II

BASIC GROUND SNOW LOAD: Pg=25 PSF SNOW LOAD:

SNOW EXPOSURE FACTOR: Ce=1.0
SNOW LOAD IMPORTANCE FACTOR: Is=.8

THERMAL FACTOR: Ct=1.2

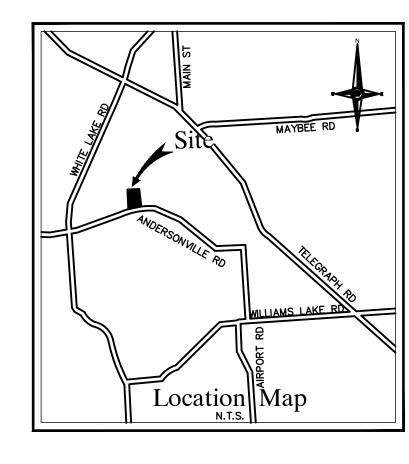

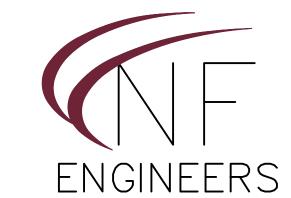

civil Engineers Land Surveyors Land Planners

NOWAK & FRAUS ENGINEERS 46777 Woodward Ave. Pontiac, MI 48342—5032 Tel. (248) 332—7931 Fax. (248) 332—8257

SEAL

PROJECT

Independence Township -Bay Court Park Pole Barn

Independence Township

Phone: (248)-625-8223 Fax: (248)-620-7454 Email: dosmith@nfe-engr.com PROJECT LOCATION

Contact: Derek Smith

Part of the SW \(^1/4\)
of Section 32
T. 4N, R. 9E
City of Clarkston,
Oakland County, Michigan

SHEET DESIGN CRITERIA



DATE		1	SSUED	/REVIS	SE
8-02-22	OWNER	REVIEW			
8-23-22	OWNER	REVIEW			
9-16-22	BID				

DRAWN BY: KJM

DESIGNED BY:

DJS


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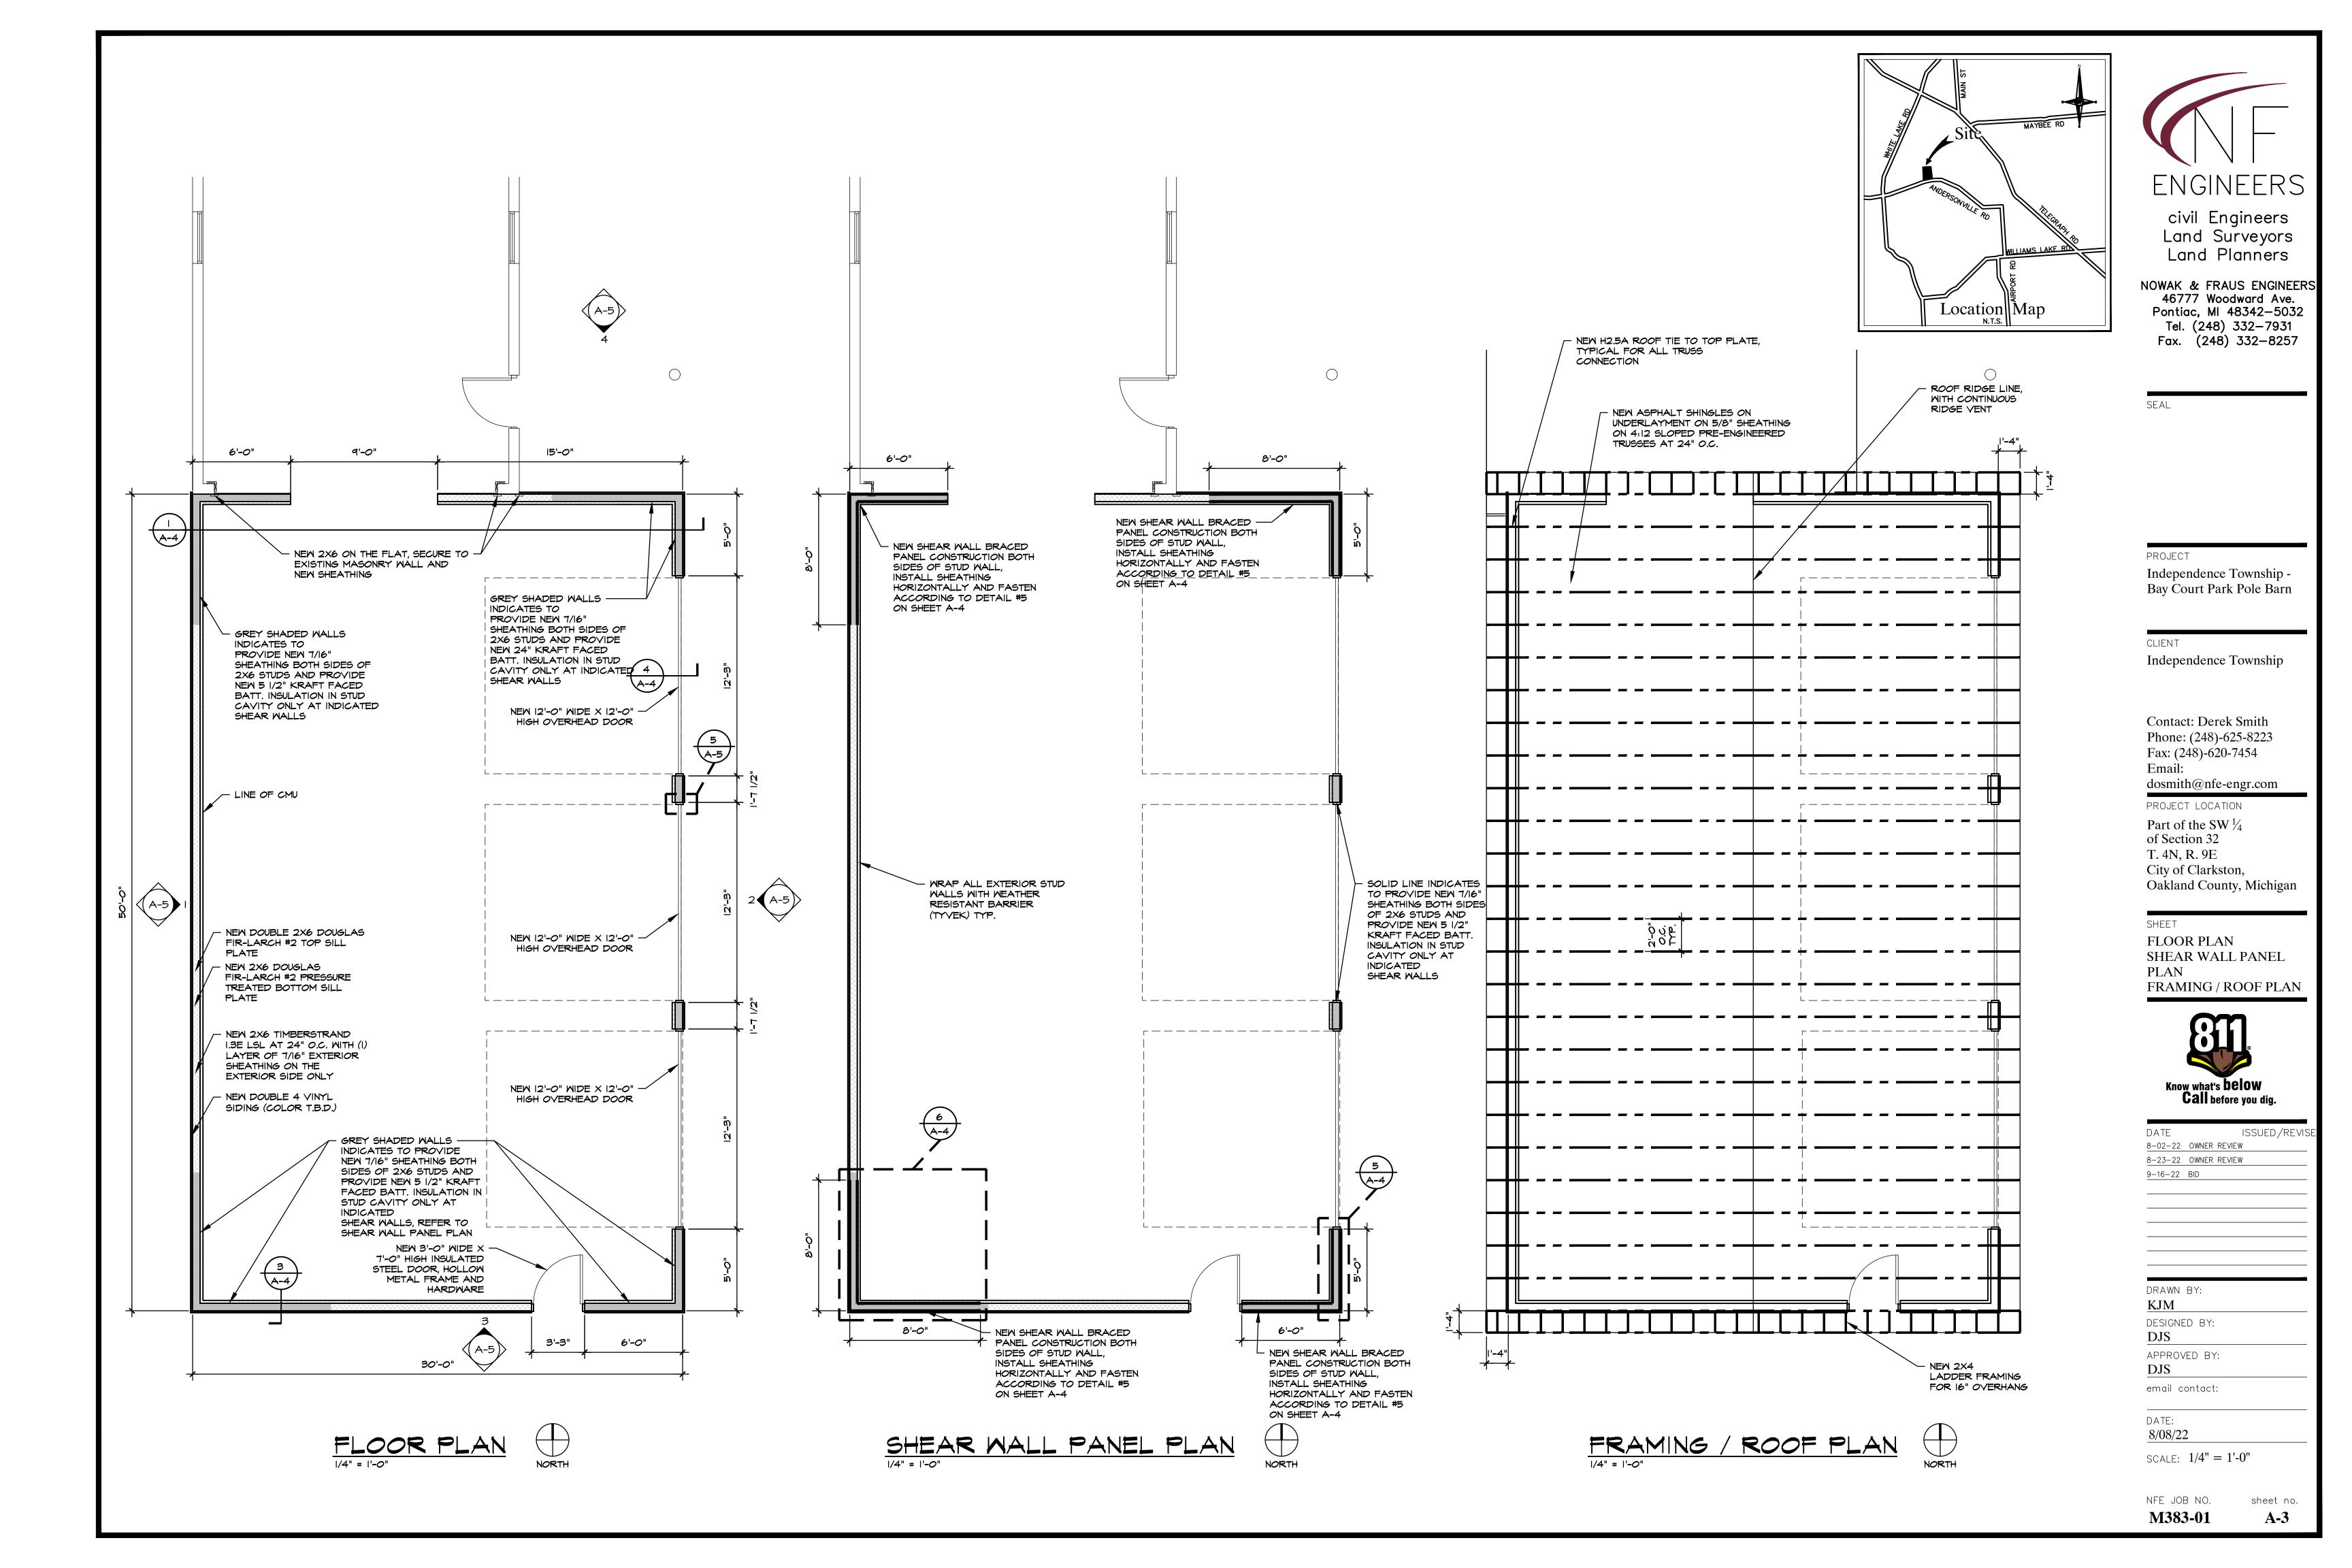
email contact:


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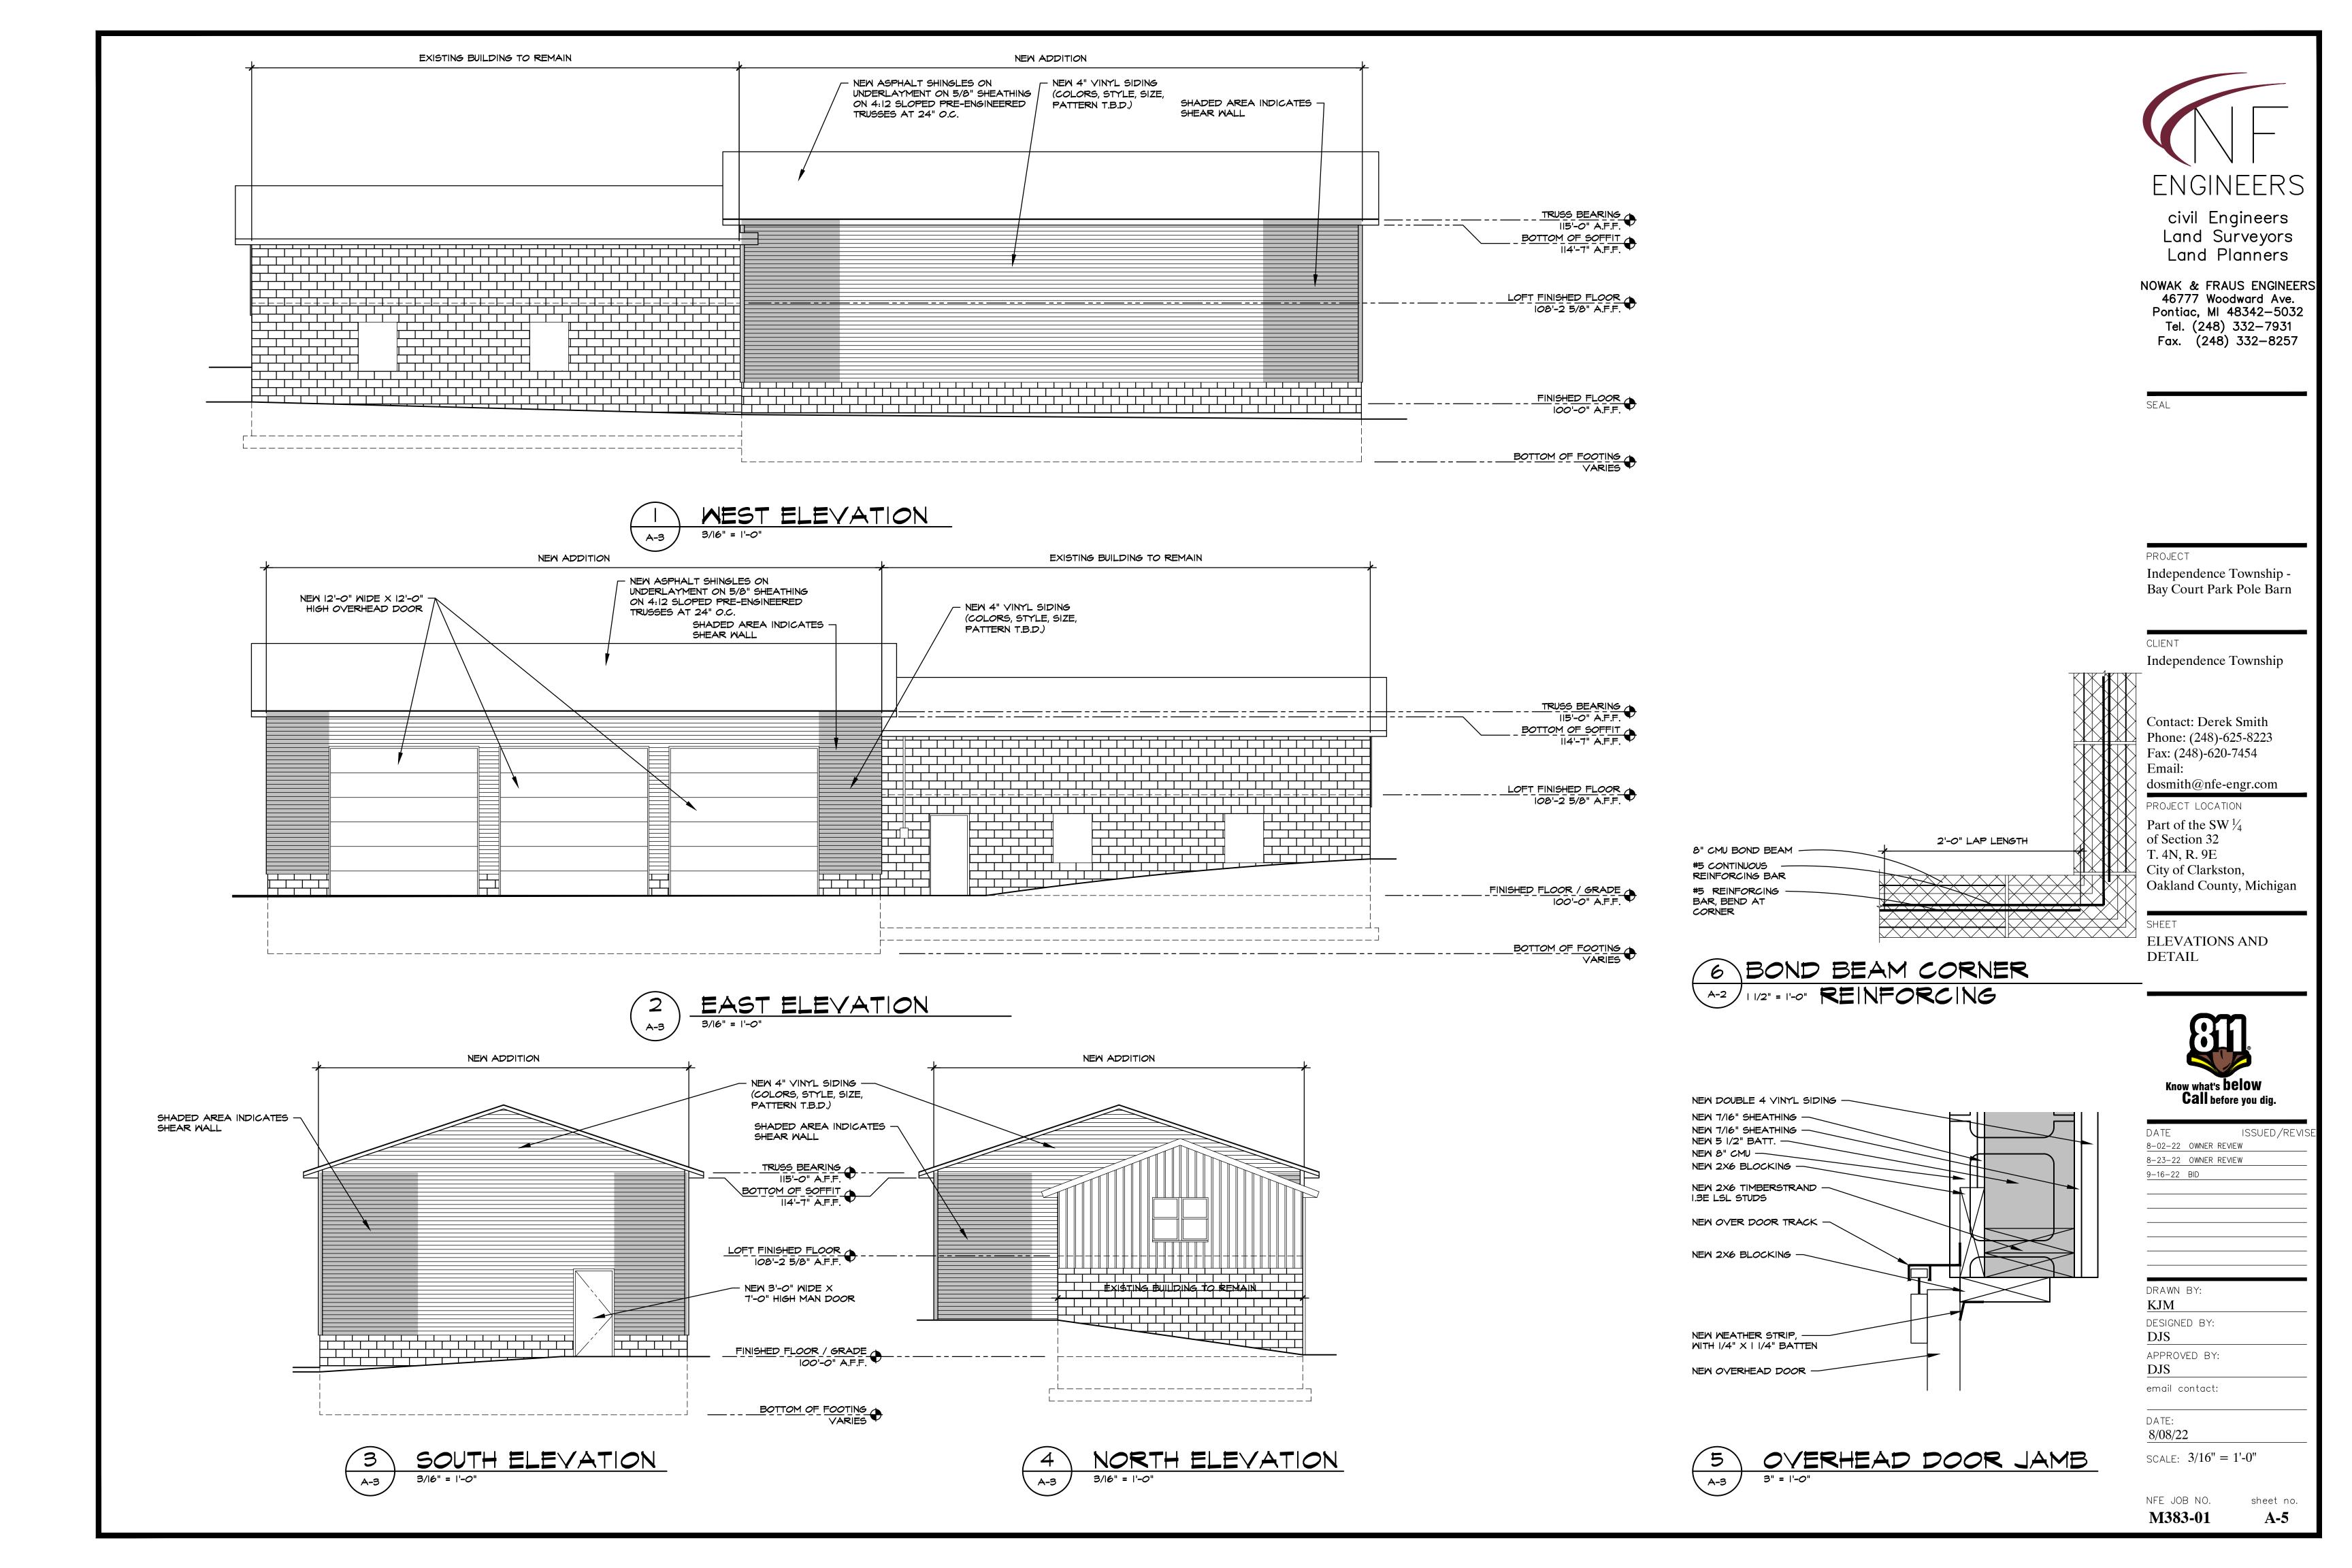
NFE JOB NO. M383-01

sheet no. **A-1**





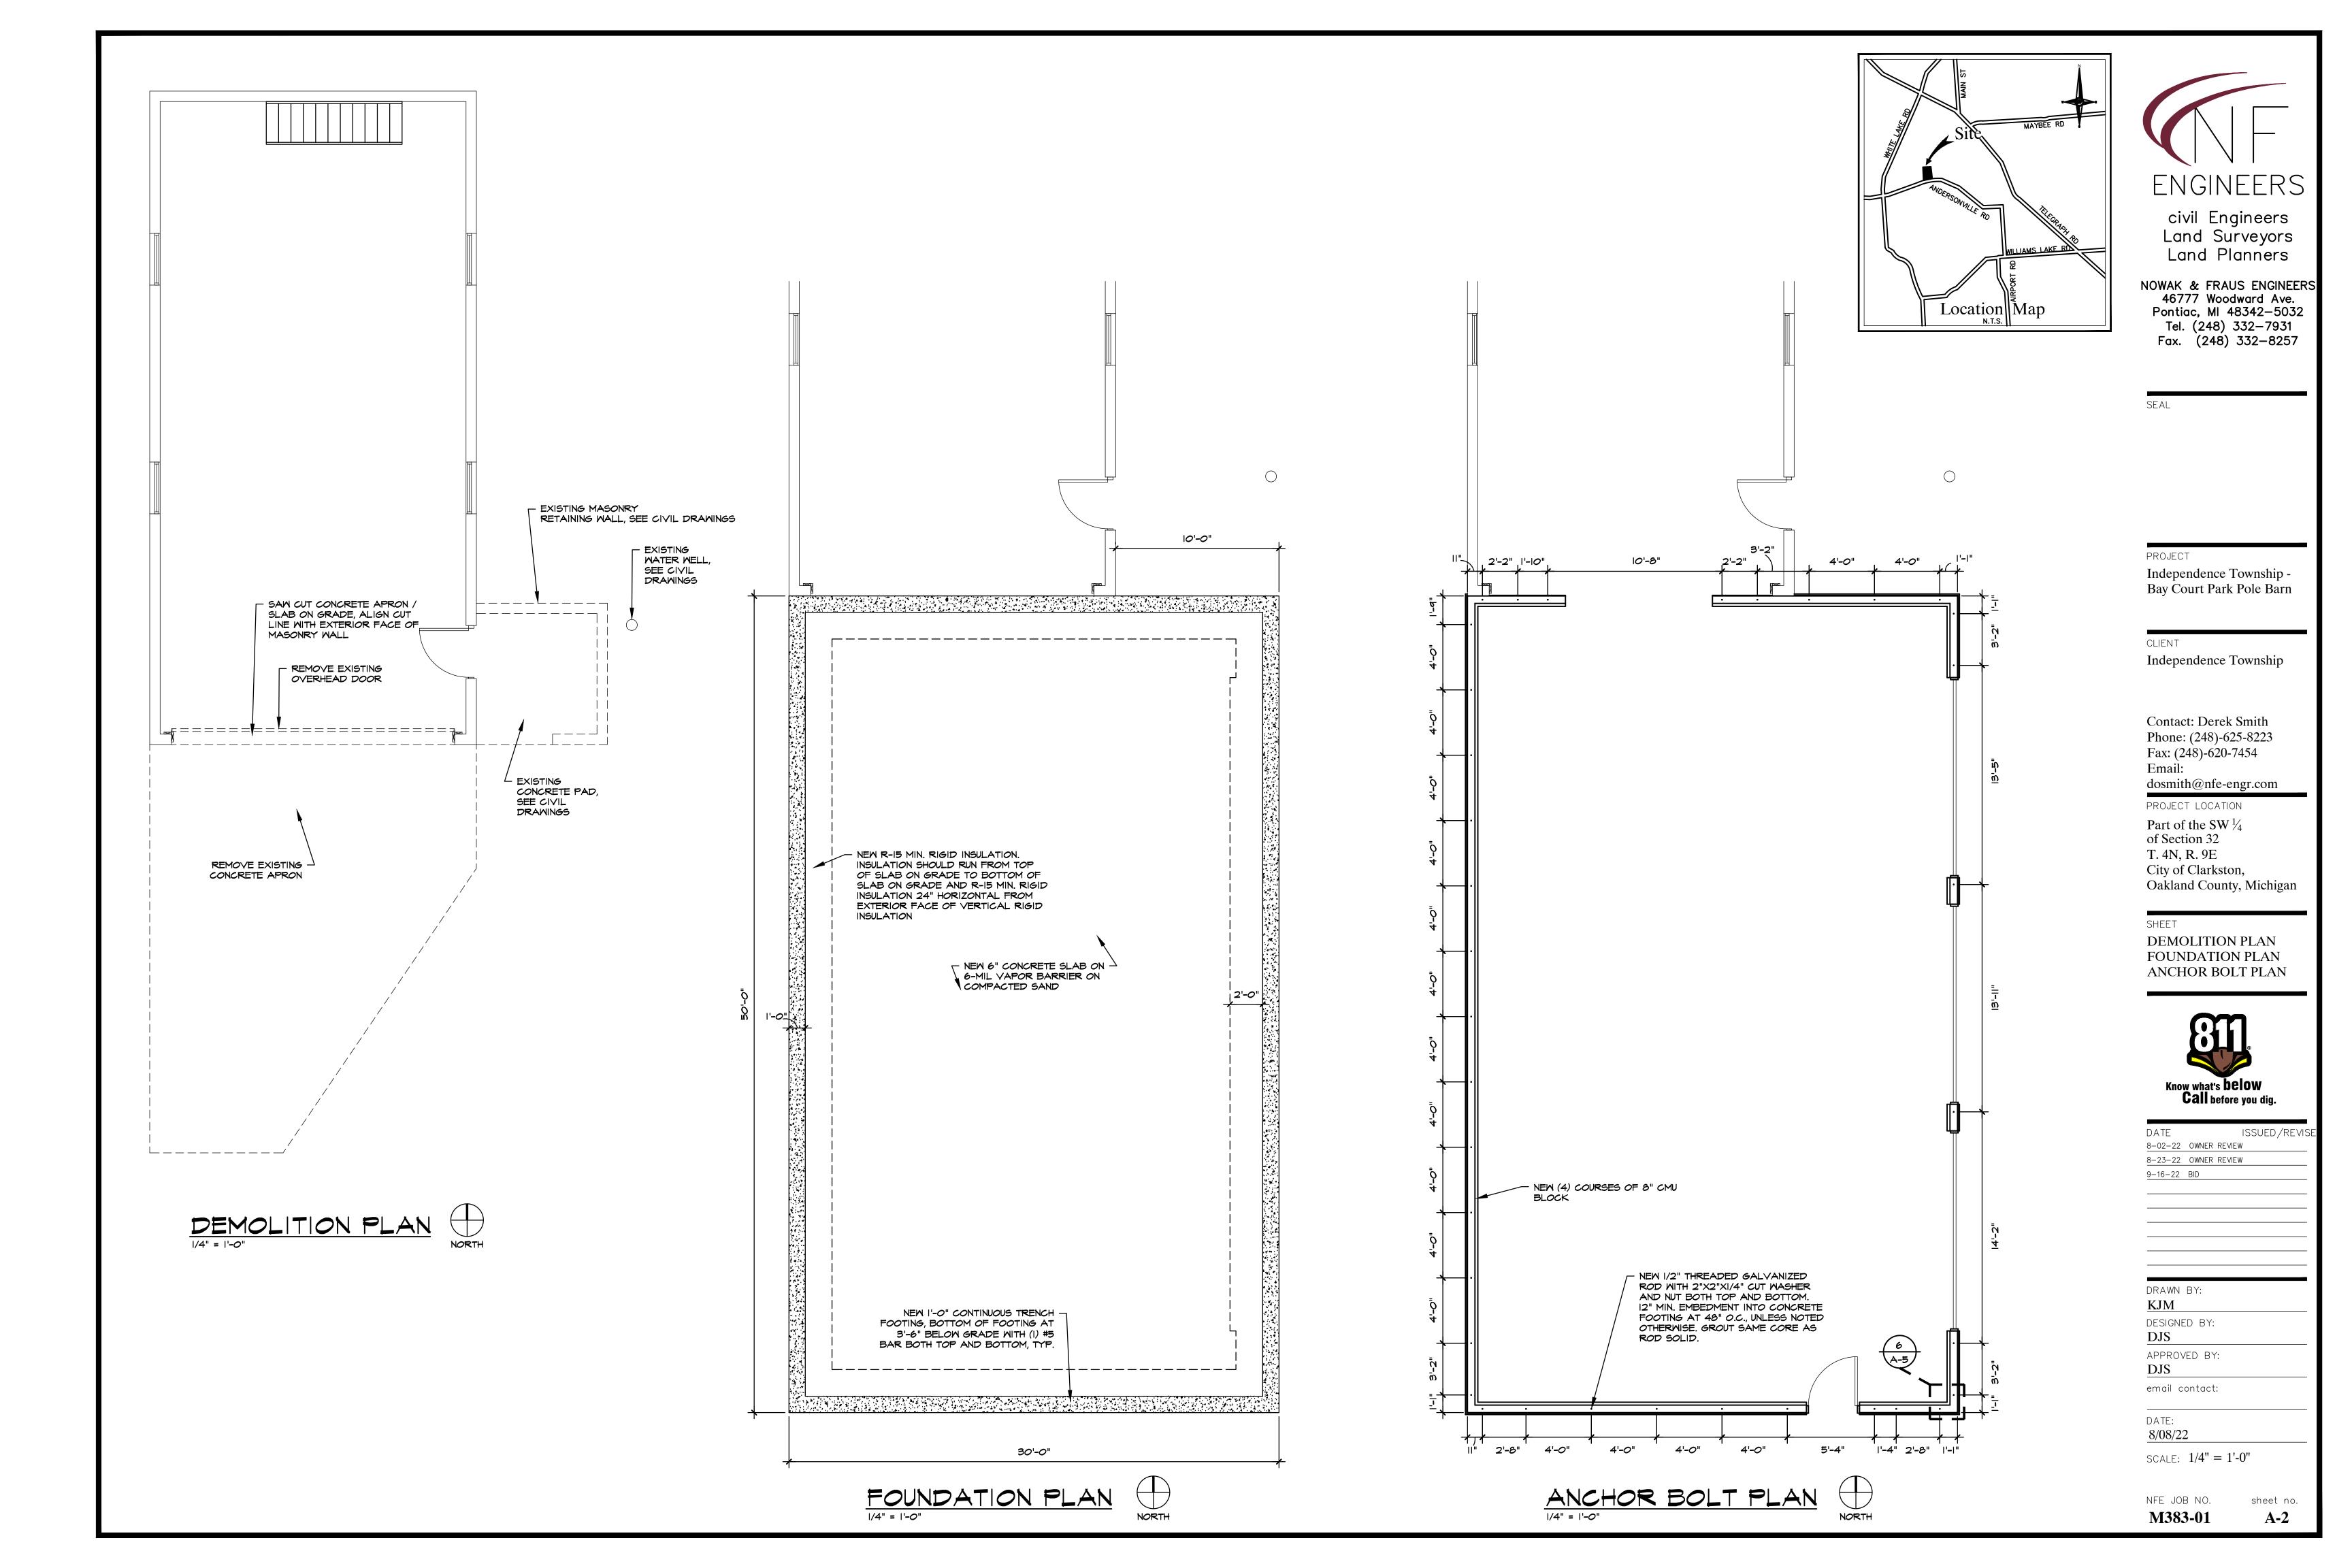

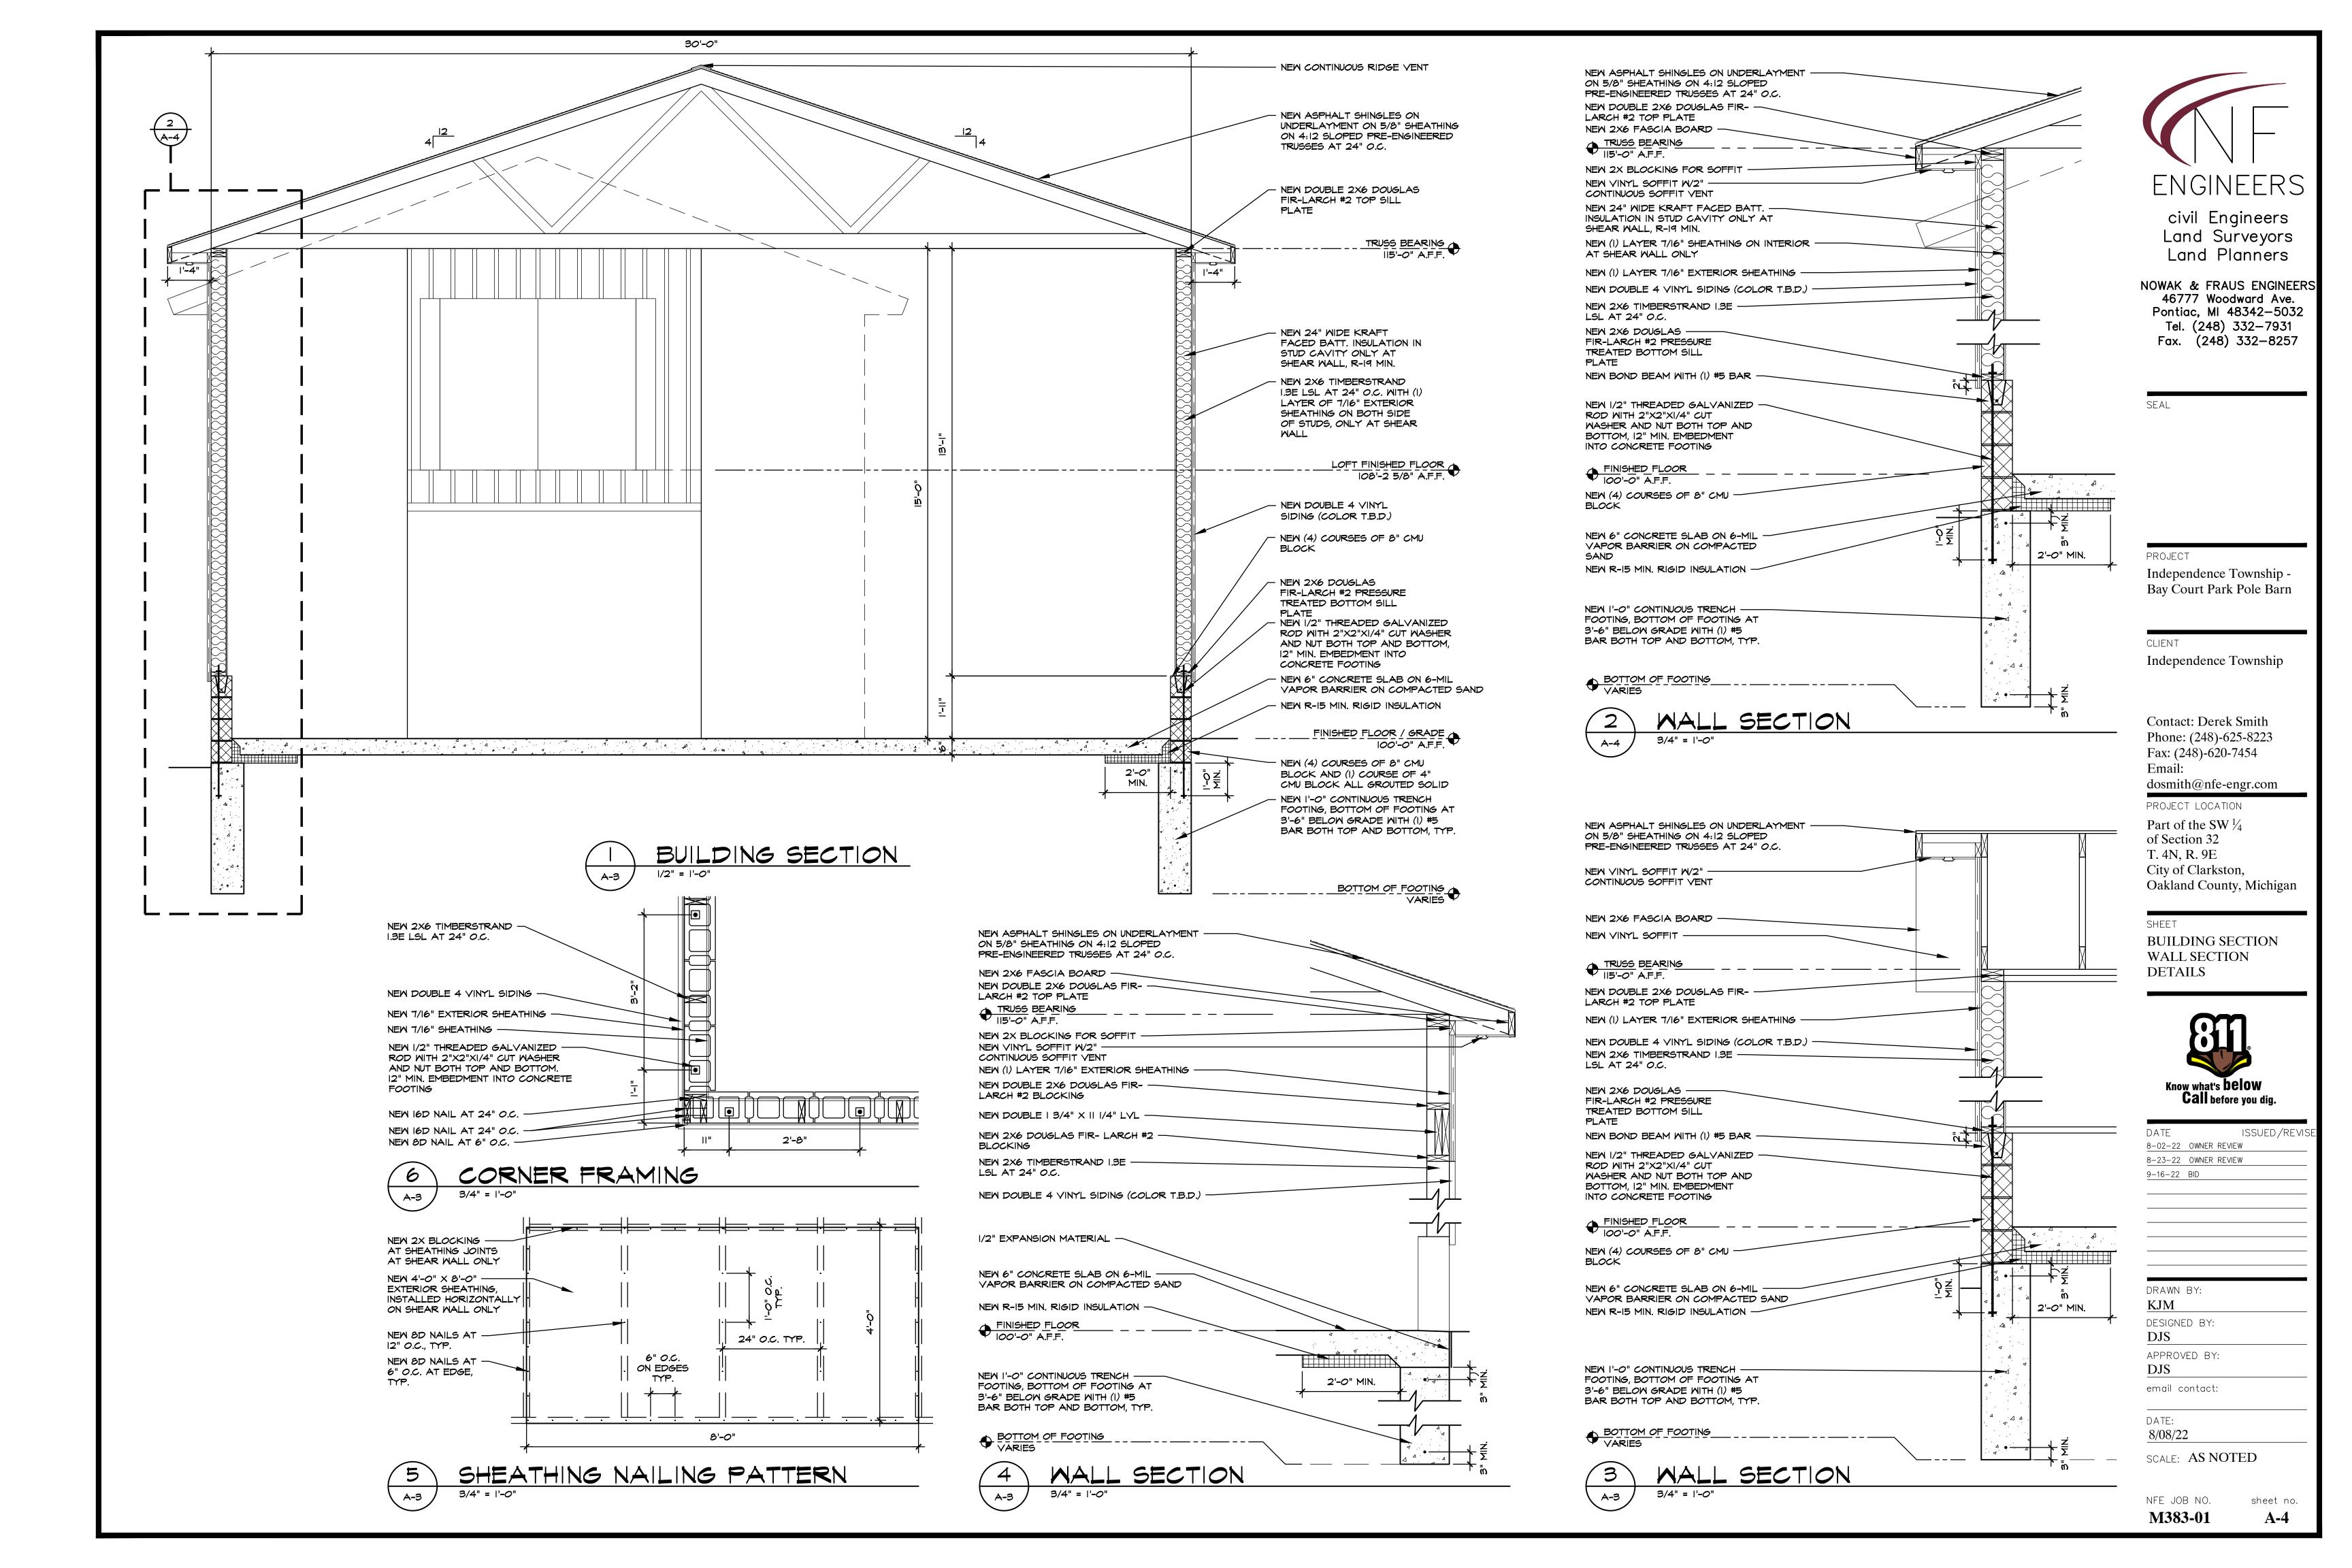

		GA.	S-FIRED	J OIVII I		\ 3011L	DOLL		
		M	ВН	FLUE	VENT				
TAG	MODEL	INPUT	OUTPUT	SIZE (IN)	SIZE (IN)	VOLTS	PHASE	HP	COMMENTS
UH-1	HDS 100	100	82	4"	4"	120	1	1/6	1,2,3,4,5
UH-2	HDS 45	45	36.9	3"	3"	120	1	1/15	1,2,3,4,5

- 1. BASED ON MODINE 4. DISCONNECT BY EC
- 2. SEPARATED COMBUSTION . HORIZONTAL CONCENTRIC VENT

REGULATOR SCHEDULE							
-	TAG	INLET PRESSURE RANGE	OUTLET PRESSURE	CAPACITY	AUSI STANDARD		
	R-1	1 PSI - 5 PSI	7" WC	150 CFH	ANSI Z21.80		

5. THERMOSTAT BY MANUFACTURER

HVAC & PLUMBING ABBREVIATIONS

CFM	CUBIC FEET PER MINUTE		
		LAT	LEAVING AIR TEMPERATURE
DB DIA	DRY BULB DIAMETER	LH	LATENT HEAT (MBH)
DN	DOWN	MAX MBH	MAXIMUM BTU PER HOUR (THOUSAND)
EAT	ENTERING AIR TEMPERATURE	MIN	MINIMUM
E.T.C. EXH	ELECTRICAL TRADES CONTRACTOR EXHAUST	I.E.A.	MECHANICAL TRADES CONTRA
EXIST	EXISTING	NTS	NOT TO SCALE
FF	FINISH FLOOR	PD	PRESSURE DROP
FT	FEET	PVC	POLY-VINYL-CHLORIDE
GAL	GALLON	REQ'D	REQUIRED
GPH GPM	GALLONS PER HOUR GALLONS PER MINUTE	RH	RELATIVE HUMIDITY
		SH	SENSIBLE HEAT (MBH)
HD	HEAD (FT)	SM	SHEET METAL ` ´
HP HTG	HORSE POWER HEATING	SQ. FT.	SQUARE FEET
HVAC	HEATING, VENTILATION, & AIR CONDITIONING	TYP	TYPICAL
		UH	UNIT HEATER
ID	INSIDE DIAMETER		

HVAC & PLUMBING SYMBOLS LEGEND

IIVACA	I LUMBING STIMBOL	J LLULI	
HVAC DUCT	WORK SYMBOLS	PIPING SY	MBOLS
\boxtimes	OUTSIDE AIR DUCT RISER (AS NOTED)		FLOW DIRECTION
	EXHAUST AIR DUCT		PIPING DROP
			PIPING RISE
∐þ	UNIT HEATER	 3	PIPE CAP
		<i>──</i>	PIPE BREAK
HVAC DUCT	WORK	M	GAS METER
—— OA —— —— EA ——	OUTSIDE AIR DUCT EXHAUST AIR DUCT	HVAC PIPI	NG & PLUMBING VALVES
		$\overline{\hspace{1cm}}$	GATE VALVE
MISCELLANE	EOUS NOTES	——⋈——	GAS COCK
•	POINT OF CONNECTION BETWEEN	——⊙——	GAS PRESSURE REGULATOR

PLUMBING PIPING

GAS (NATURAL)

TEMPERATURE CONTROL SYMBOLS

THERMOSTAT

POINT OF CONNECTION BETWEEN NEW AND EXISTING POINT OF EXISTING TO REMAIN AND EXISTING TO BE REMOVED

INVERT ELEVATION

INDICATES PLAN NOTE

INDICATES DEMOLITION NOTE

DETAIL BUBBLE --- DETAIL NUMBER —— PAGE LOCATION INDICATES DIRECTION OF DETAIL SECTION

GENERAL HVAC NOTES

- 1. LOCATE OUTDOOR INTAKES AT LEAST 6 FEET ABOVE GROUND LEVEL OR 3 FEET ABOVE ROOF LEVEL. UNLESS OTHERWISE INDICATED.
- 2. CONTRACTOR SHALL COORDINATE ALL WORK WITH OTHER DISCIPLINES PRIOR TO CONSTRUCTION TO AVOID CONFLICTS.
- 3. THE CONTRACTOR SHALL FIELD VERIFY THE SIZES, LOCATION, ELEVATIONS, AND DETAILS OF ALL EXISTING CONDITIONS THAT MAY AFFECT THE WORK.
- 4. THE CONTRACTOR SHALL BE RESPONSIBLE FOR MAINTAINING THE INTEGRITY OF ALL EQUIPMENT AND MATERIALS IN A "NEW" CONDITION DURING CONSTRUCTION.
- 5. ALL WORK SHALL BE PERFORMED BY LICENSED CONTRACTORS AND SUBCONTRACTORS AS REQUIRED BY LAW.
- 6. ALL WORK SHALL CONFORM TO MICHIGAN MECHANICAL CODE, LATEST APPLICABLE EDITION.
- 7. CONTRACTOR SHALL USE LOW PRESSURE LOSS DUCT FITTINGS IN ACCORDANCE WITH SMACNA. (WYES, RADIUSED OR VANED TEES, ETC.) DUCTWORK SHALL BE GALVANIZED SHEET METAL, MIN. 26 GA.
- 8. ALL DUCT DIMENSIONS SHOWN ARE INSIDE CLEAR DIMENSION. INCREASE DUCT SIZE FOR LINING.
- 9. ALL EXTERNALLY ISOLATED HVAC EQUIPMENT SHALL HAVE FLEXIBLE DUCT CONNECTORS.

GENERAL PLUMBING NOTES

- 1. ALL PLUMBING WORK SHALL CONFORM TO MICHIGAN PLUMBING CODE, LATEST APPLICABLE EDITION.
- 2. SITE CONTRACTOR TO RUN UTILITIES TO 5'-0" FROM **BUILDING LINE**
- 3. ALL INVERT ELEVATIONS ARE BASED ON A FINISH FLOOR LEVEL OF 100'-00".
- 4. ALL ELEVATIONS SHOWN ARE INVERTS OF PIPING. THE SLEEVES SHALL BE COORDINATED WITH THESE ELEVATIONS.
- 5. ALL PIPE SIZES SHOWN ARE SERVICE SIZE. SIZE SLEEVES FOR 1" CLEAR SPACE BETWEEN PIPE AND SLEEVE FOR INSTALLATION OF MECHANICAL SEAL. 6. THE CONTRACTOR SHALL FIELD VERIFY THE SIZES,
- LOCATION, ELEVATIONS, AND DETAILS OF ALL EXISTING CONDITIONS THAT MAY AFFECT THE WORK. 7. THE CONTRACTOR SHALL BE RESPONSIBLE FOR
- MAINTAINING THE INTEGRITY OF ALL EQUIPMENT AND MATERIALS IN A "NEW" CONDITION DURING CONSTRUCTION.
- 8. ALL WORK SHALL BE PERFORMED BY LICENSED CONTRACTORS AND SUBCONTRACTORS AS REQUIRED

MECHANICAL KEY NOTES

1 CONTRACTOR SHALL COORDINATE WITH MISS DIG TO LOCATE EXISTING UTILITIES PRIOR TO TRENCHING/BORING FOR NEW GAS MAIN PIPING.

NATURAL GAS SUMMARY

UH-1 = 100 MCF (4" - 14" WC) UH-2 = 45 MCF (4" - 14" WC) TOTAL = 145 MCF AT 5 PSI

CONTRACTOR SHALL COORDINATE NEW GAS LOAD WITH UTILITY PROVIDER REGARDING GAS METER CAPACITY

_ 3" VENT AND INLET AIR TO

HORIZONTAL CONCENTRIC VENT —

REFER TO CIVIL PLANS


FOR CONTINUATION —

HORIZONTAL CONCENTRIC VENT


- 4" VENT AND INLET AIR TO

CONCENTRIC VENT

HORIZONTAL CONCENTRIC VENT

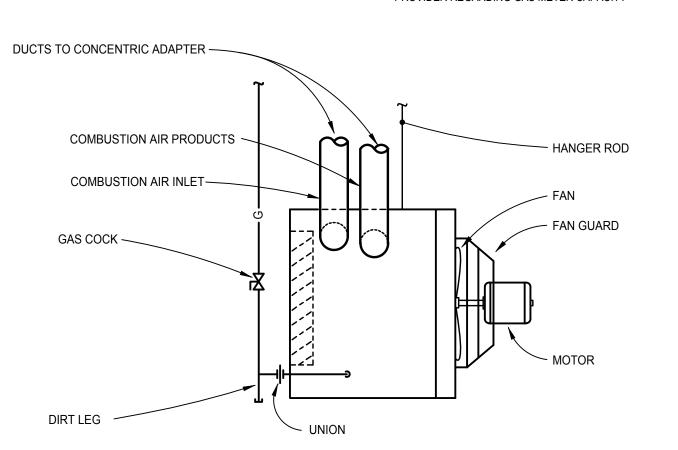


GAS UNIT HEATER DETAIL

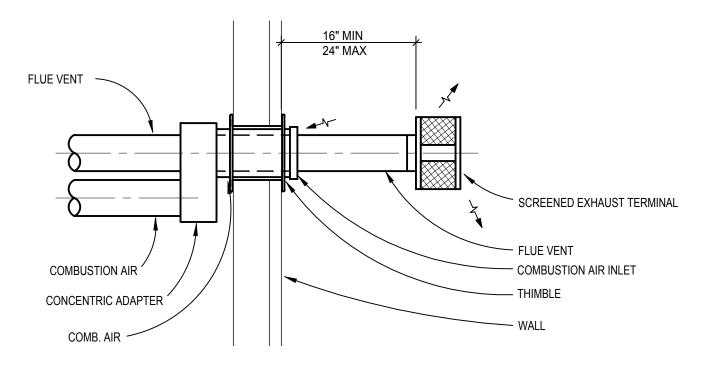

MINIMUM CLEARANCES

1. HORIZONTAL VENT MUST BE AT LEAST 3 FEET ABOVE FORCED AIR INLET WITHIN 10 FEET OF VENT. 2. HORIZONTAL VENT MUST BE AT LEAST 4 FEET BELOW, 4 FEET HORIZONTALLY, AND 1 FOOT ABOVE DOORS, WINDOWS, OR GRAVITY AIR INLET OR COMBUSTION AIR INLETS FOR OTHER APPLIANCES. IF REQUIRED TO MEET THESE REQUIREMENTS SEAL OPERABLE WINDOWS AS REQUIRED TO OBTAIN MINIMUM CLEARANCE. 3. HORIZONTAL VENT MUST BE AT LEAST 1 FOOT ABOVE GRADE LEVEL.



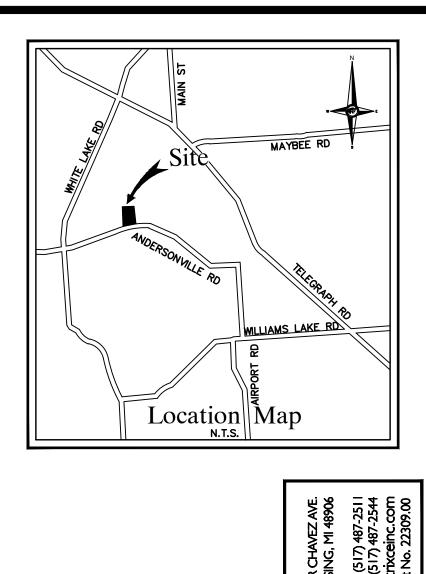

ENGINEERS civil Engineers Land Surveyors Land Planners

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SEAL

PROJECT

SCONST

Independence Township -Bay Court Park Pole Barn

Independence Township

Contact: Derek Smith Phone: (248)-625-8223 Fax: (248)-620-7454 Email: dosmith@nfe-engr.com

PROJECT LOCATION Part of the SW 1/4 of Section 32 T. 4N, R. 9E City of Clarkston, Oakland County, Michigan

SHEET **MECHANICAL** FLOOR PLAN HVAC



ISSUED/REVI 8-02-22 OWNER REVIEW 8-23-22 OWNER REVIEW 9- 16- 22 ISSUED FOR BID

DRAWN BY: NRF DESIGNED BY: NRF

APPROVED BY: CAT email contact:

9/16/22

NFOX@MATRIXCEINC.COM DATE:

SCALE: AS SHOWN

NFE JOB NO. M383-01

 $\mathbf{M-100}$

sheet no.

ELECTRICAL SYMBOLS LECENID

		ELEC ₁	TRICAL SYMBOLS LEG	END	
					-
	OUTLETS		FIXTURES		SERVICE and EQUIPMENT
Φ	SINGLE RECEPTACLE (120 VOLT)	0	LIGHT FIXTURE	TVSS	TRANSIENT VOLTAGE SURGE SUPPRESSION
Ф	DUPLEX RECEPTACLE	\longmapsto	STRIP FIXTURE	VFD	VARIABLE FREQUENCY DRIVE
Ö	EMERGENCY RECEPTACLE	Â	EMERGENCY LIGHT FIXTURE	T	TRANSFORMER
#	DOUBLE DUPLEX RECEPTACLE	•	IN-GRADE LIGHT FIXTURE		DISCONNECT SWITCH
⊙F	FLUSH FLOOR BOX	⊘ 1	SPOTLIGHT (number of heads shown) EXIT SIGN (face & direction as shown)	\boxtimes	MAGNETIC STARTER
⊙S	SURFACE FLOOR BOX	⊗ ₩	WALL MOUNT LIGHT FIXTURE	$oxide{oxtime}$	COMB. STARTER
M	SPECIAL EQUIPMENT RECEPTACLE	+	CEILING LIGHT FIXTURE		PANELBOARD, SURFACE MOUNTED
▼	TELEPHONE OUTLET	<u> </u>	TRACK & FIXTURE	_	PANELBOARD, FLUSH MOUNTED
∇	DATA OUTLET	$\stackrel{\sim}{\leftarrow}$	STREET TYPE POLE FIXTURE		WEATHERHEAD
<u>_</u>	TELEPHONE / DATA OUTLET	⊶	POLE MOUNTED LIGHT FIXTURE	<u>þ</u>	UTILITY METER, AS REQUIRED
■PP	POWER POLE	H	EXTERIOR WALL MOUNT LIGHT FIXTURE	O	DIGITAL EQUIPMENT METER, AS REQUIRED
<u> </u>	JUNCTION BOX		WALLPACK LIGHT FIXTURE	CT	CURRENT TRANSFORMERS
Θ.	WALL JUNCTION BOX	•	SPECIAL PURPOSE LIGHT FIXTURE	∭ LTT.	GENERATOR, KW SHOWN TELEPHONE TERMINAL BOARD
J	PULL (JUNCTION) BOX		HIGH BAY LIGHT FIXTURE		
	UNDERFLOOR JUNCTION BOX	D ₂	EMERGENCY EGRESS LIGHT FIXTURE (number of heads shown)		GROUND CONNECTION PER N.E.C.
(4)	CEILING MOUNTED WIFI	\sim	DOCK LIGHT FIXTURE	TS1	WIREWAY TRANSFER SWITCH
	SWITCHES	7 0			ENCLOSED CIRCUIT BREAKER
\$	SINGLE-POLE SWITCH		CIRCUITRY and RACEWAYS	<u> </u>	CAPACITOR
\$₃ ¢	THREE-WAY SWITCH		CONDUIT INSTALLED (by E.C.)	_	
\$4 \$-	FOUR-WAY SWITCH		CONDUIT INSTALLED (by others)		CONTROL
\$ _Р \$тп	SWITCH WITH PILOT LIGHT THERMAL OVERLOAD SWITCH		CONDUIT STUB UP	①	THERMOSTAT
ФТП \$м	MANUAL MOTOR SWITCH		CONDUIT STUB DOWN	Θ	HUMIDISTAT
ФМ \$к	KEY SWITCH	1,3	HOME RUN (with circuit numbers)		PHOTOCELL (voltage as required) TIME CLOCK (24 hour U.O.N.)
\$ _T	TIME SWITCH		END OF CONDUIT RUN		PUSHBUTTON STATION (number of
D	DIMMER SWITCH		END OF CONDUIT RUN, CAP AND STAKE "CONDUIT RUN CONTINUES" INDICATION	3	buttons indicated)
	MECHANICAL	·····:	FLEXIBLE PIGTAILS/CONNECTIONS		CONTROL TRANSFORMER
N	SINGLE PHASE MOTOR		WIREMOLD AS SPECIFIED		LIGHTING CONTACTOR
<i>∕</i>	THREE PHASE MOTOR		PLUGMOLD AS SPECIFIED	IC	IRRIGATION CONTROLLER (120 volt
-W-	RESISTANCE HEATER, KW SHOWN		BUS DUCT		xxVA connection by x/C)
·····	PIPE TRACE HEATER		UNDERFLOOR DUCT	(OS1)	WALL MOUNT DUAL TECHNOLOGY SENSOR
\varnothing	ELECTRIC UNIT HEATER		SOUND and SIGNAL	→	Will moon bone regimees eligen
(WH)	ELECTRIC WATER HEATER	S	SPEAKER	OS2)	OCCUPANCY SENSOR / PHOTOCELL
•	NURSE CALL	(S)+	WALL MOUNTED SPEAKER	¥ ♠	
NCC	NURSE CALL CONTROLLER	Ø. ₩	WALL MOUNTED SPEAKER / CLOCK COME	3O (0S3)	ULTRASONIC SENSOR - 360° - 2 CIRCUIT
M	MASTER STATION	Ю	SINGLE FACE CLOCK	\bigvee	DETITAGONIO DENGON - 300 - 2 GINOGII
P	EMERGENCY PULL STATION	4	DUAL FACE CLOCK	(OS4)	DUAL TECHNOLOGY SENSOR - 360° - 1000 SQ FT
Ē	EMERGENCY PUSH STATION	VI	VIDEO INPUT	V	DUAL TECHNOLOGY SENSON - 300 - 1000 SQTT
CB	CODE BLUE STATION	AV	AUDIO / VIDEO INPUT	\triangle	
A	PENDENT INTERFACE	BO	BELL	(OS5) V	DUAL TECHNOLOGY SENSOR - 360° - 500 SQ FT
	BED / LIGHT INTERFACE	\bigcirc	VOLUME CONTROL	٠	
<u>B</u> 1	SINGLE BED STATION	B	BUZZER	oc	SWITCH STYLE OCCUPANCY SENSOR
B2	DUAL BED STATION	٥	CHIME		DOWED DAGK
	DOME LIGHT	₹	TELEVISION OUTLET	PP	POWER PACK
SRS	STAFF REGISTER STATION	M	MICROPHONE OUTLET		
S	STAFF STATION	(1)	INTERCOM OUTLET	\$⊤	DIGITAL TIME SWITCH
DS	DUTY STATION		CAMERA DOOR CONTACT		FIRE ALARM
	<u>DESIGNATIONS</u>	DC	MOTION DETECTOR	(3)	SMOKE DETECTOR
$\langle x \rangle$	DEMOLITION NOTE		BEAM DETECTOR	Ĥ	HEAT DETECTOR
X	PLAN NOTE	EN KP	KEY PAD	Ě	DUCT SMOKE DETECTOR
\triangle	ADDENDUM NOTE	SSCP	SECURITY SYSTEM CONTROL PANEL	F/S	DUCT SMOKE DETECTOR
		CCTV	CCTV CONTROL PANEL		HORN
		CR	CARD READER		HORN & LIGHT
		SS	STUDENT STATION		SPEAKER
		AS	ADMINISTRATION STATION	□□	SPEAKER & LIGHT
		TS	TEACHER STATION	F	PULL STATION
			GLASS BREAK	FACP	FIRE ALARM CONTROL PANEL

MAGNETIC DOOR HOLDER

▶ ■ REMOTE INDICATING LIGHT, WALL MTD.

FIC FIREFIGHTER COMMUNICATION JACK

F FLOW SWITCH (furnished by FP/C)

FCPS FIRE CONTROL POWER SUPPLY

M CARBON MONOXIDE DETECTOR

MONITOR MODULE

© CONTROL MODULE

+= TAMPER SWITCH (furnished by FP/C)

REMOTE INDICATING LIGHT, CLG. MTD.

ANNUNCIATOR PANEL

- EOL- END OF LINE DEVICE

GENERAL ELECTRICAL NOTES

- 1. ALL WALL AND FLOOR PENETRATIONS ARE TO BE SEALED TO MAINTAIN ORIGINAL RATING.
- 2. ALL CONDUITS TO BE FIELD ROUTED ALONG EXISTING PIPING AND STRUCTURAL STEEL.
- 3. THE DIVISION 26 CONTRACTORS SHALL VISIT THE PROJECT AND DETERMINE THE EXACT EXTENT OF THE DEMOLITION WORK REQUIRED BEFORE BIDDING THE PROJECT.
- 4. REMOVE ALL EXISTING OBSOLETE EXPOSED CONDUIT, WIRE AND UNUSED EQUIPMENT WHERE WORK IS BEING DONE EXCEPT ITEMS NOTED OTHERWISE.
- 5. WHERE BUILDING SURFACES ARE DAMAGED BY THE REMOVAL OF OLD WORK, SURFACES SHALL BE PATCHED TO MATCH ADJACENT.
- 6. EXISTING WORK WHICH IS PRESENTLY CONCEALED AND WHICH WILL REMAIN CONCEALED AND DOES NOT INTERFERE WITH ANY NEW WORK OF ANY TRADE NEED NOT BE REMOVED. HOWEVER, ALL CONDUIT SHALL BE CAPPED BELOW FINISH SURFACE AND THEN PATCHED TO MATCH, OR AS NOTED.
- 7. EXISTING OPENINGS, WHICH ARE TO BE REUSED, SHALL BE MODIFIED OR ENLARGED TO SUIT THE NEW SYSTEMS AS REQUIRED. PROVIDE ALL REQUIRED CUTTING AND PATCHING.
- 8. IF ASBESTOS IS PRESENT, IT WILL BE REMOVED OR RENDERED HARMLESS UNDER SEPARATE CONTRACT BY THE OWNER.
- 9. THE DIVISION 26 CONTRACTOR SHALL BE RESPONSIBLE FOR PATCHING THE EXISTING WALLS TO MATCH THE ADJACENT SURFACES BEHIND ALL SURFACE MOUNTED EQUIPMENT.
- 10. CONTRACTOR SHALL BE RESPONSIBLE FOR ALL CIRCUITING. MAXIMUM LIGHTING LOAD PER 20A-1P CIRCUIT IS 1400 WATTS. MAXIMUM RECEPTACLE LOAD PER 20A-1P CIRCUIT SHALL BE (8) DUPLEXES. SIZE MOTOR OR EQUIPMENT CIRCUITS 125% OF RATED
- 11. CONTRACTOR SHALL FIELD VERIFY ALL EQUIPMENT VOLTAGES AND LOADS PRIOR TO INSTALLING SERVICE TO EQUIPMENT.
- 12. DRAWINGS ARE BASED ON EXISTING RECORD DOCUMENT AND CASUAL FIELD OBSERVATION. REPORT ANY DISCREPANCIES TO ENGINEER FOR CLARIFICATION.

A AC ACU- AFF	AMPS ABOVE COUNTER AIR CONDITIONING UNIT ABOVE FINISHED FLOOR	GC GFI GND	GENERAL CONTRACTOR GROUND FAULT INTERUPTER GROUND	P P- PB PNL PRV-	POLE PUMP PULL BOX PANEL POWER ROOF VENTILATOR
AHJ AHU- AIC AS	AUTHORITY HAVING JURISDICTION AIR HANDLING UNIT AMPS INTERUPTING CAPACITY ABOVE SHELF	H- HID HOA	HUMIDIFIER HIGH INTENSITY DISCHARGE HAND-OFF-AUTO SELECTOR SWITCH	PVC PWR	POWER ROOF VENTILATOR POLY VINYL CLORIDE POWER
ATS B-	AUTOMATIC TRANSFER SWITCH BOILER	HP HR HVAC	HORSEPOWER HOUR HEATING/VENTILATING/AIR CONDITIONING	RECEPT RGC RTU-	RECEPTACLE RIGID GALVANIZED STEEL CONDUIT ROOF TOP UNIT
BC BLDG	BELOW COUNTER BUILDING	IG IMC	ISOLATED GROUND INTERMEDIATE METAL CONDUIT	SF- SPEC SW	SUPPLY FAN SPECIFICATIONS SWITCH
CHLR- CND (C)	CHILLER CONDUIT	JB	JUNCTION BOX	SWBD	SWITCHBOARD
CKT CKT BKR CT- CU- CUH-	CIRCUIT CIRCUIT BREAKER COOLING TOWER CONDENSING UNIT CABINET UNIT HEATER	LC LT LTG LT FLEX	LIGHT CONTROL LIGHT LIGHTING LIQUID TIGHT FLEXIBLE METAL CONDUIT	TCC TR TS TYP	TEMPERATURE CONTROL CONTRACT TAMPER PROOF RECEPTACLE TAMPER PROOF SWITCH TYPICAL
DFU- DISC DWG DWH-	DUCT FURNACE DISCONNECT DRAWING DOMESTIC WATER HEATER	MAX MC MCC MIN MLO	MAXIMUM MECHANICAL CONTRACTOR MOTOR CONTROL CENTER MINIMUM MAIN LUG ONLY	UF UH- UL UNO	UNDER FLOOR UNIT HEATER UNDERWRITERS' LABORATORIES, INC UNLESS NOTED OTHERWISE
EBB- EC EF- EM	ELECTRIC BASEBOARD ELECTRICAL CONTRACTOR EXHAUST FAN EMERGENCY	MT MTD MTG MUAU-	MOUNT MOUNTED MOUNTING MAKE-UP AIR UNIT	V VL W	VOLTS VERIFY LOCATION WITH OWNER WATTS
EMT EWC EXIST (E)	ELECTRICAL METALLIC TUBING ELECTRIC WATER COOLER EXISTING	NC NIC NL	NORMALLY CLOSED NOT IN CONTRACT NIGHT LIGHT	W/ W/O WP	WITH WITHOUT WEATHER PROOF
FLA FLEX	FULL LOAD AMPS FLEXIBLE CONDUIT	NO NTS	NORMALLY OPEN NOT TO SCALE	XFMR	TRANSFORMER

FLOOR

FLUOR


FSES F/S FU-

FLUORESCENT

FIRE/SMOKE

FURNACE

FOOD SERVICE EQUIP. SUPPLIER

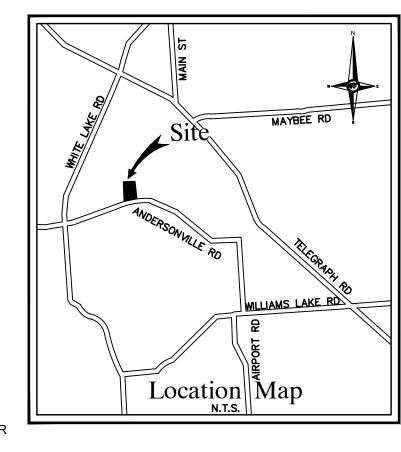

SCONSI

PROJECT

Independence Township -Bay Court Park Pole Barn

ENGINEERS

civil Engineers

Land Surveyors Land Planners

NOWAK & FRAUS ENGINEERS 46777 Woodward Ave.

Pontiac, MI 48342-5032

Tel. (248) 332-7931 Fax. (248) 332-8257

Independence Township

Contact: Derek Smith Phone: (248)-625-8223 Fax: (248)-620-7454 Email: dosmith@nfe-engr.com

PROJECT LOCATION Part of the SW $\frac{1}{4}$ of Section 32 T. 4N, R. 9E

City of Clarkston, Oakland County, Michigan SHEET ELECTRICAL SYMBOLS.

ABBREVIATIONS, NOTES,

Know what's **below**

AND SCHEDULES

Call before you dig. ISSUED/REVI 8-02-22 OWNER REVIEW 8-23-22 OWNER REVIEW 9- 16- 22 ISSUED FOR BID

DRAWN BY: BTT DESIGNED BY: BTT

APPROVED BY:

email contact: BTHELEN@MATRIXCEINC.COM

9/16/22

SCALE: AS SHOWN


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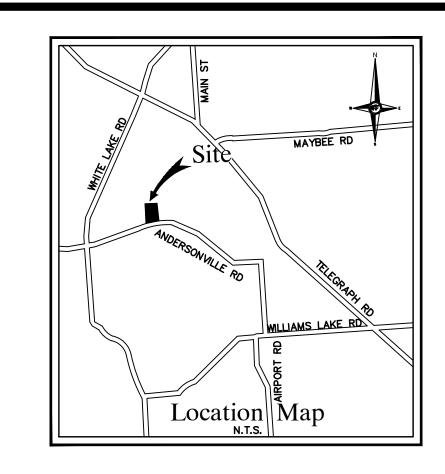
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sheet no. E-100

ABBREVIATIONS LEGEND

		LIGH	TING FIXTURE SCHEDULE			
YPE	MANUFACTURER	CATALOG NO.	DESCRIPTION AND COMMENTS	DIMMING INFO	FIXTURE MOUNTING HEIGHT	DRIVER
LA	LITHONIA	FEM-L96-9000LM-LPAFL-WD-MVOLT-GZ10-40K-80CRI	LED SUSPENDED 8' FIXTURE WITH WIDE DISTRIBUTION.	0-10V	12' AFF	9000 LUMENS 53W, 4000K LED
LB	LITHONIA	WPX1-LED-P1-40K-MVOLT-DBLXD	LED EXTERIOR WALLPACK WITH BLACK FINISH.	0-10V	15' ABOVE GRADE	1550 LUMENS 11W, 4000K



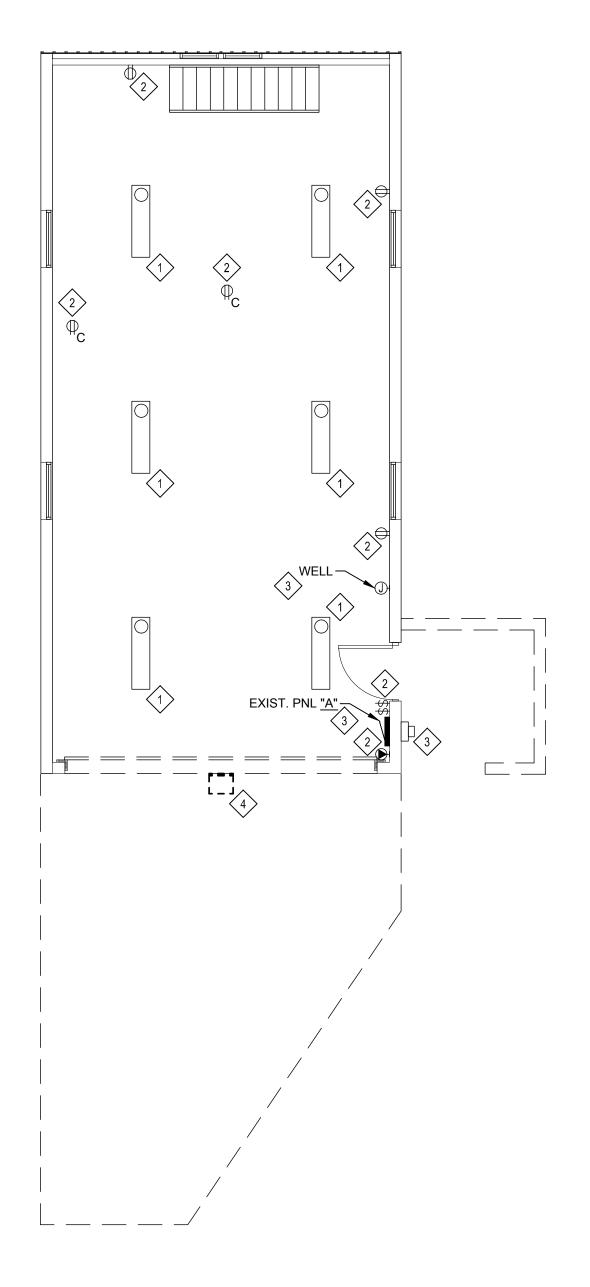

DEMOLITION NOTES

1 EXISTING LIGHT FIXTURE TO REMAIN.

2 EXISTING DEVICE TO REMAIN. (3) EXISTING EQUIPMENT TO REMAIN.

DISCONNECT & REMOVE EXISTING LIGHT FIXTURE. REMOVE ASSOCIATED CONDUIT & WIRE.

Sonse

PROJECT

SEAL

Independence Township -Bay Court Park Pole Barn

ENGINEERS

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PROJECT LOCATION

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SHEET ELECTRICAL FLOOR PLAN DEMOLITION



Know what's **below Call** before you dig.

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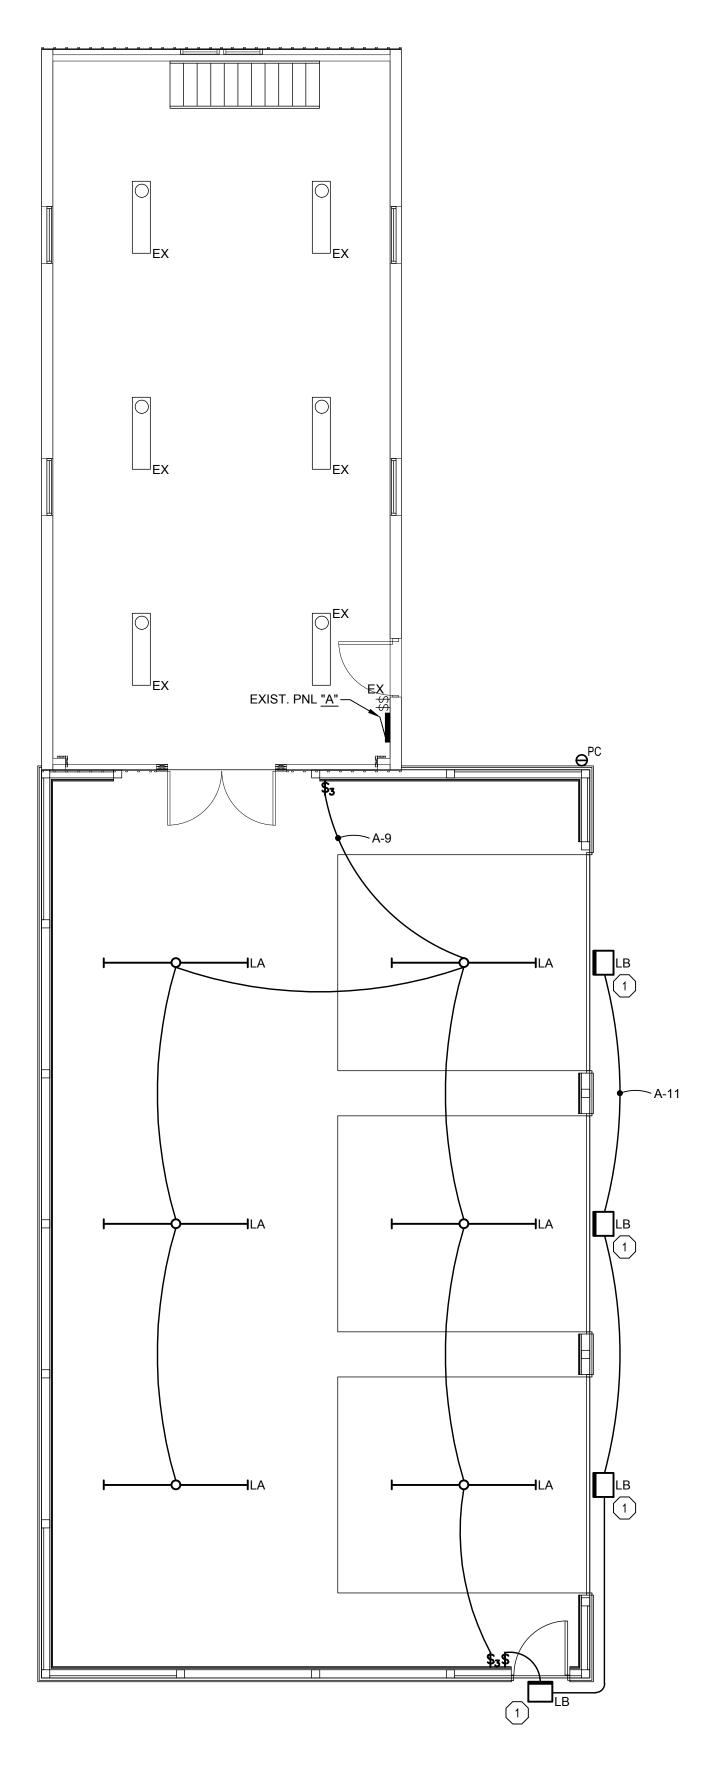
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DATE: 9/16/22 SCALE: AS SHOWN


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ELECTRICAL - FLOOR PLAN - DEMOLITION



ELECTRICAL - FLOOR PLAN - LIGHTING






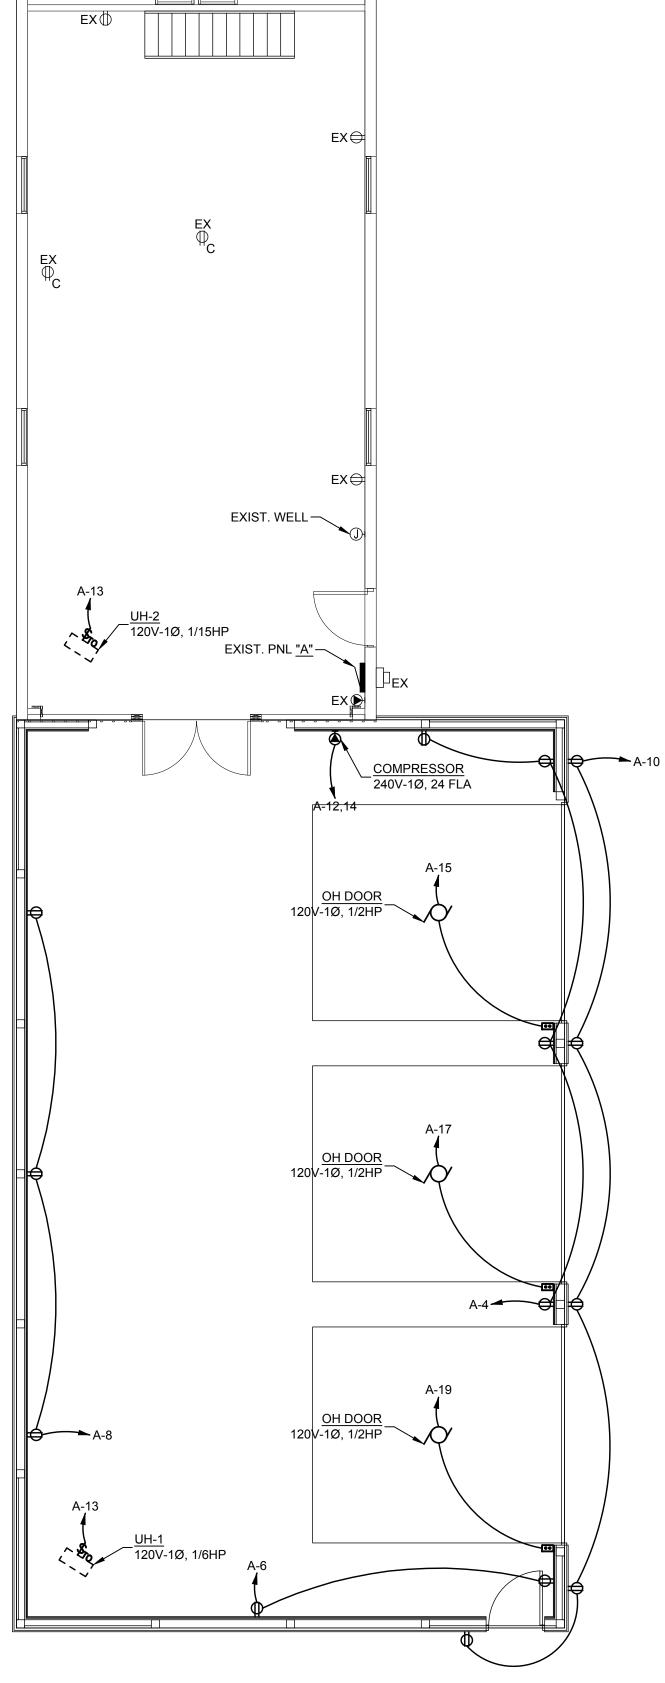



GENERAL ELECTRICAL NOTES

- ALL INTERIOR RECEPTACLES SHALL BE MOUNTED 36" ABOVE GRADE AND SHALL HAVE GFI PROTECTION.
- 2. ALL EXTERIOR RECEPTACLES SHALL BE WEATHERPROOF GFI.

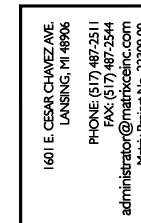

SEAL

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Independence Township

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PROJECT LOCATION

Part of the SW ¼ of Section 32 T. 4N, R. 9E City of Clarkston, Oakland County, Michigan

SHEET ELECTRICAL FLOOR PLAN LIGHTING & POWER



ISSUED/REVIS 8-02-22 OWNER REVIEW 8-23-22 OWNER REVIEW 9- 16- 22 ISSUED FOR BID

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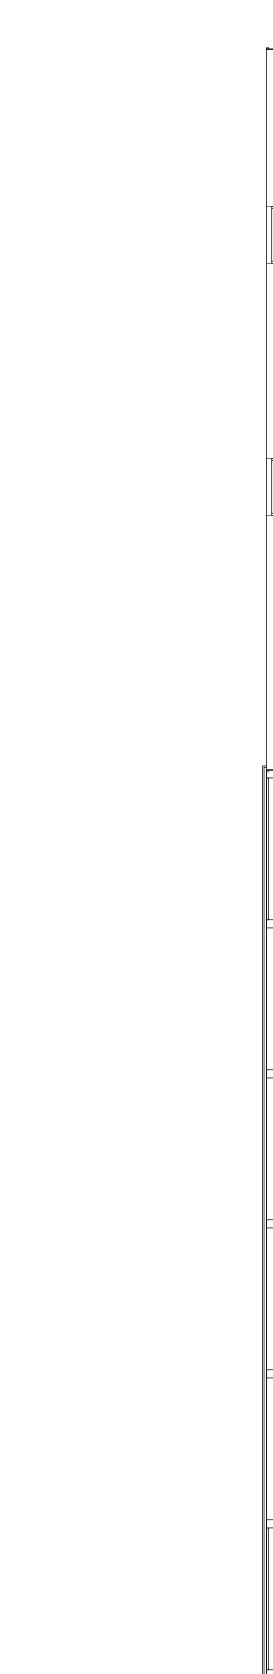
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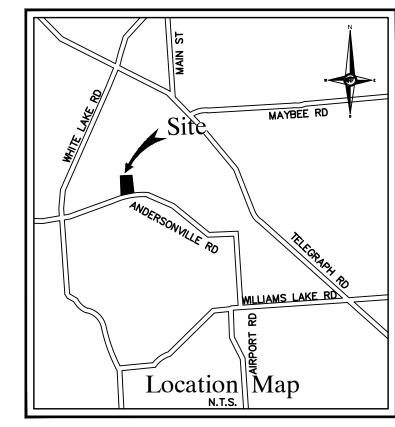
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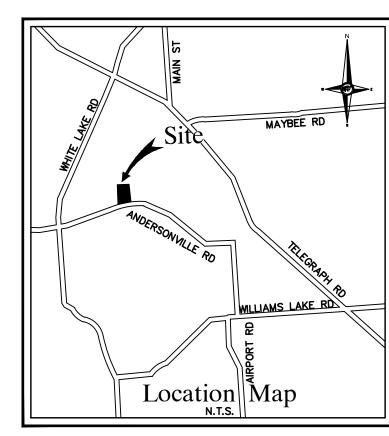
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sheet no.









			F	REV	ISED	PANEL	"A'	•			
	VOLTS:	240 /120 PHASE:	:1	WIRE:	3	AMPS: 100	MAIN:	МСВ	-		
BF	KR	DESCRIPTION	CIRCU	IT	PH	HASE LOADS	CII	RCUIT	DESCRIPTION	BR	RKR
Α	P	DESCRIPTION	VA		Α	С		VA	DESCRIPTION	A	P
20	1	EXIST. WALL RECEPTACLES		1	0		2		EXIST. CEILING RECEPTACLE	20	1
20	1	EXIST. WALL RECEPTACLES		3		720	4	720	NEW RECEPTACLES - EAST	20	1
15	1	EXIST. LIGHTS		5	360		6	360	NEW RECEPTACLES - SOUTH	20	1
15	1	EXIST. OUTSIDE POLE LIGHT		7		540	8	540	NEW RECEPTACLES - WEST	20	1
20	1	NEW INTERIOR LIGHTS	318	9	1218		10	900	NEW EXTERIOR RECEPTACLES	20	1
20	1	NEW EXTERIOR LIGHTS	44	11		2924	12	2880	NEW COMPRESSOR	30	2
20	1	NEW UH-1 & UH-2	1056	13	3936		14	2880	-	-	_
20	1	NEW GARAGE DOOR	1176	15		1176	16		EXIST. WELL	20	2
20	1	NEW GARAGE DOOR	1176	17	1176		18		-	-	-

13226 VOLT-AMPS

55.11 AMPS

6536 NEW CONNECTED LOAD

20 1 NEW GARAGE DOOR

1176 19

CONNECTED

13226

TOTAL CONNECTED

BRKR A P

20 2

0 VOLT-AMPS

0.00 AMPS

DESCRIPTION

EXIST. CEILING RECEPTACLE 20 1

EXISTING PANEL "A"

PHASE LOADS

AMPS: 100 MAIN: MCB

CIRCUIT

VA

SPACE

SPACE

SPACE

SPACE

SPACE

SPACE

SPACE

NEW CONNECTED LOAD

EXIST. WELL

PHASE: 1 WIRE: 3

CIRCUIT

CONNECTED

TOTAL CONNECTED

240 /120

20 1 EXIST. WALL RECEPTACLES

20 1 EXIST. WALL RECEPTACLES

15 | 1 | EXIST. OUTSIDE POLE LIGHT

15 1 EXIST. LIGHTS

SPACE

SPACE

SPACE


SPACE

SPACE

SPACE

DESCRIPTION

BRKR A P

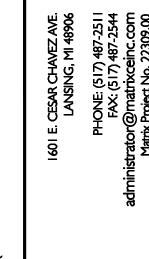

X ∪ Z A T HOUTING ENGIN Sonse, Const. ENGINEERS civil Engineers Land Surveyors Land Planners

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SEAL

PROJECT

Independence Township -Bay Court Park Pole Barn

CLIENT

Independence Township

Contact: Derek Smith Phone: (248)-625-8223 Fax: (248)-620-7454 Email: dosmith@nfe-engr.com

PROJECT LOCATION

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SHEET ELECTRICAL PANEL **SCHEDULES**



DATE	ISSUED/REV
8- 02- 22 OWNER	•
8-23-22 OWNER	
9- 16- 22 ISSUED	FOR BID
DRAWN BY:	
BTT	
DESIGNED BY:	
BTT	
APPROVED BY:	
JFS	
email contact:	NIVOEDNO CON
BTHELEN@MATE	RIXCEINC.COM
DATE:	
9/16/22	
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