

#### SHEET INDEX

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C3.3 - DETAILS

C4.1 - GRADING PLAN

- SOIL EROSION AND SEDIMENTATION CONTROL PLAN


C5.2 - SOIL EROSION AND SEDIMENTATION CONTROL DETAILS C6.1 - TOPOGRAPHICAL SURVEY

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#### **DEMOLITION NOTES**



REMOVE ASPHALT PAVEMENT TO FULL DEPTH. SAWCUT FULL DEPTH WHERE NEW PAVEMENT WILL BE PLACED ADJACENT TO EXISTING PAVEMENT. EXCAVATE EXISTING AGGREGATE BASE AND SUBGRADE AS NECESSARY TO INSTALL NEW PAVEMENT SECTION AS SHOWN ON THE PAVING PLANS, INCLUDING NEW AGGREGATE BASE.

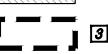

REMOVE CONCRETE PAVEMENT TO FULL DEPTH. SAWCUT FULL DEPTH TO NEAREST JOINT WHERE NEW PAVEMENT WILL BE PLACED ADJACENT TO EXISTING PAVEMENT. CLEAR AND GRUB TO THE LIMITS SHOWN. INCLUDE REMOVAL OF ALL SIGNS, POSTS, FOOTINGS, GRAVEL, BRUSH, SHRUBS, GRASS, AND TREES NOT INDICATED FOR PROTECTION, INCLUDING ROOTS. STRIP TOPSOIL AND STOCKPILE ON SITE IN DESIGNATED LOCATION.

REMOVE CONCRETE CURB AND GUTTER, SAWCUT FULL DEPTH TO NEAREST JOINT, WHERE SHOWN. REMOVAL LIMITS TO BE FIELD VERIFIED BY ENGINEER.

**5** PROTECT EXISTING CONCRETE CURB AND GUTTER TO REMAIN.

REMOVE AND SALVAGE FENCE MESH. PROTECT POSTS IN PLACE. FENCE MESH TO BE REATTACHED FOLLOWING PAVING & GRADING OPERATIONS.

REMOVE AND DISPOSE OF EXISTING CHAIN LINK FENCE, INCLUDING ALL GATES, POSTS AND FOOTINGS.

REMOVE AND SALVAGE EXISTING ORNAMENTAL FENCE, INCLUDING ALL GATES AND HARDWARE. DISPOSE OF POSTS AND FOOTINGS.

PROTECT EXISTING FENCE TO REMAIN, INCLUDING ALL GATES, POSTS, AND FOOTINGS.

REMOVE AND SALVAGE EXISTING TURNSTYLE GATE, INCLUDING ALL POSTS AND FOOTINGS.

## PROTECT EXISTING COLUMNS TO REMAIN.

PROTECT EXISTING LIGHT POLES TO REMAIN, INCLUDING BASES AND FOOTINGS.

PROTECT EXISTING UTILITIES AND UTILITY STRUCTURES TO REMAIN.

PARTIAL BUILDING REMOVAL. REFER TO ARCHITECTURAL PLANS FOR DETAILS.

FULL DEMOLITION OF TICKET BOOTH. REFER TO ARCHITECTURAL PLANS FOR DETAILS.

REMOVE AND SALVAGE EXISTING TRASH CANS. STORE IN ON SITE LOCATION AND RESET UPON COMPLETION OF CONSTRUCTION. COORDINATE WITH OWNER FOR LOCATIONS.

REMOVE EXISTING OVERHEAD ELECTRICAL LINES. REFER TO ELECTRICAL PLANS FOR DEMOLITION REQUIREMENTS.

REMOVE AND RELOCATE GAS SERVICE. GAS TO BE REMOVED BY UTILITY OWNER. COORDINATE CONSTRUCTION OPERATIONS WITH GAS COMPANY RELOCATION EFFORTS.

ADJUST EXISTING UTILITY STRUCTURE. REMOVE AND REPLACE FRAME AND COVER. REFER TO UTILITY PLAN FOR NEW RIM ELEVATIONS AND FRAME AND COVER SPECIFICATIONS.

CONTRACTOR TO PROVIDE EXPLORATORY EXCAVATION AND FIELD VERIFY IF STORM SEWER PIPE IS IN PLACE. IF SO, PROTECT EXISTING PIPE TO

CONTRACTOR TO ADJUST EXISTING 6" CLEANOUT COVER TO MATCH FINISH GRADE OF SURROUNDING PROPOSED CONCRETE. ALL DEPRESSIONS CREATED BY DEMOLITION PROCEDURES SHALL BE BACKFILLED WITH CLASS II FILL MATERIAL, IN 8" LIFTS COMPACTED TO 95% OF MAXIMUM UNIT WEIGHT, UP TO PROPOSED SUBGRADE.

CONTRACTOR IS RESPONSIBLE FOR DOING AN EARTHWORK CALCULATION FOR CUT AND FILL REQUIREMENTS, AND IS RESPONSIBLE FOR INCLUDING IMPORT AND EXPORT OF MATERIALS IN THEIR BID. ALL EXCESS MATERIAL (INCLUDING TOPSOIL, CLEAN FILL, AND WASTE MATERIAL) SHALL BE REMOVED FROM THE SITE.

EXISTING SUPPORTED SLABS AT BUILDING ENTRY/DOORS TO REMAIN, UNLESS OTHERWISE DIRECTED. CONTRACTOR TO VERIFY LIMITS OF EXISTING SUPPORTED SLAB AND REMOVE ADJACENT WALKS AS SHOWN

CONTRACTOR TO PROTECT EXISTING WALKS, PAVEMENT, CURBS, GUTTERS, WALLS, FENCES, GATES, LANDSCAPING AND TREES TO REMAIN DURING CONSTRUCTION.

#### SURVEY NOTES

. TOPOGRAPHIC AND/OR BOUNDARY SURVEY, INCLUDING PROPERTY LINES, LEGAL DESCRIPTION, EXISTING UTILITIES, SITE TOPOGRAPHY WITH SPOT ELEVATIONS, OUTSTANDING PHYSICAL FEATURES AND EXISTING STRUCTURE LOCATIONS MAY BE BASED ON RECORD DATA NOT MEASURED IN THE

2. THE CONTRACTOR IS RESPONSIBLE FOR CONFIRMING ALL INFORMATION SHOWN ON THIS SURVEY AND NOTIFYING THE ENGINEER IMMEDIATELY OF ANY DISCREPANCIES.

3. CONTRACTOR SHALL UTILIZE A PRIVATE UTILITY LOCATOR TO STAKE PUBLIC AND PRIVATE UTILITY LOCATIONS PRIOR TO START OF CONSTRUCTION. IT IS THE CONTRACTORS RESPONSIBILITY, AT NO COST TO THE PROJECT, TO REPAIR OR REPLACE ANY DAMAGE CAUSED TO EXISTING UTILITIES. 4. CONTRACTOR SHALL CONTACT MISS DIG (811) THREE WORKING DAYS PRIOR TO THE START OF CONSTRUCTION FOR STAKING OF UTILITIES.

#### **OWNER**

SOUTHGATE COMMUNITY SCHOOLS 13940 LEROY ST. SOUTHGATE, MI 48195 PHONE: (734) 246-4600





TMP ARCHITECTURE INC 1191 WEST SQUARE LAKE ROAD BLOOMFIELD HILLS MICHIGAN 48302 PH 248.388.4561 FX 248.388.0223 EM INFO TMP-ARCHITECTURE.COM

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PROJECT TITLE

# **Anderson High School** Field House

**Site Improvements** 

**Southgate Community Schools** Southgate, Michigan

DRAWING TITLE **Demolition Plan** 

ISSUE	<b>DATES</b>

02-07-2024 CONSTRUCTION DOCUMENTS

ISSUED FOR: DATE: DRAWN


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PROJECT NO.

#### **TMP 20035E** SD NP23142

DRAWING NO.



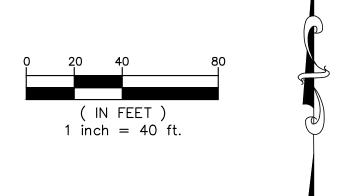

#### **DEMOLITION NOTES**

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# **Anderson High School** Field House **Site Improvements**

**Southgate Community Schools** Southgate, Michigan

DRAWING TITLE Demolition Plan -

UE	DATES	

**Alternate** 

02-07-2024 CONSTRUCTION DOCUMENTS

DATE:

ISSUED FOR: DRAWN

CHECKED APPROVED NB


PROJECT NO.

TMP 20035E SD NP23142

DRAWING NO.

C1.2



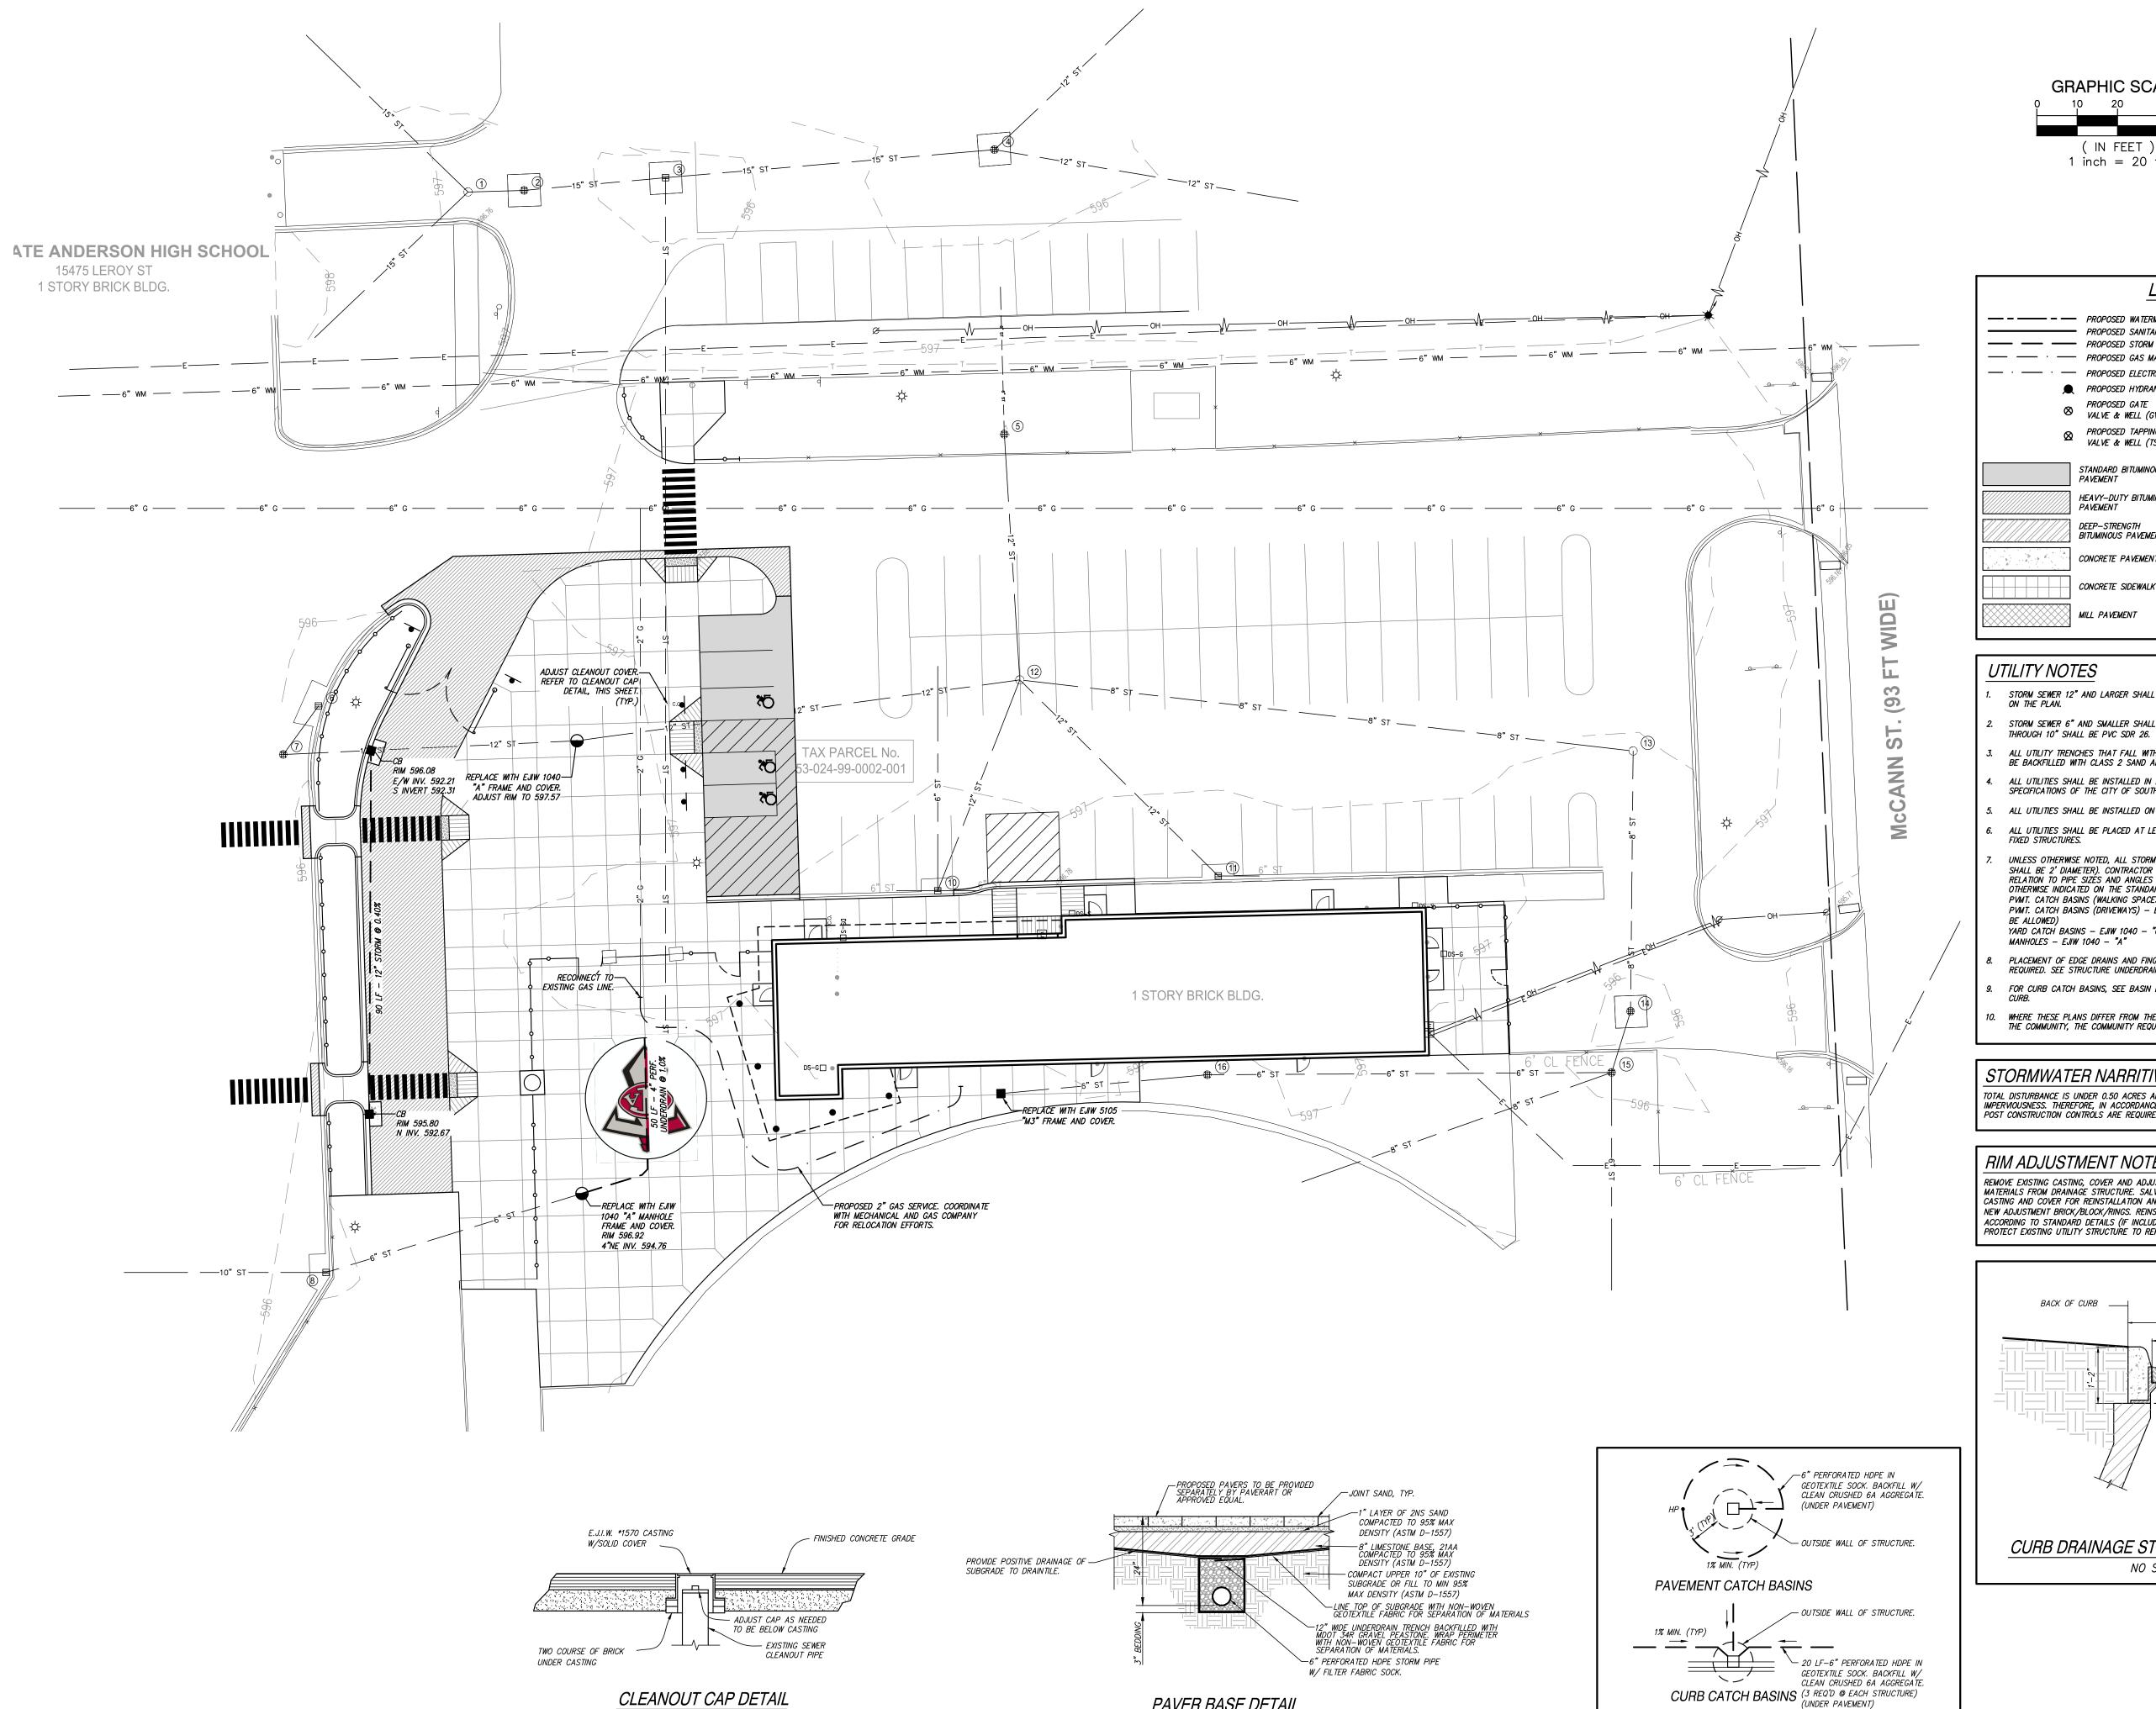



PAVER BASE DETAIL

NO SCALE

CLEANOUT CAP DETAIL

NO SCALE

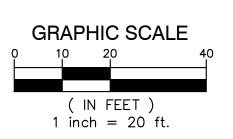

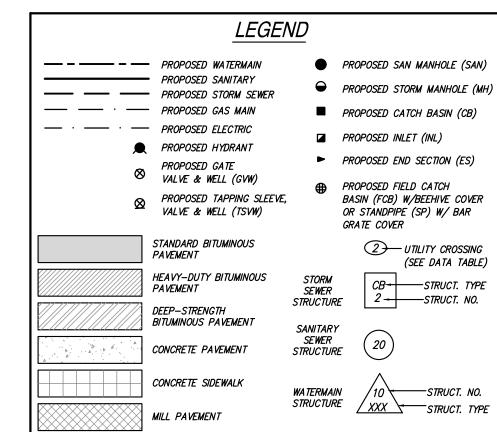

#### UTILITY NOTES

- STORM SEWER 12" AND LARGER SHALL BE C76 CL IV (PREM.JT.) UNLESS OTHERWISE NOTED ON THE PLAN.
- STORM SEWER 6" AND SMALLER SHALL BE PVC SDR 23.5. STORM SEWER GREATER THAN 6"
- ALL UTILITY TRENCHES THAT FALL WITHIN A 1-ON-1 INFLUENCE OF PAVEMENT AREAS SHALL BE BACKFILLED WITH CLASS 2 SAND AND COMPACTED TO 95% OF MAXIMUM DENSITY.
- ALL UTILITIES SHALL BE INSTALLED IN ACCORDANCE WITH THE STANDARDS AND SPECIFICATIONS OF THE CITY OF SOUTHGATE.
- ALL UTILITIES SHALL BE INSTALLED ON CLASS "B" BEDDING OR BETTER.
- ALL UTILITIES SHALL BE PLACED AT LEAST 10' FROM OTHER UTILITIES, SIGNIFICANT TREES, AND FIXED STRUCTURES.
- UNLESS OTHERWISE NOTED, ALL STORM SEWER STRUCTURES SHALL BE 4' DIAMETER (INLETS SHALL BE 2' DIAMETER). CONTRACTOR IS RESPONSIBLE FOR VERIFYING STRUCTURES SIZES IN RELATION TO PIPE SIZÉS AND ANGLES AND PRICING THEIR BID ACCORDINGLY. UNLESS OTHERWISE INDICATED ON THE STANDARD DETAIL SHEETS CASTINGS SHALL BE: PVMT. CATCH BASINS (WALKING SPACES) - EJIW 5105 - "M3" ADA ACCESSIBLE PVMT. CATCH BASINS (DRIVEWAYS) - EJIW 5105 - "M1" (FRAMES WITH CURB BOXES WILL NOT BE ALLOWED) YARD CATCH BASINS - EJIW 1040 - "02"
- PLACEMENT OF EDGE DRAINS AND FINGER DRAINS AT ALL PAVEMENT CATCH BASINS IS REQUIRED. SEE STRUCTURE UNDERDRAIN DETAIL, THIS SHEET.
- FOR CURB CATCH BASINS, SEE BASIN LOCATION DETAIL FOR BASIN STAKING RELATIVE TO THE
- WHERE THESE PLANS DIFFER FROM THE STANDARD DETAILS OR STANDARD SPECIFICATIONS OF THE COMMUNITY, THE COMMUNITY REQUIREMENTS SHALL GOVERN.


#### STORMWATER NARRITIVE:

TOTAL DISTURBANCE IS UNDER 0.50 ACRES AND RESULTS IN A NET DECREASE OF SITE IMPERVIOUSNESS. THEREFORE, IN ACCORDANCE WITH W.C.W.R.C. STORMWATER REQUIREMENTS, NO POST CONSTRUCTION CONTROLS ARE REQUIRED.

#### RIM ADJUSTMENT NOTE:

STRUCTURE UNDERDRAIN DETAIL NO SCALE

REMOVE EXISTING CASTING, COVER AND ADJUSTMENT MATERIALS FROM DRAINAGE STRUCTURE. SALVAGE CASTING AND COVER FOR REINSTALLATION AND PROVIDE NEW ADJUSTMENT BRICK/BLOCK/RINGS. REINSTALL ACCORDING TO STANDARD DETAILS (IF INCLUDED). PROTECT EXISTING UTILITY STRUCTURE TO REMAIN.

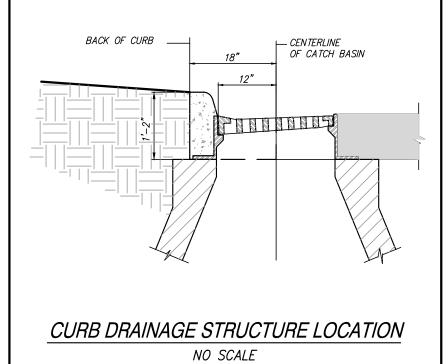





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PROJECT TITLE

**Anderson High School** Field House **Site Improvements** 

**Southgate Community Schools** 

Southgate, Michigan

DRAWING TITLE Utility Plan

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02-07-2024 CONSTRUCTION DOCUMENTS


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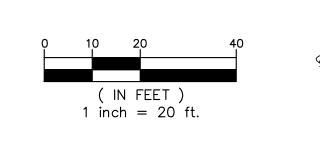
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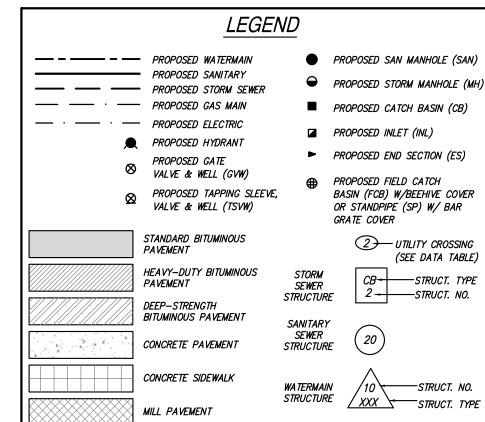
PROJECT NO.

TMP 20035E SD NP23142

DRAWING NO.





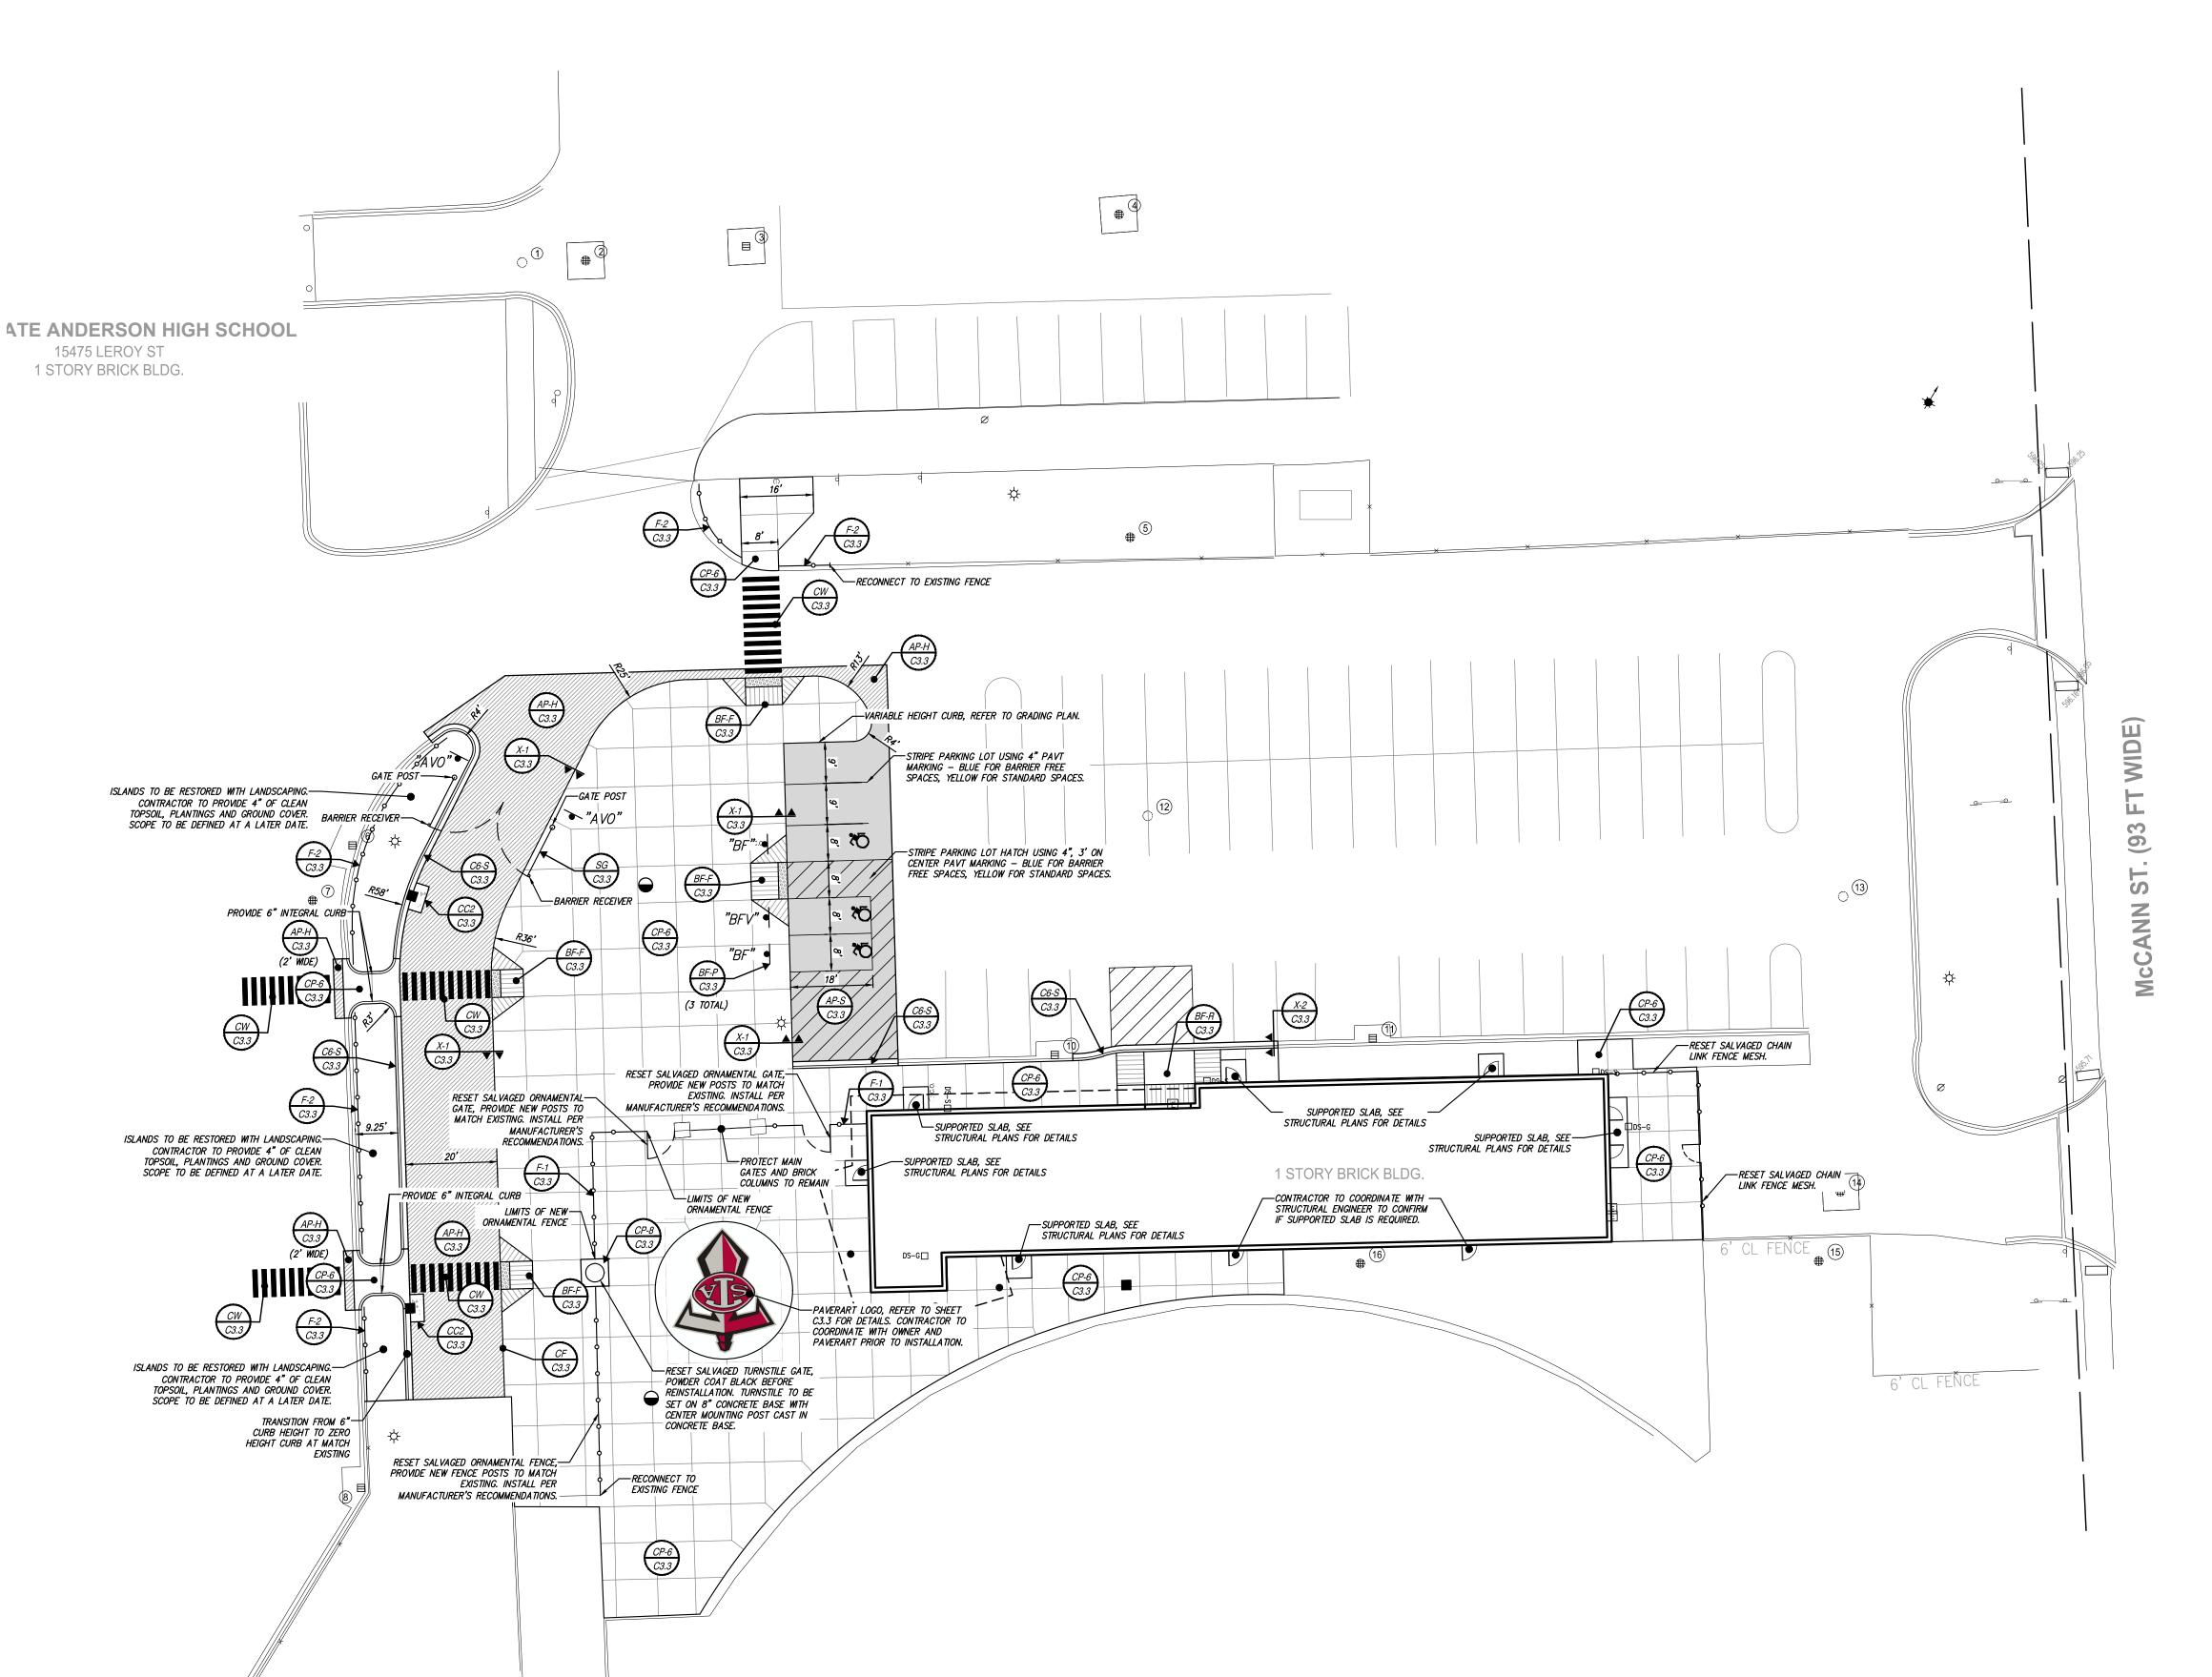

#### PAVING CONSTRUCTION NOTES

- 1. EARTHWORK AND PAVEMENT CONSTRUCTION SHALL BE PERFORMED IN ACCORDANCE WITH THE CURRENT MDOT STANDARD SPECIFICATIONS FOR CONSTRUCTION UNLESS OTHERWISE NOTED IN THE FOLLOWING ITEMS.
- 2. REMOVE ANY EXISTING TOPSOIL, VEGETATION, TREES AND OTHER DELETERIOUS MATERIALS TO EXPOSE THE SUBGRADE SOIL. TREE ROOTS SHALL BE COMPLETELY REMOVED.
- EXCAVATE TO THE DEPTH OF THE FINAL SUBGRADE ELEVATION TO ALLOW FOR GRADE CHANGES AND THE PLACEMENT OF THE RECOMMENDED PAVEMENT SYSTEM.
- 4. THE TOP 12 INCHES OF THE EXPOSED SUBGRADE SHALL BE COMPACTED TO A DENSITY NO LESS THAN 95 PERCENT OF THE MAXIMUM DENSITY AS DETERMINED BY THE MODIFIED PROCTOR (ASTM D 1557—91).
- 5. THE FINAL SUBGRADE SHALL BE THOROUGHLY PROOFROLLED UNDER THE OBSERVATION OF A GEOTECHNICAL/PAVEMENT ENGINEER. LOOSE OR YIELDING AREAS WHICH CANNOT BE MECHANICALLY STABILIZED SHALL BE REMOVED AND REPLACED WITH ENGINEERED FILL OR AS DICTATED BY FIELD CONDITIONS.
- 6. THE AGGREGATE BASE SHALL BE COMPACTED TO A DENSITY NO LESS THAN 95 PERCENT OF THE MAXIMUM DENSITY AS DETERMINED BY THE MODIFIED PROCTOR (ASTM D 1557-91). THE BASE SHALL EXTEND A MINIMUM OF 1 FOOT BEYOND THE PAVED EDGE.
- 7. ALL BITUMINOUS MATERIAL SHALL BE COMPACTED TO A DENSITY NO LESS THAN 97 PERCENT OF THE MAXIMUM DENSITY AS DETERMINED BY THE MARSHALL METHOD.
- 8. A BOND COAT OF SS-1H EMULSION IS REQUIRED BETWEEN THE LEVELING COURSE AND THE WEARING COURSE WHEN EITHER 24 HOURS HAVE ELAPSED BETWEEN PLACEMENT OF THE BITUMINOUS COURSES OR THE SURFACE OF THE PAVEMENT HAS BEEN CONTAMINATED WITH DIRT, DUST, OR FOREIGN MATERIAL. THE BOND COAT SHALL BE APPLIED IN A UNIFORM MANNER OVER THE SURFACE AT A RATE OF 0.1 GALLONS/S.Y. IN THE EVENT A BOND COAT IS NOT REQUIRED, THE LEVELING COURSE MAY REQUIRE LOCALIZED BROOM CLEANING.
- PERFORMANCE GRADE PG64-22 ASPHALT CEMENT SHALL BE USED IN THE PRODUCTION OF ALL BITUMINOUS MIXTURES. RECLAIMED ASPHALT PAVEMENT (RAP) SHALL BE ALLOWED ONLY AS SPECIFIED BY THE CURRENT MDOT STANDARD SPECIFICATIONS FOR CONSTRUCTION, UNLESS NOTED ON THE PROJECT DETAILS.
- O. CONSTRUCTION TRAFFIC SHALL BE MINIMIZED ON THE NEW PAVEMENT. IF CONSTRUCTION TRAFFIC IS ANTICIPATED ON THE PAVEMENT STRUCTURE, THE PLACEMENT OF THE FINAL LIFT SHALL BE DELAYED UNTIL THE MAJORITY OF THE CONSTRUCTION ACTIVITIES HAVE BEEN COMPLETED. THIS ACTION WILL ALLOW REPAIR OF LOCALIZED FAILURE, IF ANY DOES OCCUR, AS WELL AS REDUCE LOAD DAMAGE ON THE PAVEMENT SYSTEM. THE CONTRACTOR IS RESPONSIBLE FOR REPAIR TO ANY DAMAGED SECTION RESULTING FROM CONSTRUCTION
- 11. TAPER CURB HEIGHT DOWN TO ZERO HEIGHT IN FIVE FEET AT ALL CURB ENDINGS UNLESS OTHERWISE NOTED ON THE PLAN.
- 12. WHERE CURB AND GUTTER SECTION IS ADJACENT TO A BARRIER FREE RAMP, DROP CURB HEIGHT TO MAXIMUM 1/4" ACROSS THE RAMP OPENING.
- 13. RESTRIPE PARKING LOTS AS SHOWN, USING 4" PAVEMENT MARKING BLUE FOR BARRIER FREE SPACES, YELLOW FOR STANDARD SPACES. IF NEW PARKING LAYOUT IS NOT INDICATED, MATCH
- 14. CONTRACTOR SHALL PROTECT EXISTING CURB, GUTTER, SIDEWALK, WALLS, FENCES AND ALL OTHER EXISTING SITE FEATURES NOT INDICATED FOR REMOVAL OR REHABILITATION.
- 15. PLACE EXPANSION JOINTS WHERE NEW CONCRETE PAVEMENT OR WALKS ABUT BUILDING WALLS (PROPOSED OR EXISTING), COLUMN WALLS OR BASES, CONCRETE FOUNDATIONS OR BASES, CURBS, OR EXISTING CONCRETE PAVEMENT. PLACE JOINT SEALANT ON ALL EXPANSION JOINTS.
- 16. CONTRACTOR TO CONSTRUCT CONTRACTION AND EXPANSION JOINTS IN ALL NEW CONCRETE PAVEMENT. CONTRACTION JOINTS SHALL BE TOOLED WHERE SIDEWALK WIDTH IS 8' OR LESS, AND SHALL BE SPACED EQUAL TO THE WIDTH OF THE PAVEMENT (I.E. 8' SPACING FOR 8' WIDE WALK), BUT NOT MORE THAN 10' APART. PLACE EXPANSION JOINTS WITH JOINT SEALANT AT MAXIMUM 50' SPACING. CONTRACTOR SHALL GENERALLY MATCH THE JOINT PATTERNS FOR CONCRETE PAVEMENT WHEN SHOWN ON THE PLANS.
- 17. WHERE THESE PLANS DIFFER FROM THE STANDARD DETAILS OR STANDARD SPECIFICATIONS OF THE COMMUNITY, THE COMMUNITY REQUIREMENTS SHALL GOVERN.
- 18. CONCRETE PAVEMENT SHALL MEET THE REQUIREMENTS FOR MDOT GRADE 4000 CONCRETE PER THE CURRENT MDOT STANDARD SPECIFICATIONS FOR CONSTRUCTION.

#### PROPOSED SIGN LEGEND

"AVO" - AUTHORIZED VEHICLES ONLY (R5-11)
"BF" - RESERVED PARKING BARRIER FREE ONLY (R7-8)
"BFV" - RESERVED PARKING BARRIER FREE ONLY VAN
ACCESS (R7-8 WITH R7-8P)

ALL SIGNAGE SHALL BE IN ACCORDANCE WITH THE CURRENT M.M.U.T.C.D. AND THE MDOT TRAFFIC AND SAFETY SIGN SUPPORT STANDARD PLANS.



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PROJECT TITLE

# Anderson High School Field House Site Improvements

Southgate Community Schools

Southgate, Michigan

DRAWING TITLE

Paving Plan

ISSUE	DATES

02-07-2024 CONSTRUCTION DOCUMENTS

DATE: ISSUED FOR:

DRAWN JC

CHECKED NB

APPROVED NB

PROJECT NO.


TMP 20035E SD NP23142

DRAWING NO.

C3.1





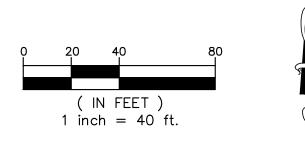

#### LEGEND — – — PROPOSED WATERMAIN PROPOSED SAN MANHOLE (SAN) PROPOSED STORM MANHOLE (MH) ---- PROPOSED STORM SEWER ---- PROPOSED GAS MAIN PROPOSED CATCH BASIN (CB) --- PROPOSED ELECTRIC ☑ PROPOSED INLET (INL) PROPOSED HYDRANT ► PROPOSED END SECTION (ES) PROPOSED GATE ⊗ VALVE & WELL (GVW) PROPOSED FIELD CATCH BASIN (FCB) W/BEEHIVE COVER OR STANDPIPE (SP) W/ BAR GRATE COVER 2 UTILITY CROSSING PAVEMENT (SEE DATA TABLE) HEAVY-DUTY BITUMINOUS CB----STRUCT. TYPE PAVEMENT 2 - STRUCT. NO. STRUCTURE DEEP-STRENGTH BITUMINOUS PAVEMENT SANITARY CONCRETE PAVEMENT CONCRETE SIDEWALK /10 STRUCT. NO. STRUCTURE XXXX STRUCT. TYPE MILL PAVEMENT

#### PAVING CONSTRUCTION NOTES

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- 8. A BOND COAT OF SS-1H EMULSION IS REQUIRED BETWEEN THE LEVELING COURSE AND THE WEARING COURSE WHEN EITHER 24 HOURS HAVE ELAPSED BETWEEN PLACEMENT OF THE BITUMINOUS COURSES OR THE SURFACE OF THE PAVEMENT HAS BEEN CONTAMINATED WITH DIRT, DUST, OR FOREIGN MATERIAL. THE BOND COAT SHALL BE APPLIED IN A UNIFORM MANNER OVER THE SURFACE AT A RATE OF 0.1 GALLONS/S.Y. IN THE EVENT A BOND COAT IS NOT REQUIRED, THE LEVELING COURSE MAY REQUIRE LOCALIZED BROOM CLEANING.
- D. PERFORMANCE GRADE PG64—22 ASPHALT CEMENT SHALL BE USED IN THE PRODUCTION OF ALL BITUMINOUS MIXTURES. RECLAIMED ASPHALT PAVEMENT (RAP) SHALL BE ALLOWED ONLY AS SPECIFIED BY THE CURRENT MDOT STANDARD SPECIFICATIONS FOR CONSTRUCTION, UNLESS NOTED ON THE PROJECT DETAILS.
- 10. CONSTRUCTION TRAFFIC SHALL BE MINIMIZED ON THE NEW PAVEMENT. IF CONSTRUCTION TRAFFIC IS ANTICIPATED ON THE PAVEMENT STRUCTURE, THE PLACEMENT OF THE FINAL LIFT SHALL BE DELAYED UNTIL THE MAJORITY OF THE CONSTRUCTION ACTIVITIES HAVE BEEN COMPLETED. THIS ACTION WILL ALLOW REPAIR OF LOCALIZED FAILURE, IF ANY DOES OCCUR, AS WELL AS REDUCE LOAD DAMAGE ON THE PAVEMENT SYSTEM. THE CONTRACTOR IS RESPONSIBLE FOR REPAIR TO ANY DAMAGED SECTION RESULTING FROM CONSTRUCTION
- 11. TAPER CURB HEIGHT DOWN TO ZERO HEIGHT IN FIVE FEET AT ALL CURB ENDINGS UNLESS OTHERWISE NOTED ON THE PLAN.
- 12. WHERE CURB AND GUTTER SECTION IS ADJACENT TO A BARRIER FREE RAMP, DROP CURB HEIGHT TO MAXIMUM 1/4" ACROSS THE RAMP OPENING.
- 13. RESTRIPE PARKING LOTS AS SHOWN, USING 4" PAVEMENT MARKING BLUE FOR BARRIER FREE SPACES, YELLOW FOR STANDARD SPACES. IF NEW PARKING LAYOUT IS NOT INDICATED, MATCH ORIGINAL STRIPING PATTERN.
- 14. CONTRACTOR SHALL PROTECT EXISTING CURB, GUTTER, SIDEWALK, WALLS, FENCES AND ALL OTHER EXISTING SITE FEATURES NOT INDICATED FOR REMOVAL OR REHABILITATION.
- 15. PLACE EXPANSION JOINTS WHERE NEW CONCRETE PAVEMENT OR WALKS ABUT BUILDING WALLS (PROPOSED OR EXISTING), COLUMN WALLS OR BASES, CONCRETE FOUNDATIONS OR BASES, CURBS, OR EXISTING CONCRETE PAVEMENT. PLACE JOINT SEALANT ON ALL EXPANSION JOINTS.
- 16. CONTRACTOR TO CONSTRUCT CONTRACTION AND EXPANSION JOINTS IN ALL NEW CONCRETE PAVEMENT. CONTRACTION JOINTS SHALL BE TOOLED WHERE SIDEWALK WIDTH IS 8' OR LESS, AND SHALL BE SPACED EQUAL TO THE WIDTH OF THE PAVEMENT (I.E. 8' SPACING FOR 8' WIDE WALK), BUT NOT MORE THAN 10' APART. PLACE EXPANSION JOINTS WITH JOINT SEALANT AT MAXIMUM 50' SPACING. CONTRACTOR SHALL GENERALLY MATCH THE JOINT PATTERNS FOR CONCRETE PAVEMENT WHEN SHOWN ON THE PLANS.
- 17. WHERE THESE PLANS DIFFER FROM THE STANDARD DETAILS OR STANDARD SPECIFICATIONS OF THE COMMUNITY, THE COMMUNITY REQUIREMENTS SHALL GOVERN.
- 18. CONCRETE PAVEMENT SHALL MEET THE REQUIREMENTS FOR MDOT GRADE 4000 CONCRETE PER THE CURRENT MDOT STANDARD SPECIFICATIONS FOR CONSTRUCTION.

#### PROPOSED SIGN LEGEND

"AVO" - AUTHORIZED VEHICLES ONLY (R5-11)
"BF" - RESERVED PARKING BARRIER FREE ONLY (R7-8)
"BFV" - RESERVED PARKING BARRIER FREE ONLY VAN
ACCESS (R7-8 WITH R7-8P)

ALL SIGNAGE SHALL BE IN ACCORDANCE WITH THE CURRENT M.M.U.T.C.D. AND THE MDOT TRAFFIC AND SAFETY SIGN SUPPORT STANDARD PLANS.





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PROJECT TITLE

# Anderson High School Field House Site Improvements

Southgate Community Schools Southgate, Michigan

DRAWING TITLE
Paving Plan Alternate

ISSUE DATES		
02-07-2024	CONSTRUCTION DO	

DATE: ISSUED FOR:

DRAWN JC
CHECKED NB


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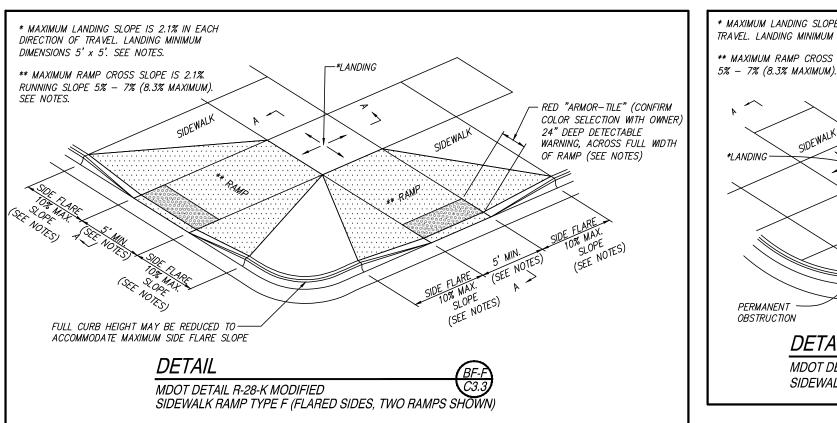
APPROVED

TMP 20035E SD NP23142

DRAWING NO.

C3.2



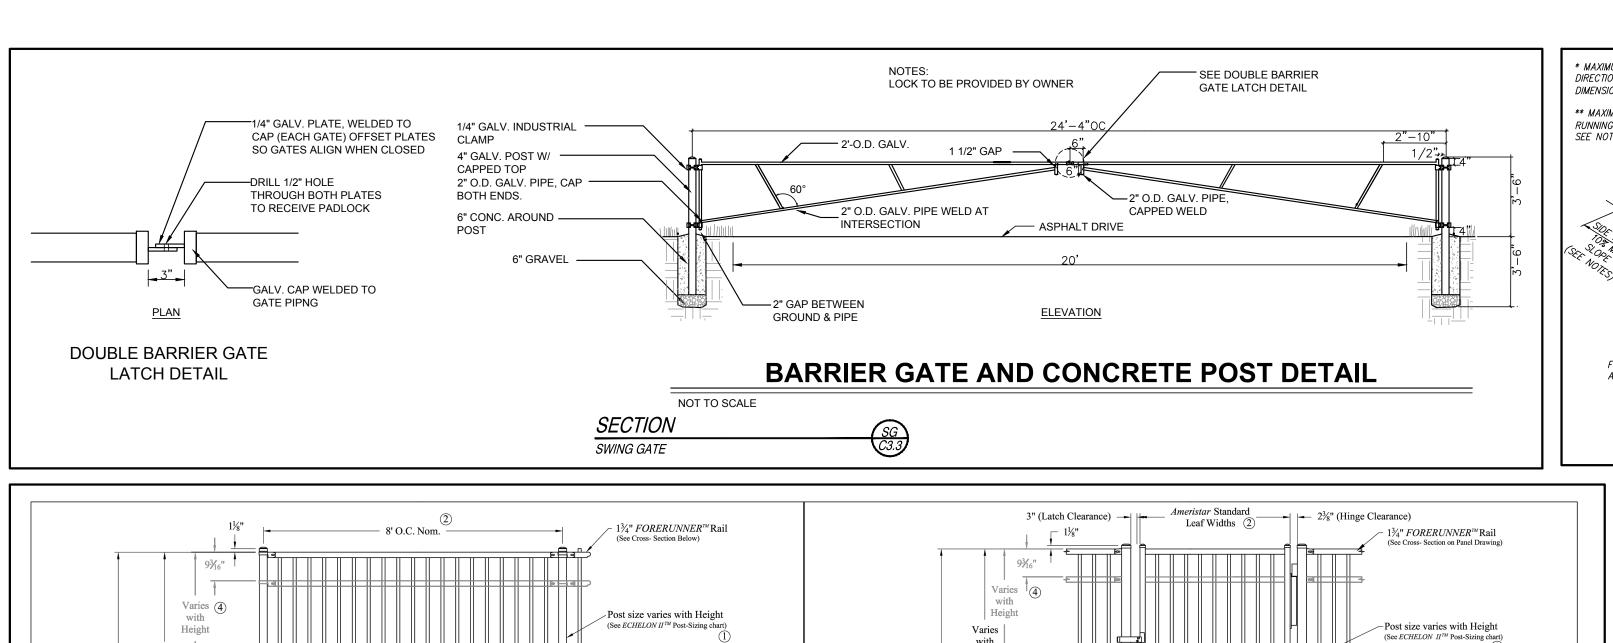

**DETAIL** 


- 4" LIMESTONE AGG. BASE,


21AA OR MDOT CLASS II


SAND (TYP @ WALKS)

PLAN TW GRADE

CURB FACE REVEAL TRANSITION

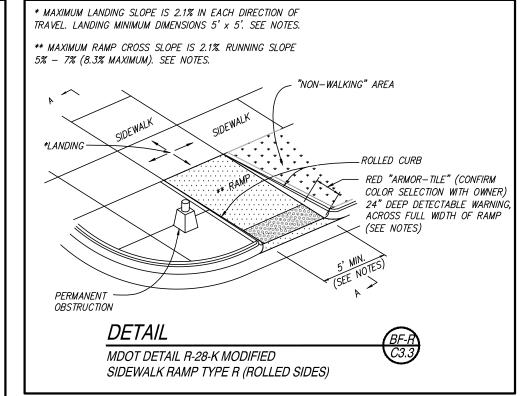


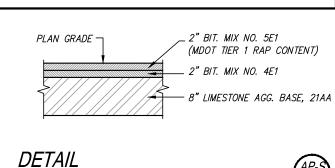

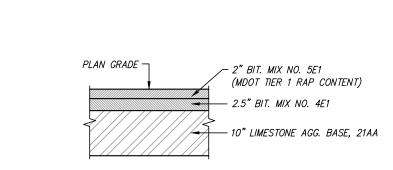

STANDARD BITUMINOUS PAVEMENT



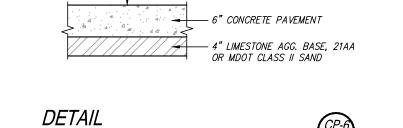


6" CONCRETE WALK

8" CONCRETE PAVEMENT



EPOXY COATED #4 BAR (TYP)


-4" LIMESTONE AGG. BASE, 21AA

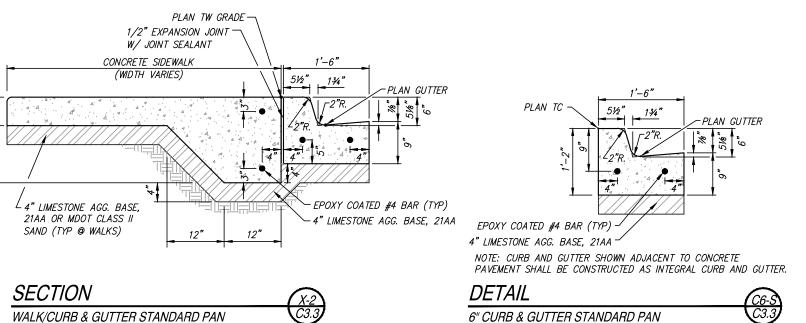


NOTE:
REMOVE EXISTING CASTING, COVER AND
ADJUSTMENT BLOCKS/BRICKS AND/OR
CONCRETE GRADE RINGS FROM DRAINAGE
STRUCTURE. PROVIDE NEW ADJUSTMENT

GRADE RINGS. RE-SET EXISTING CASTING

BLOCKS/BRICKS AND/OR CONCRETE

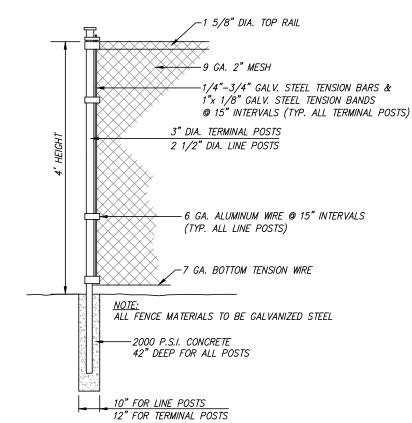



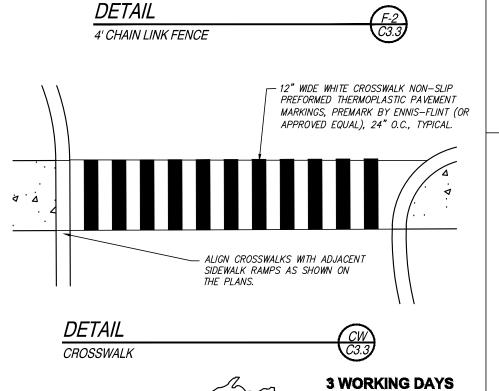



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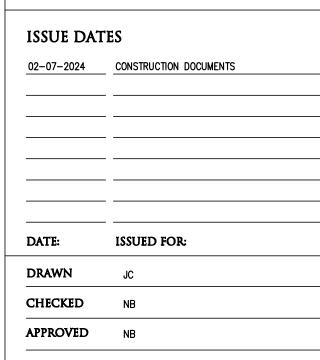
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## PROJECT TITLE **Anderson High School** Field House **Site Improvements**

**Southgate Community Schools** Southgate, Michigan

DRAWING TITLE **Details** 




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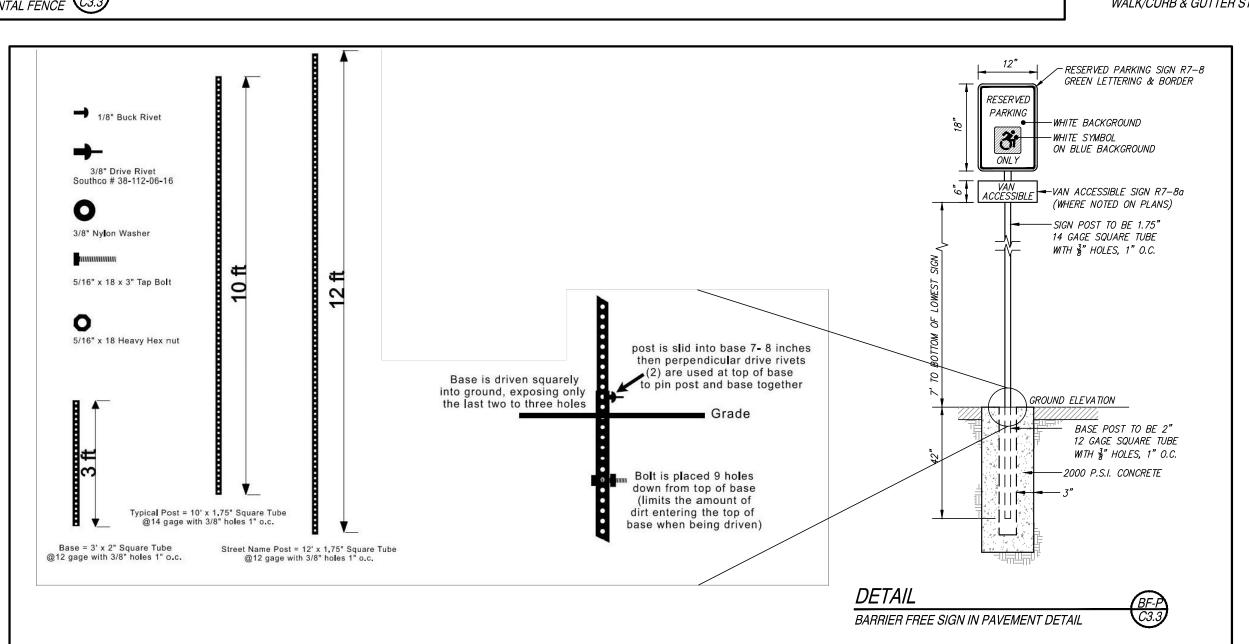
**TMP 20035E** SD NP23142


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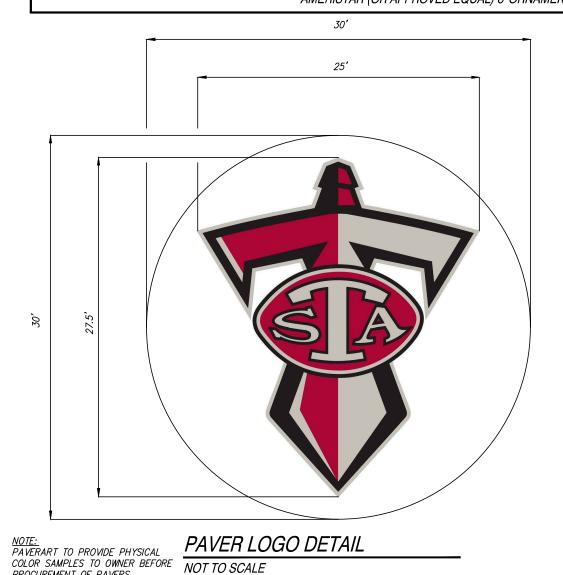
**BEFORE YOU DIG** 


CALL MISS DIG.






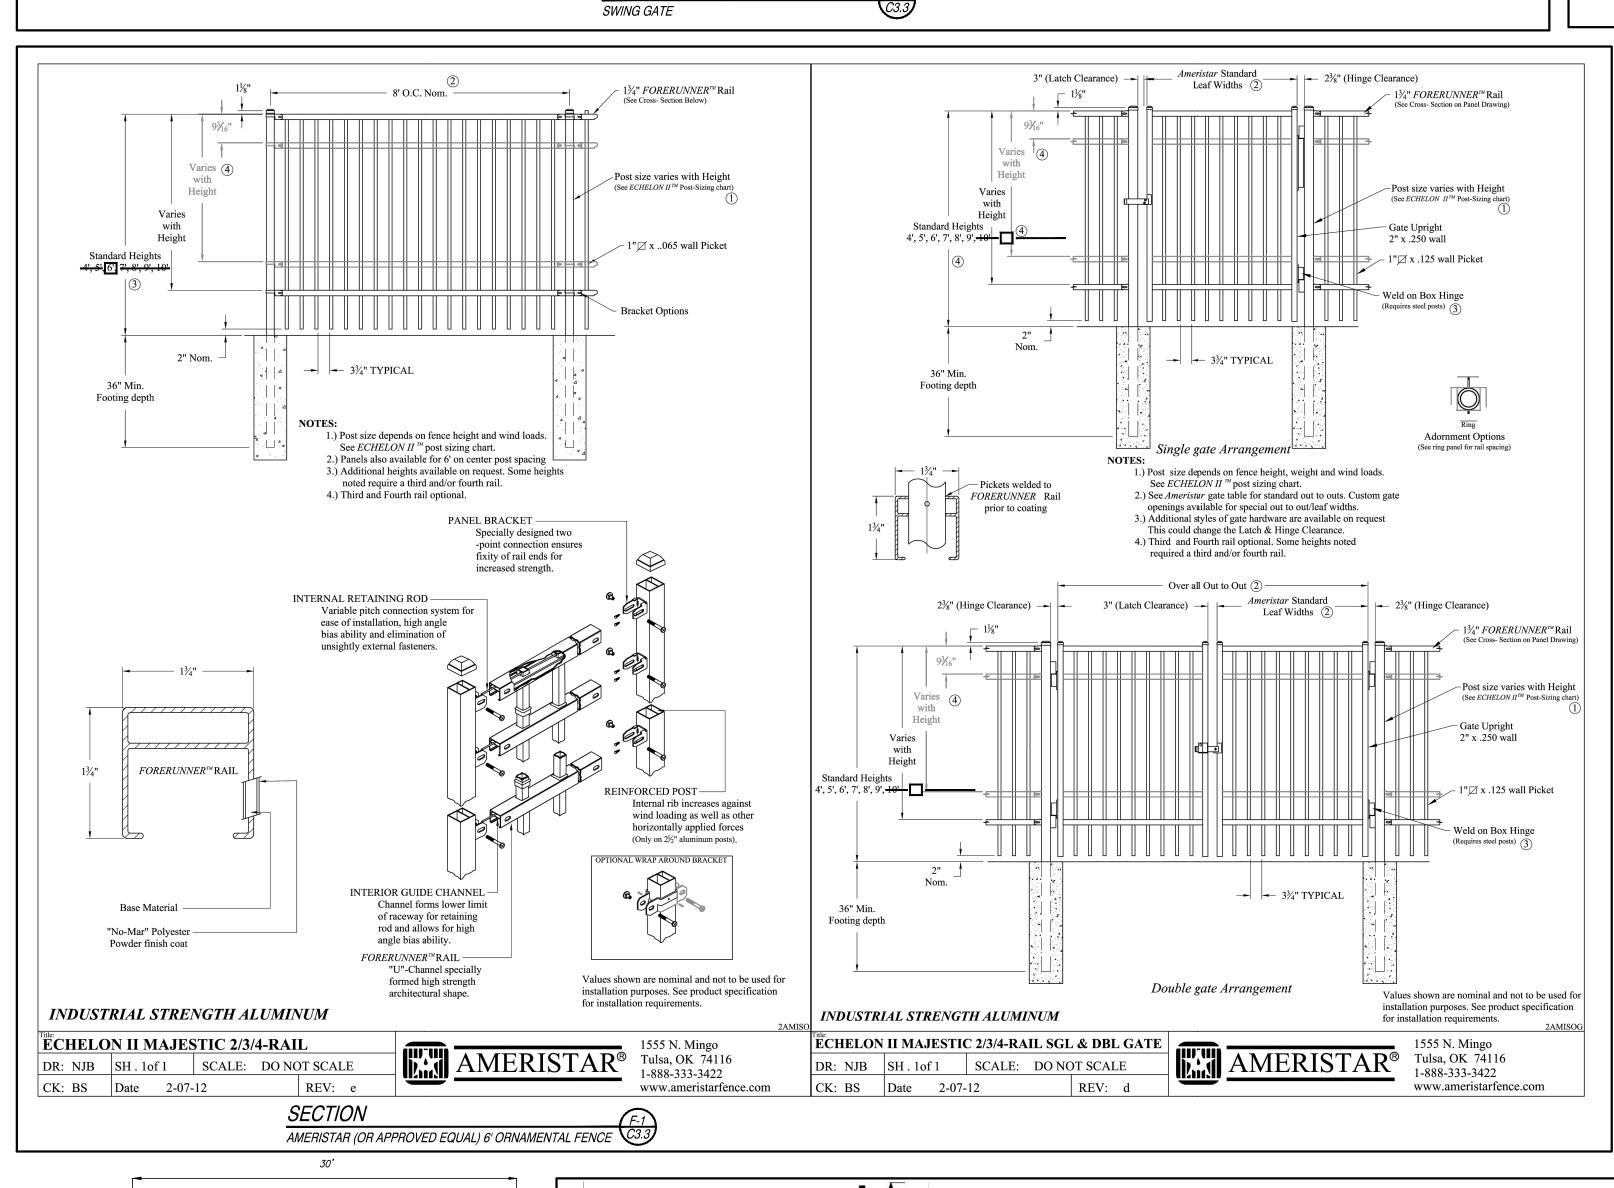

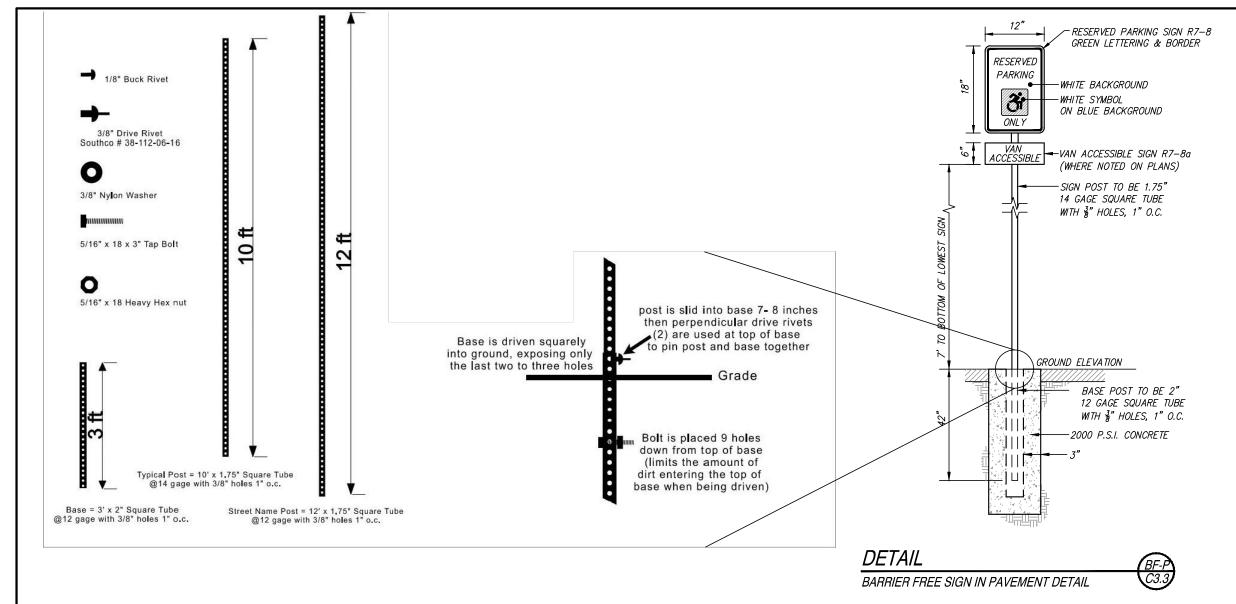

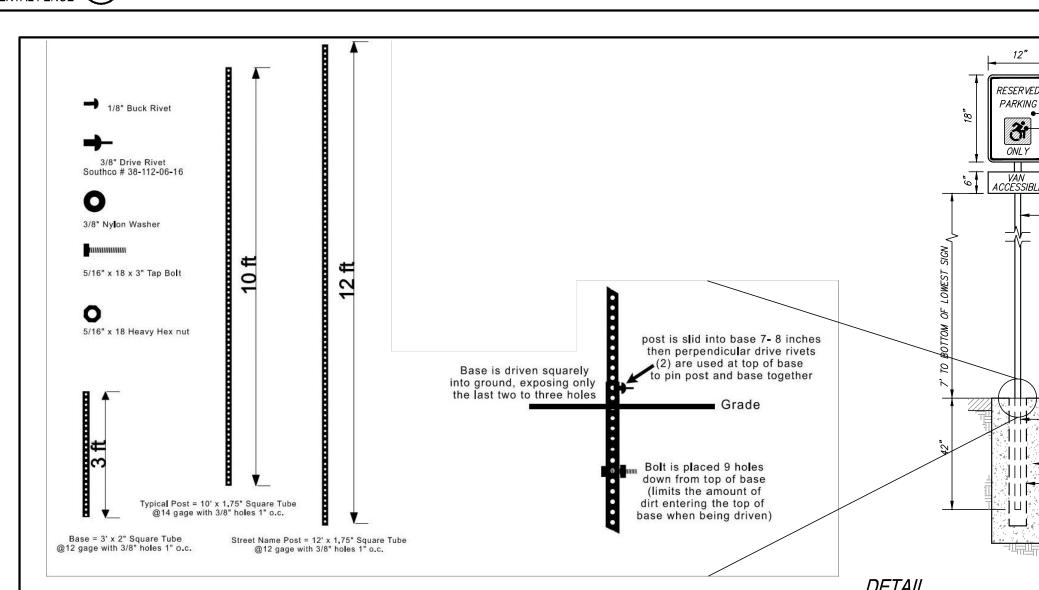


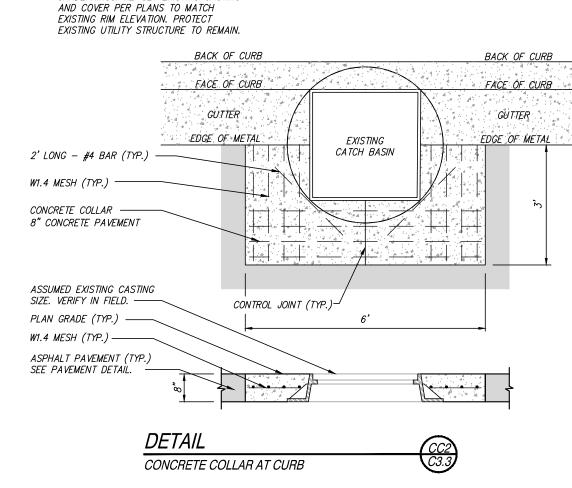



(MDOT TYPE F1)

PROCUREMENT OF PAVERS.
CONTRACTOR TO COORDINATE WITH
OWNER AND PAVERART ON SEALANT

OF PAVERS PRIOR TO INSTALLATION.

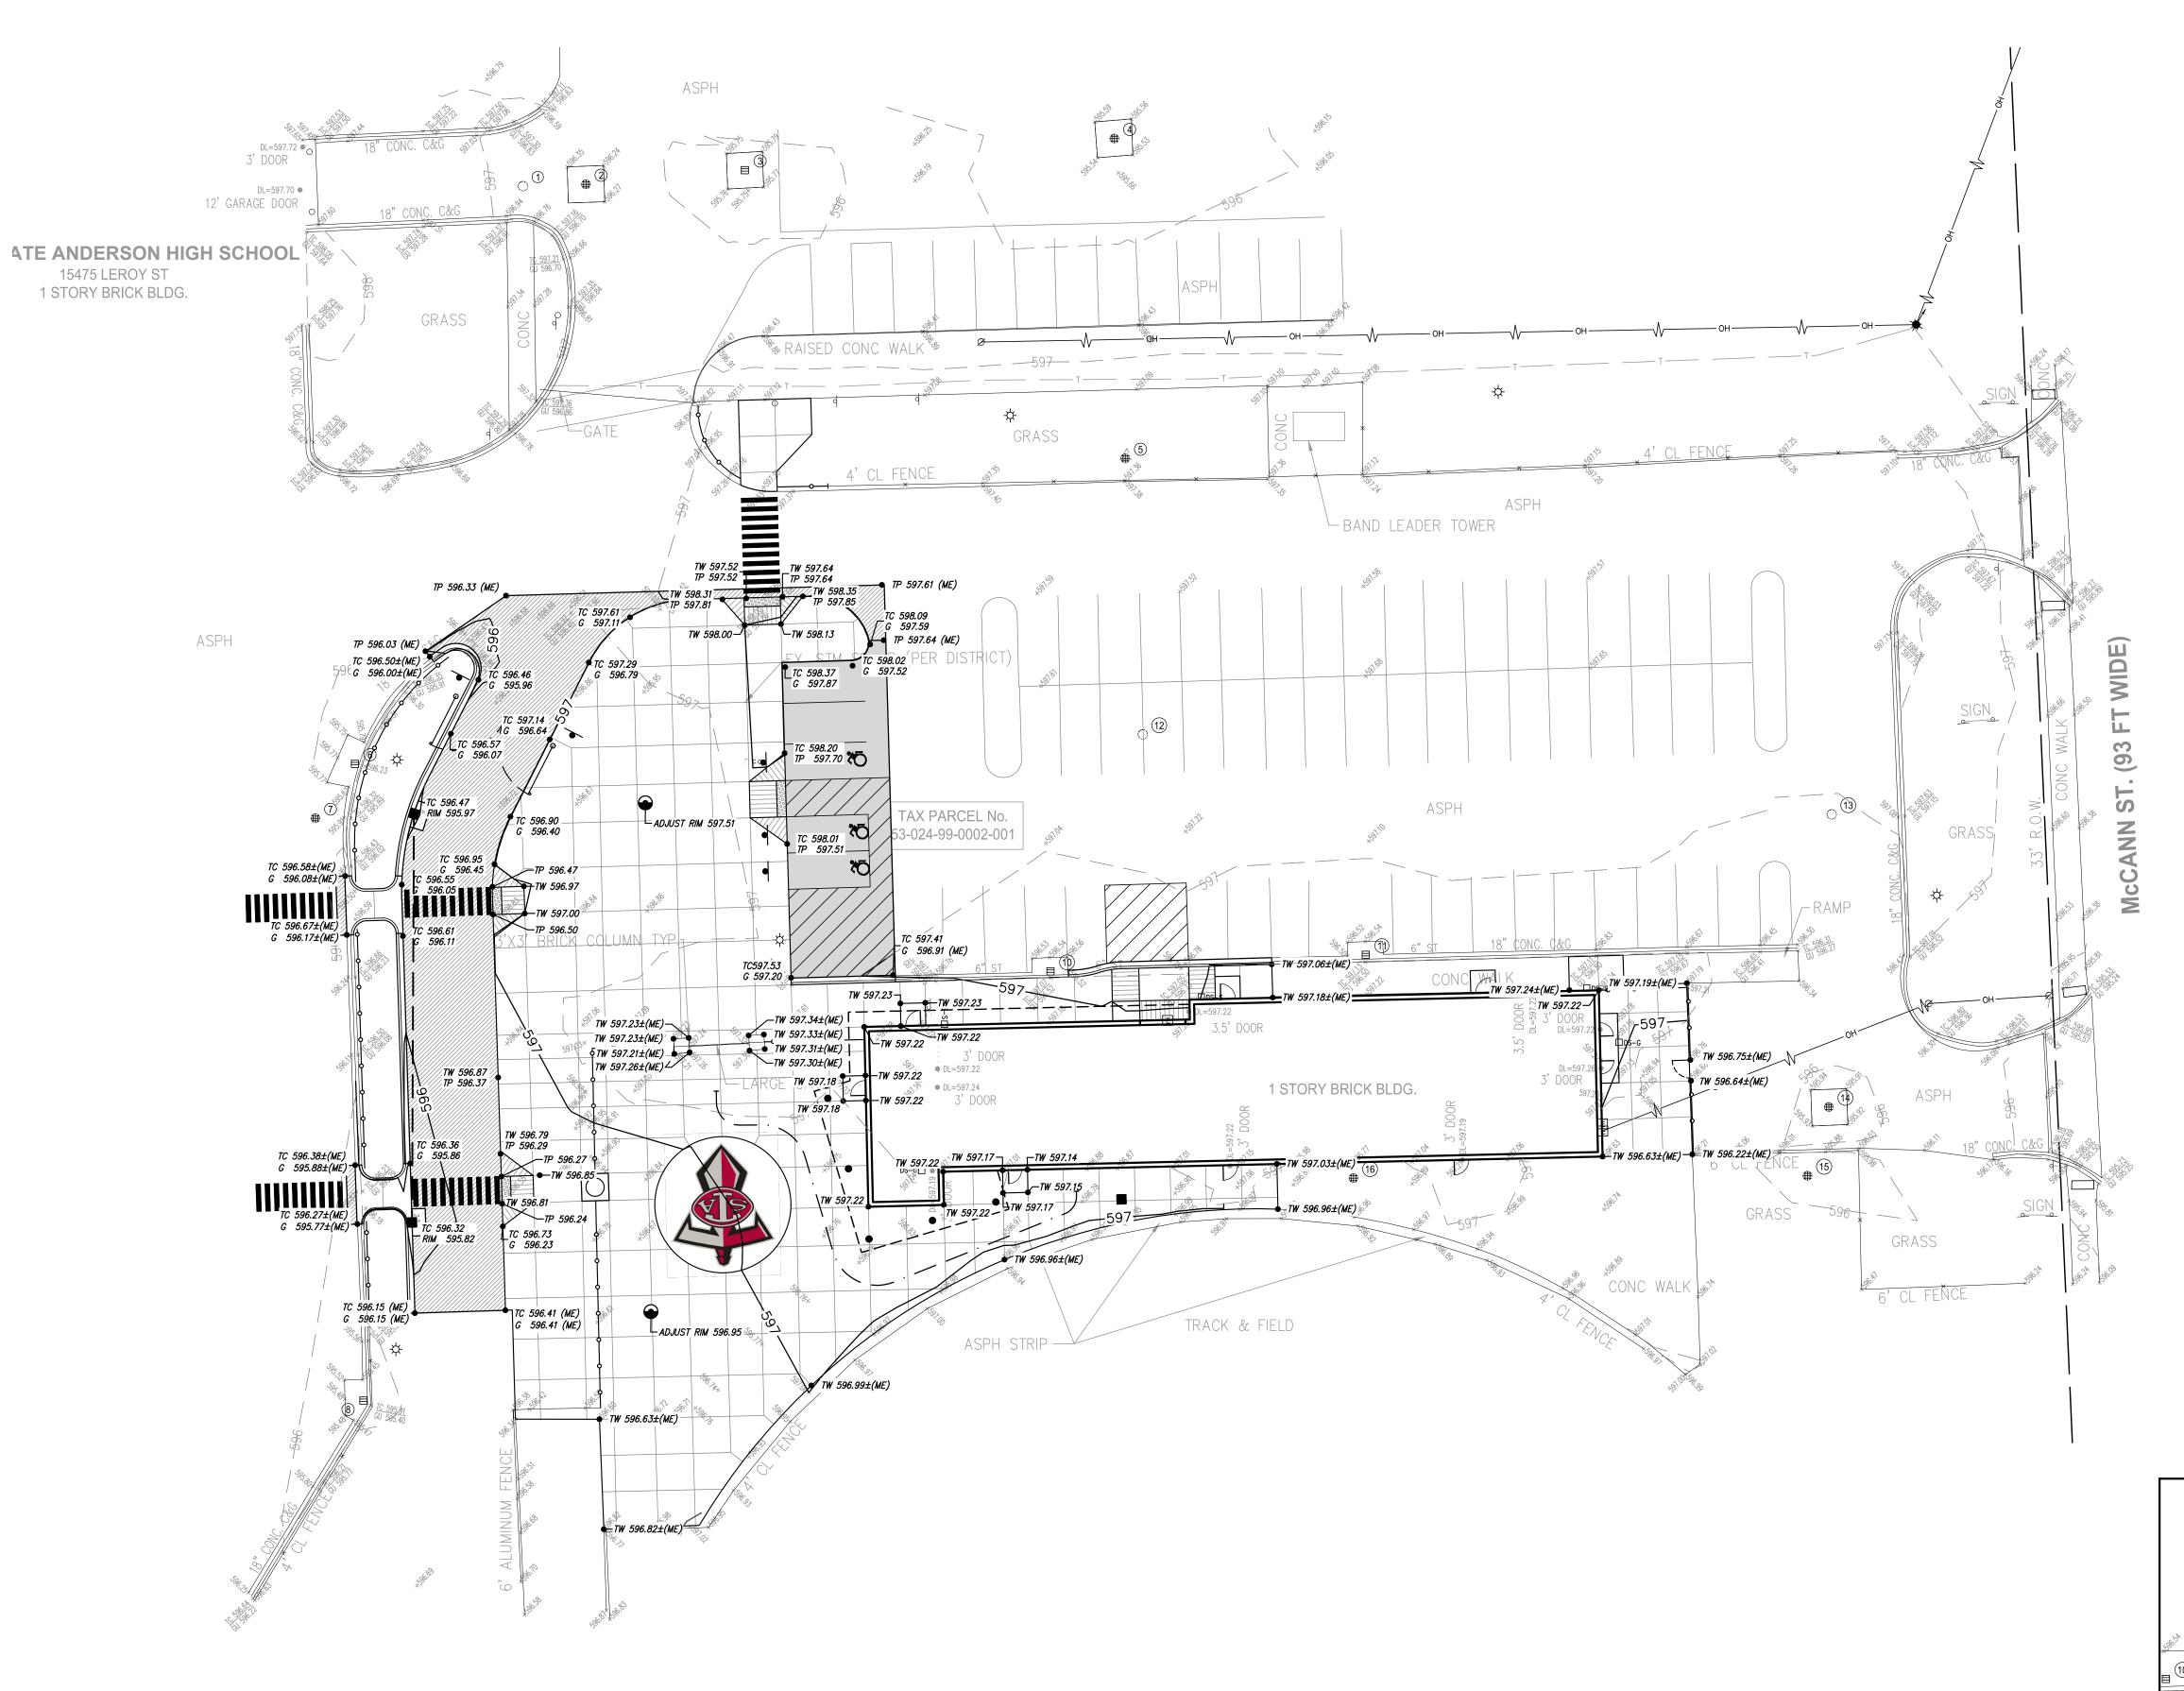

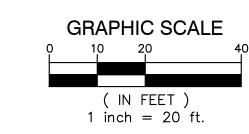

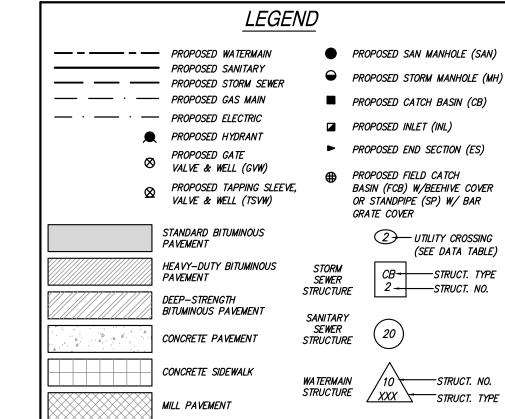

#### 

GRADING NOTES

1. CONTRACTOR TO PLACE ALL NEW PAVEMENT TO THE GRADES INDICATED, OR MATCH ORIGINAL GRADES IF NEW GRADES ARE NOT SHOWN. CONTRACTOR SHALL CONFIRM MINIMUM 1% PAVEMENT SLOPES ARE ATTAINED IN ALL AREAS.

TOP OF PAVEMENT ELEVATION

TOP OF WALK ELEVATION

• T/WALL 000.00 TOP OF WALL ELEVATION

FLOW ARROW

• ME 000.00 MATCH EXISTING ELEVATION

2. PROPOSED GRADES MAY BE BASED ON AN INTERPOLATION OF DATA SHOWN ON THE TOPOGRAPHIC SURVEY. THIS INTERPOLATED DATA IS APPROXIMATE AND COULD DIFFER SLIGHTLY BASED ON THE ACCURACY OF THE SURVEY. CONTRACTOR SHALL CONFIRM THAT THE PROPOSED GRADES SHOWN ON THIS PLAN WILL NOT CREATE A STANDING WATER CONDITION (I.E. A LOW SPOT OR PAVEMENT SLOPES LESS THAN 1%) OR AN UNSAFE CONDITION WITH SLOPES IN EXCESS OF 5%. CONTRACTOR SHALL NOTIFY ENGINEER IMMEDIATELY IF THEY BELIEVE THAT ONE OF THESE SITUATIONS WILL OCCUR BASED ON THE PROPOSED GRADES.


3. ALL PAVEMENT PLACED WITHIN BARRIER FREE PARKING AREAS (STALLS AND ACCESS AISLES) SHALL HAVE A MAXIMUM SLOPE OF 2% IN ANY DIRECTION, INCLUDING MEASURED DIAGONALLY ACROSS THE AREAS. CONTRACTOR SHALL ADJUST SLOPES AS NECESSARY TO PROVIDE ADA COMPLIANT SLOPES AS WELL AS PROVIDING RE-GRADED TRANSITION SLOPES OUTSIDE OF THE BARRIER FREE PARKING AREAS. CONTRACTOR SHALL NOTIFY ENGINEER IMMEDIATELY IF TRANSITION ZONES WILL EXCEED MAXIMUM 5% SLOPES. CONTRACTOR SHALL MAINTAIN POSITIVE DRAINAGE PATTERNS WITH ALL NECESSARY PAVEMENT RE-GRADING.

4. ALL BARRIER FREE RAMPS AND ADA ACCESSIBLE ROUTES SHALL BE CONSTRUCTED IN ACCORDANCE WITH THE CURRENT VERSION OF MDOT DETAIL R—28 "SIDEWALK RAMP AND DETECTABLE WARNING DETAILS".

5. CONTRACTOR IS RESPONSIBLE FOR CONTROLLING STORM WATER RUNOFF DURING CONSTRUCTION OPERATIONS. OF PARTICULAR CONCERN WILL BE THE TIME PERIOD AFTER THE SITE HAS BEEN STRIPPED AND NOT YET RESTORED, BUILT UPON, OR PAVED. CONTRACTOR MUST INSTALL OR CONSTRUCT APPROPRIATE TEMPORARY MEASURES TO PROTECT ADJACENT PROPERTIES.

#### RESTORATION NOTE

RESTORE ALL NON-PAVED AREAS WITH 3" OF CLEAN TOPSOIL AND SEED MIX (30% KENTUCKY BLUEGRASS, 20% PERENNIAL RYEGRASS, 50% CREEPING RED FESCUE). PLACE MULCH IN ALL SEEDED AREAS. ON SLOPES IN EXCESS OF 10 HORIZONTAL TO 1 VERTICAL PLACE NORTH AMERICAN GREEN DS150 MULCH BLANKET IMMEDIATELY AFTER SEEDING. USE METAL STAPLES PER MANUFACTURERS RECOMMENDATIONS TO HOLD MATTING IN PLACE.

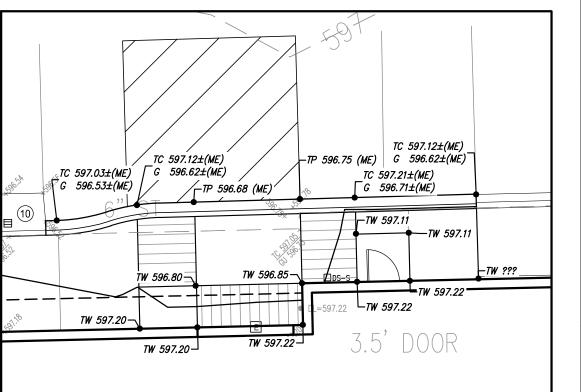

DETAIL VIEW

SCALE: 1"=10'





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PROJECT TITLE

# Anderson High School Field House Site Improvements

Southgate Community Schools
Southgate, Michigan

DRAWING TITLE

Grading Plan

ISSUE DATES		
02-07-2024	CONSTRUCTION DOCUMENTS	
	_	
DATE:	ISSUED FOR:	
DRAWN	JC	
CHECKED	ND	


PROJECT NO.


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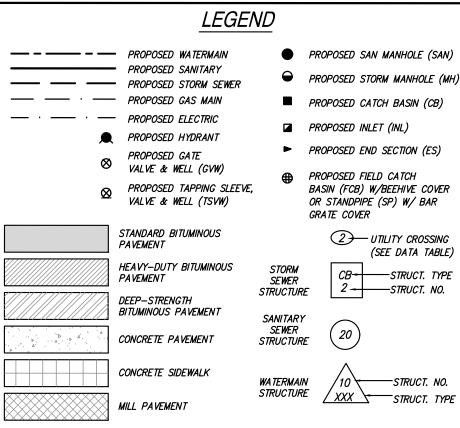
TMP 20035E SD NP23142

DRAWING NO.

C4.1



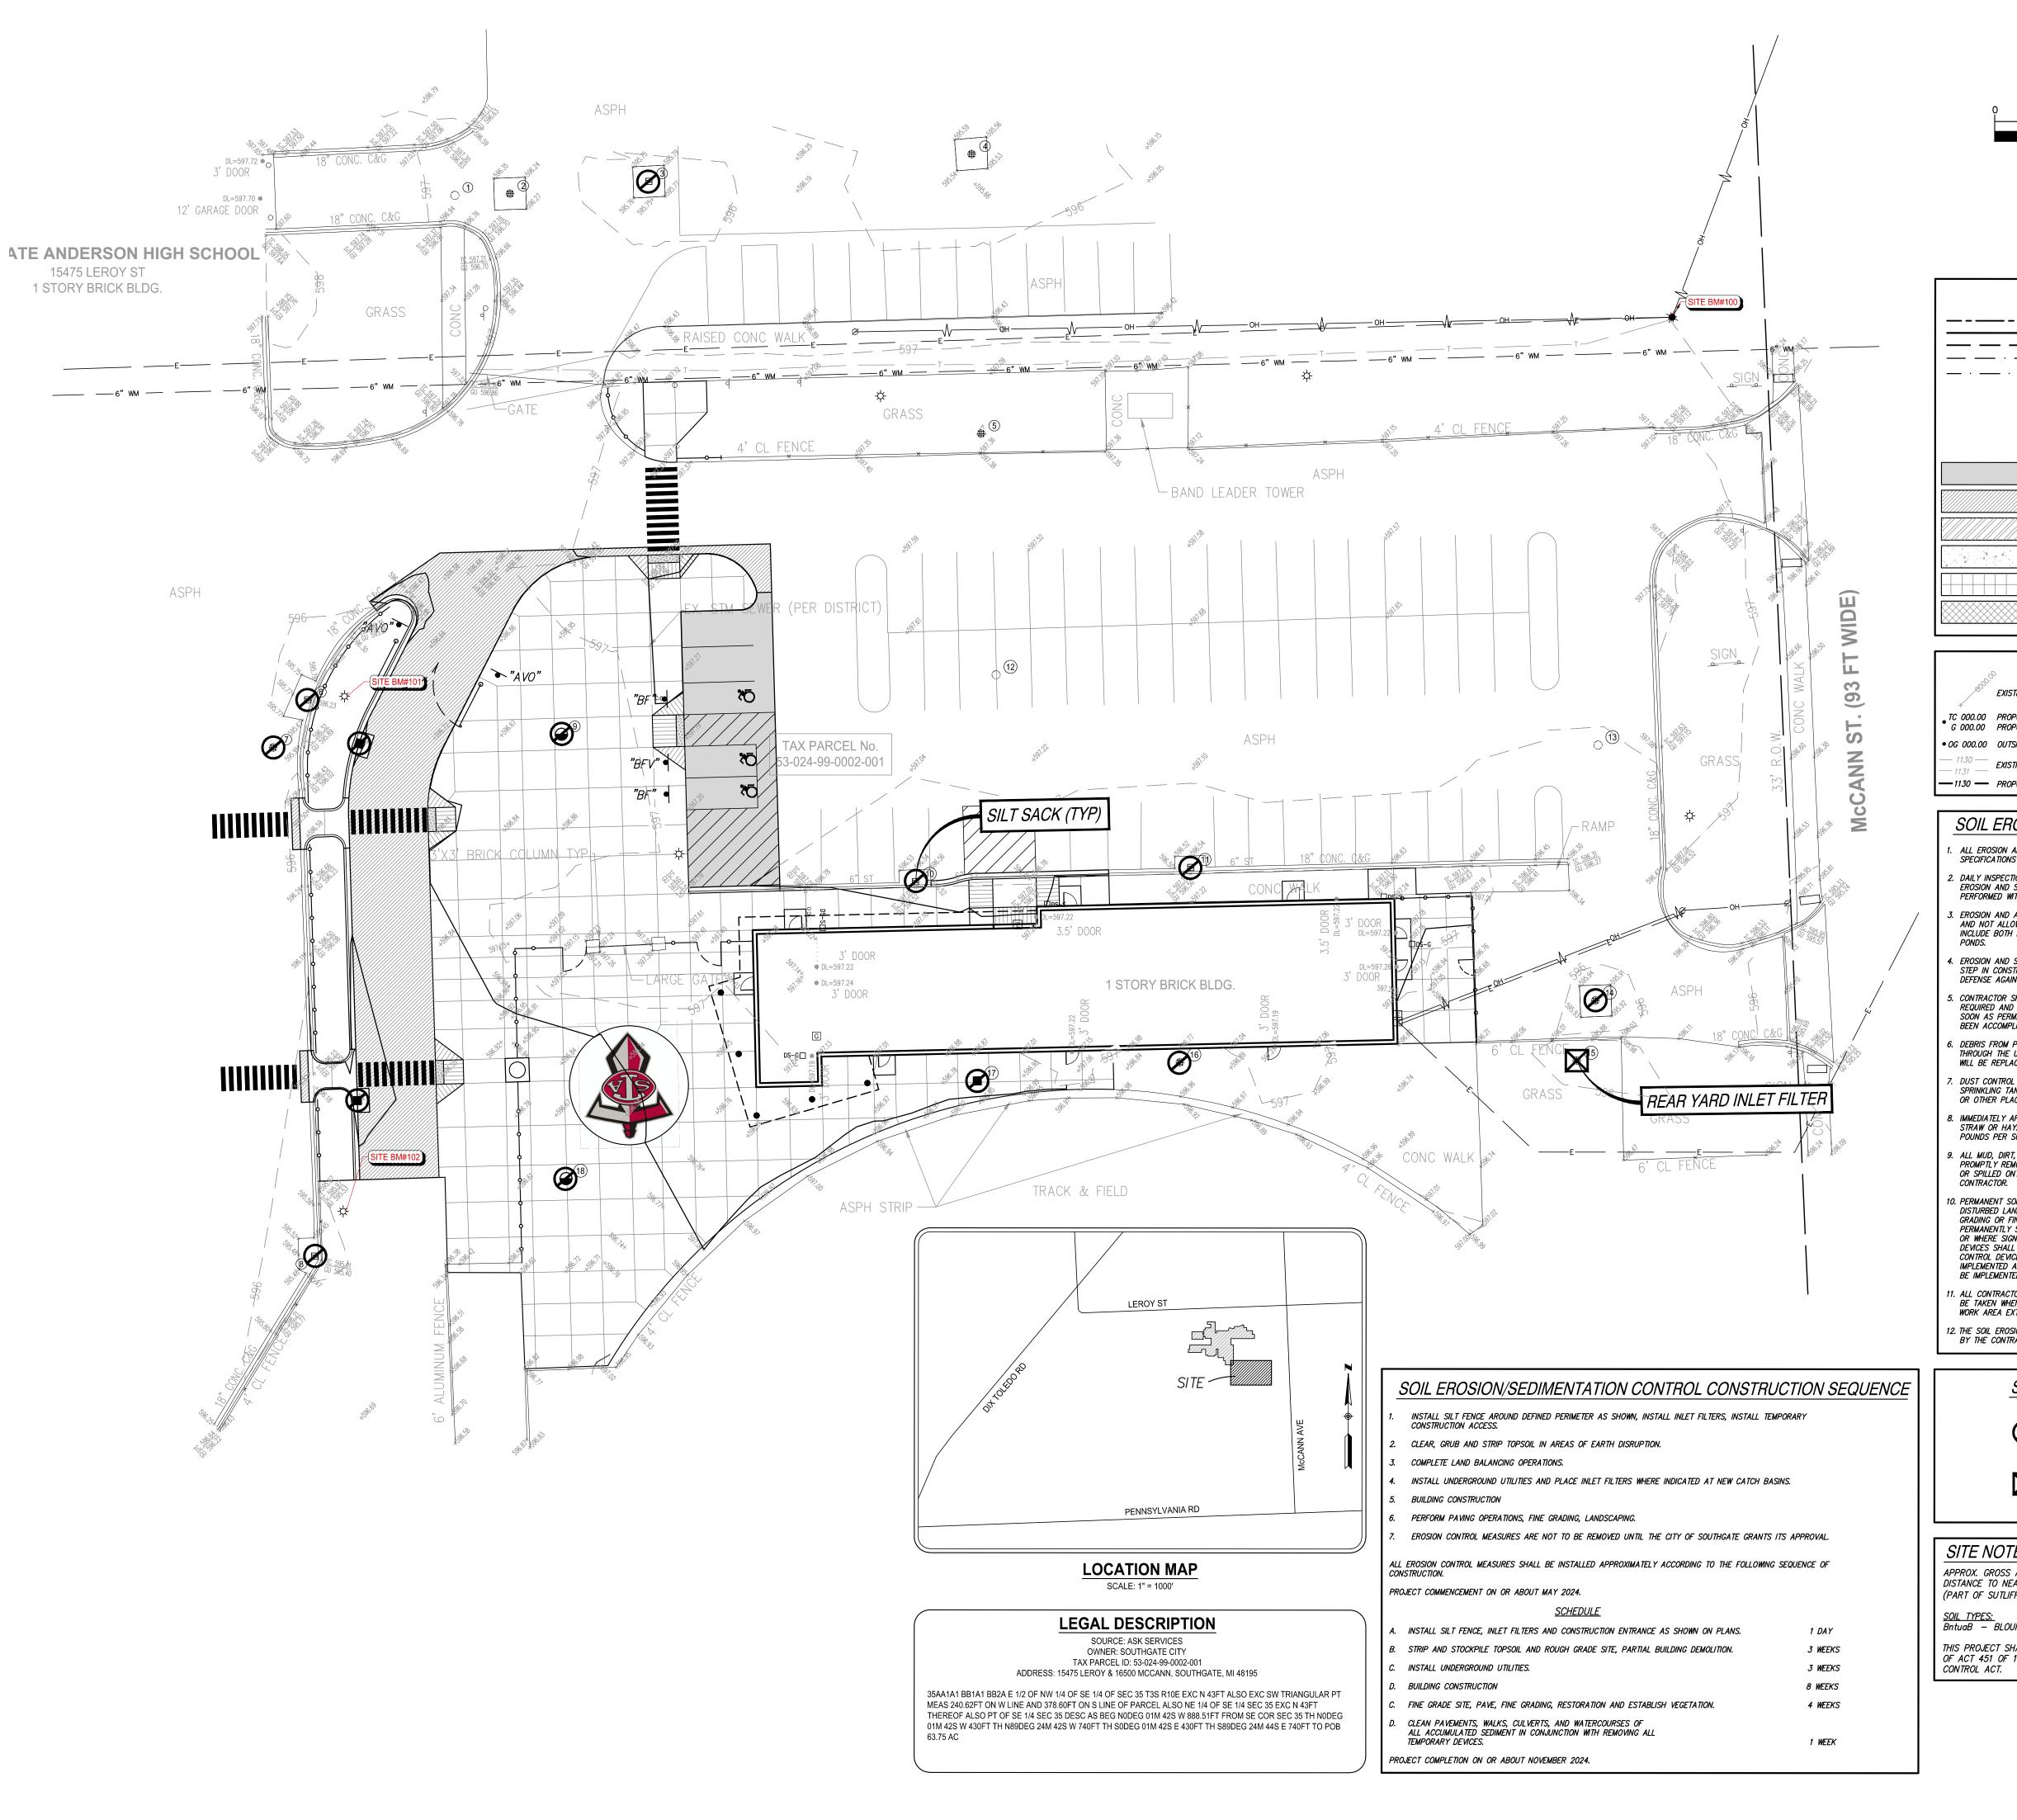

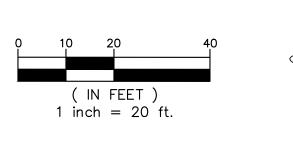

GRADING LEGEND EXISTING ELEVATION TC 000.00 PROPOSED TOP OF CURB ELEVATION G 000.00 PROPOSED GUTTER ELEVATION • OG 000.00 OUTSIDE GRADE ELEVATION EXISTING CONTOURS — 1130 — PROPOSED CONTOURS

TOP OF PAVEMENT ELEVATION

• ME 000.00 MATCH EXISTING ELEVATION FLOW ARROW

#### SOIL EROSION/SEDIMENTATION CONTROL NOTES

- ALL EROSION AND SEDIMENT CONTROL WORK SHALL CONFORM TO THE STANDARDS AND SPECIFICATIONS OF THE CITY OF SOUTHGATE.
- DAILY INSPECTIONS SHALL BE MADE BY THE CONTRACTOR TO DETERMINE EFFECTIVENESS OF EROSION AND SEDIMENTATION CONTROL DEVICES, AND ANY NECESSARY REPAIRS SHALL BE PERFORMED WITHOUT DELAY.
- EROSION AND ANY SEDIMENT FROM WORK ON THIS SITE SHALL BE CONTAINED ON THE SITE AND NOT ALLOWED TO COLLECT ON ANY OFF—SITE AREAS OR IN WATER WAYS. WATERWAYS INCLUDE BOTH NATURAL AND MANMADE OPEN DITCHES, STREAMS, STORM DRAINS, LAKES AND
- EROSION AND SEDIMENT CONTROL DEVICES ARE TO BE PLACED PRIOR TO OR AS THE FIRST STEP IN CONSTRUCTION; SEDIMENT CONTROL PRACTICES WILL BE APPLIED AS A PERIMETER DEFENSE AGAINST ANY TRANSPORTING OF SILT OFF THE SITE.
- 5. CONTRACTOR SHALL APPLY TEMPORARY EROSION AND SEDIMENTATION CONTROL DEVICES AS REQUIRED AND AS DIRECTED ON THESE PLANS. HE SHALL REMOVE TEMPORARY DEVICES AS SOON AS PERMANENT STABILIZATION OF SLOPES, DITCHES, AND OTHER EARTH CHANGES HAVE BEEN ACCOMPLISHED AND APPROVED BY THE CITY OF SOUTHGATE.
- . DEBRIS FROM PROJECT WILL BE LEFT ON THE SITE BY DELIVERY OR CONSTRUCTION VEHICLES THROUGH THE USE OF CLEAN STONE EXITS. SHOULD THE STONE BECOME LESS EFFECTIVE IT WILL BE REPLACED. ALL CONSTRUCTION TRAFFIC WILL USE THE CLEAN STONE EXIT.
- DUST CONTROL WILL BE EXERCISED AT ALL TIMES WITHIN THE PROJECT BY THE CONTRACTORS. SPRINKLING TANK TRUCKS WILL BE AVAILABLE AT ALL TIMES TO BE USED ON HAUL ROUTES OR OTHER PLACES WHERE DUST BECOMES A PROBLEM.
- IMMEDIATELY AFTER SEEDING, MULCH ALL SEEDED AREAS WITH UNWEATHERED SMALL GRAIN STRAW OR HAY. SPREAD UNIFORMLY AT A RATE OF 1 1/2 TO 2 TONS PER ACRE OR 0.10 POUNDS PER SQUARE FEET. ANCHOR MULCH WITH DISC TYPE MULCH ANCHORING TOOL.
- . ALL MUD, DIRT, AND DEBRIS TRACKED ONTO EXISTING ROADS FROM THIS SITE SHALL BE PROMPTLY REMOVED BY THE CONTRACTOR OR BUILDER. ALL MUD, DIRT, AND DEBRIS TRACKED OR SPILLED ONTO PAVED SURFACES WITHIN THIS SITE SHALL BE PROMPTLY REMOVED BY THE 10. PERMANENT SOIL EROSION CONTROL DEVICES FOR ALL SLOPES, CHANNELS, DITCHES OR ANY
- DISTURBED LAND AREA SHALL BE COMPLETED WITHIN 5 CALENDAR DAYS AFTER FINAL GRADING OR FINAL EARTH CHANGES HAVE BEEN COMPLETED. WHEN IT IS NOT POSSIBLE TO PERMANENTLY STABILIZE A DISTURBED AREA AFTER AN EARTH CHANGE HAS BEEN COMPLETED OR WHERE SIGNIFICANT EARTH CHANGE ACTIVITY CEASES TEMPORARY SOIL EROSION CONTROL DEVICES SHALL BE IMPLEMENTED WITHIN 15 CALENDAR DAYS. ALL TEMPORARY SOIL EROSION CONTROL DEVICES SHALL BE MAINTAINED UNTIL PERMANENT SOIL EROSION DEVICES ARE IMPLEMENTED AND/OR ESTABLISHED. ALL PERMANENT SOIL EROSION CONTROL DEVICES WILL BE IMPLEMENTED AND ESTABLISHED BEFORE A CERTIFICATE OF INSURANCE IS ISSUED.
- 1. ALL CONTRACTORS ARE TO KEEP EXCAVATED MATERIAL ON SITE. PARTICULAR CARE SHOULD BE TAKEN WHEN WORKING ALONG THE PERIMETER OF THE SITE. IN NO EVENT SHALL THE WORK AREA EXTEND BEYOND THE LIMITS INDICATED ON THE PLANS.
- 12. THE SOIL EROSION CONTROLS WILL BE MAINTAINED WEEKLY AND AFTER EVERY STORM EVENT

#### SOIL EROSION CONTROL DEVICES

REAR YARD INLET FILTER



#### SITE NOTES

APPROX. GROSS ACREAGE DISTURBED =  $0.70\pm$  ACRES DISTANCE TO NEAREST BODY OF WATER =  $1,050\pm$  LF FROM POND (PART OF SUTLIFF AND KENOPE DRAIN)

SOIL TYPES: BntuaB — BLOUNT—URBAN LAND COMPLEX, 0 TO 4 PERCENT SLOPES THIS PROJECT SHALL BE CONSTRUCTED IN COMPLIANCE WITH PART 91 OF ACT 451 OF 1994, AS AMENDED. THE SOIL EROSION AND SEDIMENT





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PROJECT TITLE

# **Anderson High School**

**Southgate Community Schools** 

Southgate, Michigan DRAWING TITLE Soil Erosion And **Sedimentation** 

**Control Plan** 

ISSUE DAT	ΓES	
02-07-2024	CONSTRUCTION DOCUMENTS	
	_ ·	
DATE:	ISSUED FOR:	
DRAWN	JC	
CHECKED	NB	


PROJECT NO.

APPROVED NB

**TMP 20035E** SD NP23142

DRAWING NO.

C5.1

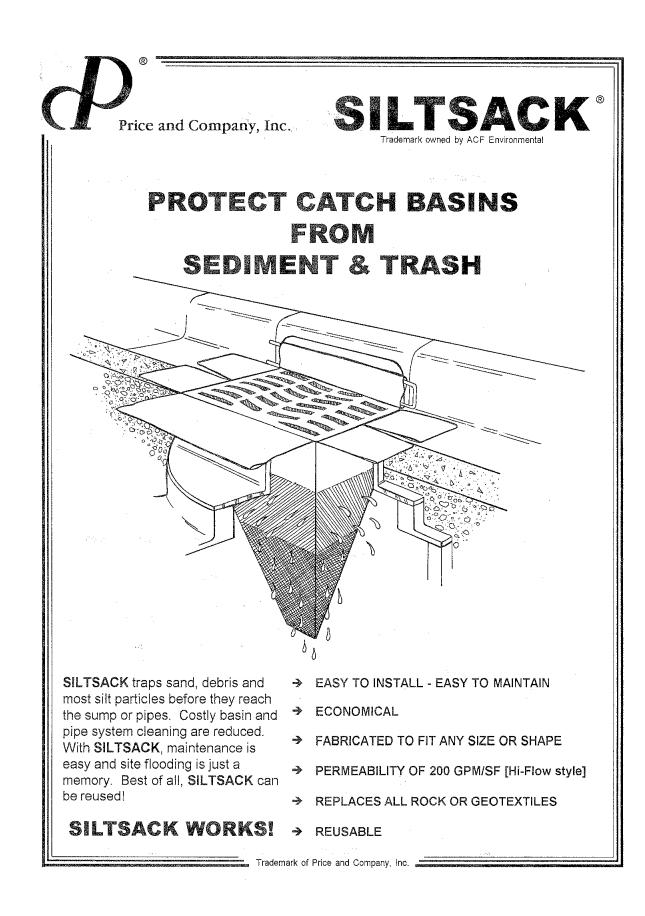

### REARYARD INLET FILTER

# SedCatch® SedCage@ Yard Inlet Protection

# MEASURE THE DIAGONAL DIMENSION OF THE GRATE, SELECT A CAGE THAT IS AT LEAST 1" LARGER. SC FLOOD WATER OPENING SedCage® RATE GEOTEXTILE TUCKED UNDER ALL FOUR SIDES OF GRATE.

SIZING INSTRUCTIONS:

#### COMPATIBLE GRATES:

A SedCage<sup>®</sup>IS COMPATIBLE WITH ALL GRATES IN WHICH THE EDGES OF THE GRATE ARE SUPPORTED BY A LEDGE.

FITS SQUARE GRATES FROM 12" X 12" THROUGH 22" X 22" FITS ROUND GRATES FROM 8" DIA. THROUGH 24" DIA. FITS RECTANGULAR GRATES WITH A DIAGONAL BETWEEN 17" AND 31" ( $\sigma^2 + b^2 = c^2$ )

32" SedCage®

FITS SQUARE GRATES FROM 19" X 19" THROUGH 29" X 29" FITS ROUND GRATES FROM 19" DIA. THROUGH 30" DIA. FITS RECTANGULAR GRATES WITH A DIAGONAL BETWEEN 28" AND 41"  $(\sigma^2 + b^2 = c^2)$ 

42" SedCage®

FITS SQUARE GRATES FROM 24" X 24" THROUGH 36" X 36" FITS ROUND GRATES FROM 24" DIA. THROUGH 40" DIA. FITS RECTANGULAR GRATES WITH A DIAGONAL BETWEEN 32" AND 53" ( $\sigma^2 + b^2 = c^2$ )

54" SedCage®

FITS SQUARE GRATES FROM 27" X 27" THROUGH 42" X 42"
FITS ROUND GRATES FROM 28" DIA. THROUGH 48" DIA.
FITS RECTANGULAR GRATES WITH A DIAGONAL
BETWEEN 44" AND 61" (02 +b2 =c2)
62" SedCage®

CUSTOM SIZES AVAILABLE



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PROJECT TITLE

Anderson High School Field House Site Improvements

Southgate Community Schools
Southgate, Michigan

DRAWING TITLE
Soil Erosion And
Sedimentation
Control Details

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02-07-2024 CONSTRUCTION DOCUMENTS

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DATE: ISSUED FOR:

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APPROVED NB

PROJECT NO.

TMP 20035E SD NP23142

DRAWING NO.

C5.2



□ FIRE HYDRANT VB SPRINKLER VALVE BOX

★ LAWN SPRINKLER HEAD ② UNVERIFIED MAPPED OBJECT E ELECTRIC RISER OR METER

T TELEPHONE RISER C CABLE TV RISER AC AIR CONDITION UNIT

∅ UTILITY POLE

UTILITY POLE W/ LAMP EXTENSION (ARROW INDICATES DIRECTION OF ARM -\$\tight pole

LIGHT POLE WITH LAMP EXTENSION 
→ TRAFFIC SIGNAL POLE W/ TRAFFIC SIGNAL (OVER ROAL

OGUY GUY WIRE

GROUND LEVEL / DECORATIVE LIGHTIN 

 METAL OR CONC. POST MB MAILBOX

→ SIGN ▼ WATER FOUNTAIN

♦ PARKING METER □□□ BILLBOARD OR LARGE SIGN

BOULDER 

BENCH BENCH BIKE RACK BIKE RACK

PICNIC TABLE

SOCCER GOAL SOCCER GOAL

STUMP ☐ DS-S DOWNSPOUT INTO STORM DRAIN ☐ DS-G DOWNSPOUT TO GROUND

CONIFEROUS TREE

DECIDUOUS TREE ★ DECIDUOUS SHRUB

CONIFEROUS SHRUB SECTION CORNER

SDA#10 TRAVERSE POINT 1 STRUCTURE NUMBER

10 SDA POINT No.

SPOT ELEVATION

TOP OF CURB ELEVATION **GUTTER ELEVATION** 

TOP OF PAVEMENT ELEVATION EDGE OF METAL ELEVATION

TOP OF WALK ELEVATION TOP OF WALL ELEVATION BOTTOM OF WALL ELEVATION **GROUND ELEVATION** 

UNDERGROUND FIBER OPTIC CONCRETE

ASPHALT FINISH FLOOR ELEVATION DOOR LEDGE ELEVATION

FOUND IRON PIPE MON FOUND MONUMENT FOUND P.K. NAIL

SET IRON W/SDA CAP S.P.K. SET P.K. NAIL

● S.P.K./TAG SET P.K. NAIL W/SDA TAG ● MAG/TAG SET MAGNETIC NAIL W/SDA TAI MEASURED

RECORD C CALCULATED

INV. INVERT ELEVATION CMP CORRUGATED METAL PIPE **— ⑤**—— G—— GAS — O——SN—— SANITARY SEWER (SAN)

— O——ST—— STORM SEWER (STM ——

WM — WATERMAIN (WM) ——OH ——✓✓ OVERHEAD WIRE — O— OIL LINE — — F — — UG FIBER (COMM.)

— E — UG ELECTRIC (ELEC. — P — T — UG PHONE (PH) — ©—— c—— — UG CABLE (CBL) × × CHAIN LINK FENCE (CL) BBBBBBBWOOD FENCE

OOOOOOOOOO GUARD RAIL EDGE OF BRUSH/WOOD —— - - - — CENTERLINE OF DITCH = = = = = CULVERT ————650——— MAJOR CONTOUR BOUNDARY LINES

- ROW LINES - SECTION LINES PROPERTY LINES ASPHALT

CONCRETE GRAVEL/ DIRT/ MULC BRICK / PAVERS

WATER

WATER W/


#### STRUCTURE TABLE

THE STRUCTURE TABLE ON THIS DRAWING IDENTIFIES THE AS-SURVEYED UNDERGROUND UTILITY MANHOLES THAT WERE FIELD MEASURED USING REASONABLE AND TRADITIONAL SURVEYING PRACTICES. PIPE SIZES, DIRECTIONS AND ELEVATIONS ARE INDICATED BY A COMBINATION OF FIELD EVIDENCE AND AVAILABLE RECORD INFORMATION. UNDERGROUND UTILITY PIPE SIZES AND CONNECTIONS ARE MANY TIMES AMBIGUOUS. SOME STRUCTURES MAY HAVE PIPES WITH UNKNOWN CONNECTIONS, SUMPS AND / OR PIPES THAT ARE FILLED WITH DEBRIS. IT WILL BE UP TO THE DESIGN ENGINEER TO LOOK AT THE PRESENTED SURVEY RESULTS AND DECIDE IF FURTHER INVESTIGATION BY OTHER METHODS SUCH AS VACUUM CLEAN OUT, UNDERGROUND RADAR, SMOKE TESTING AND PHYSICAL EXCAVATION IS REQUIRED AS AN ADDITIONAL SERVICE.


	T		I		1		
#	TYPE	RIM	SIZE	MTRL	INVERT	DIRECTION	CONNECT
1	STORM MANHOLE	596.52	15"	PVC	591.72	EAST	2
			15"	RCP	591.37	NW	
			15"	RCP	591.32	SW	
2	ROUND CATCH BASIN	596.30	15"	PVC	591.30	WEST	1
	NOONE CATOLIER	000.00	15"	PVC	591,30	EAST	3
							-
3	SQUARE CATCH BASIN	595,69	15"	CPP	591.44	EAST	4
			15"	PVC	591.44	WEST	2
4	ROUND CATCH BASIN	595.45	12"	PVC	590.65	NE	
			12"	RCP	590.60	ESE	
			15"	PVC	590.60	WEST	3
5	ROUND CATCH BASIN	596.99	6"	CPP	593.43	NORTH	
			12"	RCP	592.99	SOUTH	12
6	SQUARE CATCH BASIN	595.61	12"	RCP	592,11	SW	7
	DOUND OF THE STATE	F0F 05	16"	D05	F00 07		
7	ROUND CATCH BASIN	595.83	12"	RCP	592.28	NE	6
			12"	RCP	592.23	WEST	
			12"	RCP	592.13	EAST	9
8	SQUARE CATCH BASIN	595.39	6"	CPP	593.69	EAST	18
<u> </u>	SQUARE OATOH BAGIN	000.08	10"	PVC	592,84	WEST	10
			10	FVC	392.04	WLST	
9	ROUND CATCH BASIN	596.37	12"	RCP	592.37	WEST	7
			12"	PVC	592.37	EAST	12
10	SQUARE CATCH BASIN	596.46	6"	PVC	595,26	WEST	
			6"	PVC	595.26	EAST	
			6"	CPP	594.26	NORTH	
			12"	RCP	592.86	NNE	12
11	SQUARE CATCH BASIN	596.47	6"	PVC	593.67	EAST	
			12"	RCP	593.02	NW	12
12	STORM MANHOLE	597.50	8"	PVC	592.95	SE	13
			12"	RCP	592.95	SE	11
			12"	RCP	593.00	SW	10
			12"	RCP	592.90	NORTH	5
	TOD /MATES	E00.40	12"	PVC	592.40	WEST	Trapped to 9
	TOP / WATER	592.40					
13	STORM MANHOLE	596.91	8"	PVC	593.30	SOUTH	14
10	3.3KW WARTIOLE	550.51	8"	PVC	593.30	WNW	12
					300.01	**1444	12
14	ROUND CATCH BASIN	595.82	6"	PVC	593.41	SSW	15
			8"	PVC	593.27	WSW	
			8"	PVC	593.27	NORTH	13
15	BEE-HIVE CATCH BASIN	595.83	6"	CPP	593.78	SOUTH	
			6"	PVC	593.73	WEST	16
			6"	PVC	593.68	NNE	14
16	ROUND CATCH BASIN	596.60	6"	PVC	594.25	WEST	17
			6"	PVC	594.20	EAST	15
17	ROUND CATCH BASIN	596.66	6"	PVC	594.56	EAST	16
18	ROUND CATCH BASIN	596.16	6"	CPP	594.66	wsw	8

#### **UTILITY CHART**

UTILITY PROVIDER	CONTACT#	MISS DIG RESULTS	DATE
AT&T TELEPHONE	6168812268	RECEIVED	10/27/2023
COMCAST CABLE TV	8559628525	RECEIVED	10/24/2023
DTE ENERGY (ELECTRIC) ELECTRIC	3134075364	RECEIVED	11/2/2023
DTE ENERGY (GAS) GAS	2483187839	RECEIVED	10/24/2023
SOUTHGATE CITY POTABLE WATER	7342583074	RECEIVED	10/25/2023
SOUTHGATE CITY SANITARY SEWER	7342583074	RECEIVED	10/25/2023
SOUTHGATE CITY STORM SEWER	7342583074	RECEIVED	10/25/2023
SOUTHGATE COMMUNITY SCHOOLS FIBER OPTICS	6164559840	RECEIVED	10/19/2023
WIDE OPEN WEST CABLE TV	5864533335	RECEIVED	10/23/2023
WIDE OPEN WEST FIBER OPTICS	5864533335	RECEIVED	10/23/2023

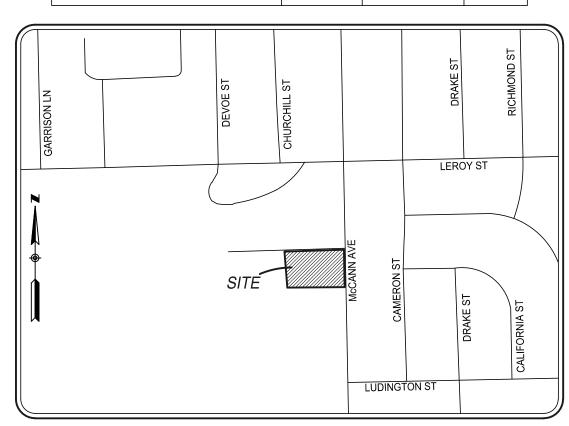

**LOCATION MAP** NOT TO SCALE

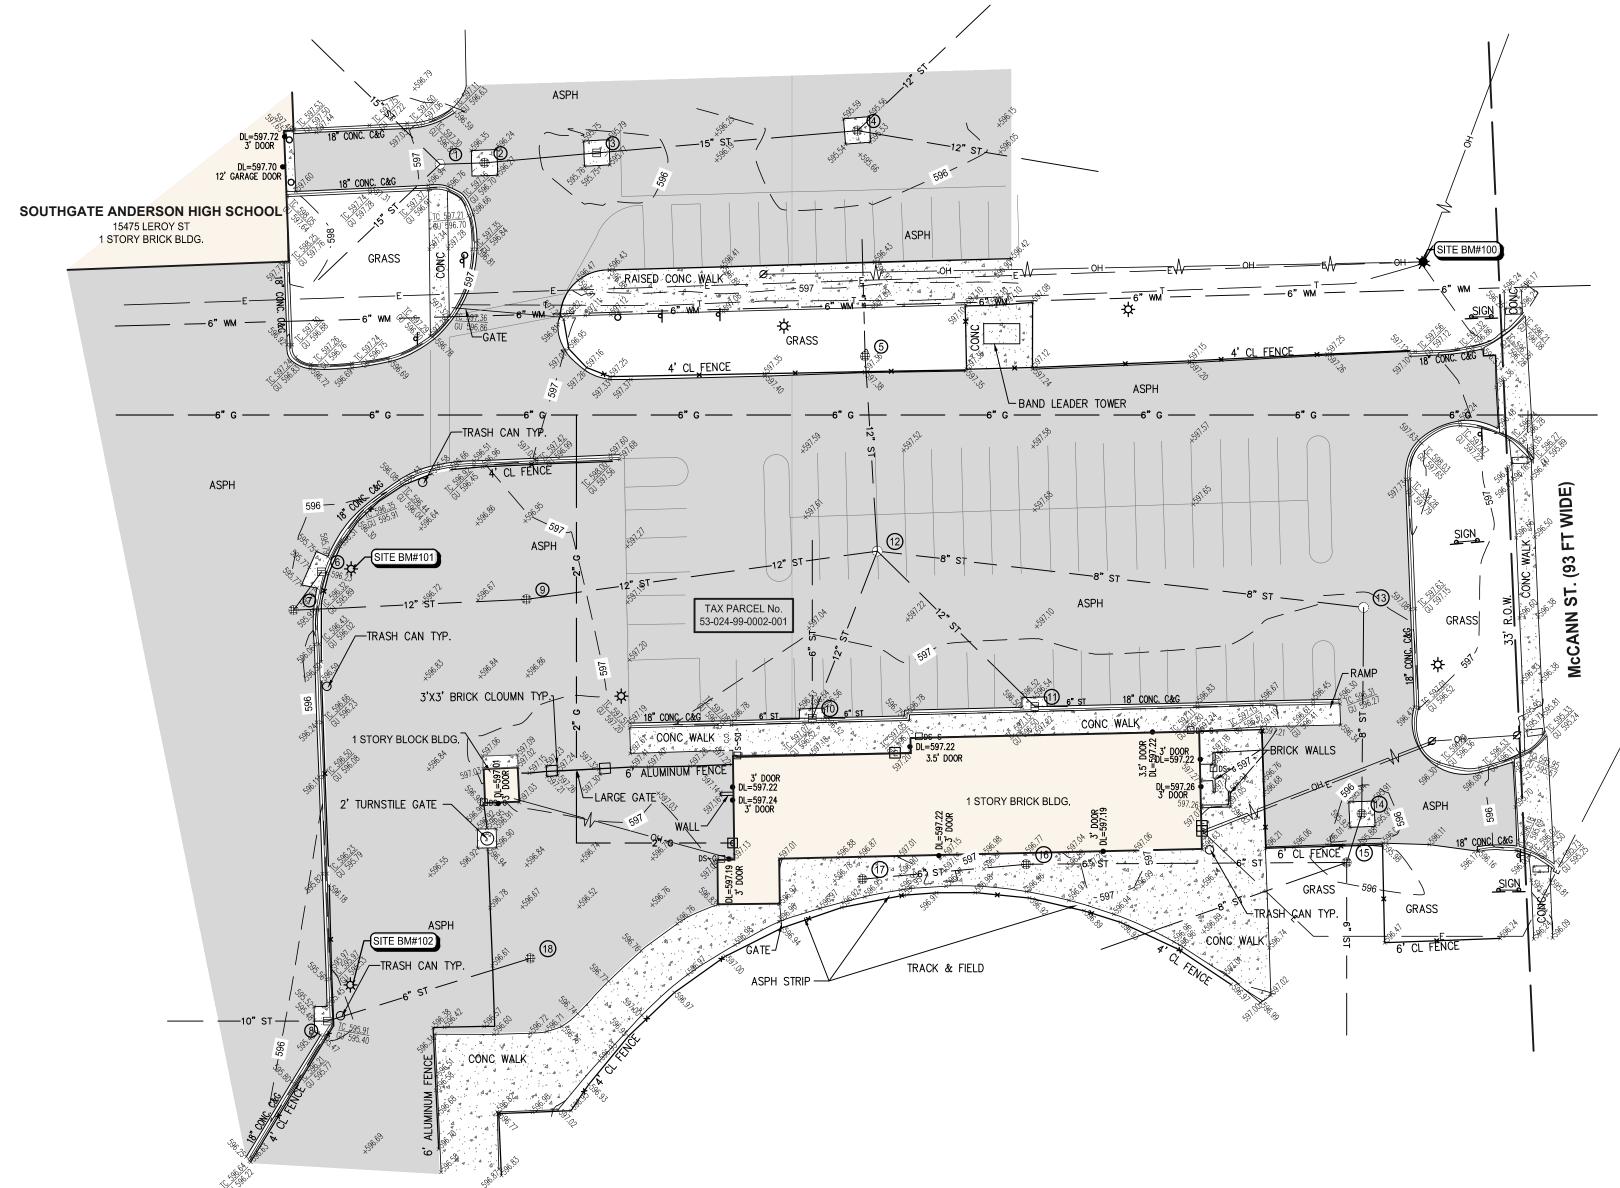

#### **SURVEYOR'S COMMENTS**

- THIS TOPOGRAPHICAL MAP IS BASED UPON A FIELD SURVEY PERFORMED BY SPALDING DEDECKER DURING DECEMBER OF 2023.
- THE PROPERTY LINES/RIGHT-OF-WAY LINES SHOWN ON THIS TOPOGRAPHICAL SURVEY ARE INTENDED TO BE AN APPROXIMATE GRAPHICAL REPRESENTATION OF THE PROPERTY LINES. SPALDING DEDECKER HAS BASED THE PROPERTY LINES AND RIGHT OF WAY LINES UPON A COMBINATION OF A PROVIDED LEGAL DESCRIPTION, FOUND FIELD MONUMENTATION AND OCCUPATION. PROPERTY LINES AS SHOWN IN DRAWING ARE BASED UPON THIS WORK. VARIATIONS MAY EXIST BETWEEN THE EXISTING PROPERTY DESCRIPTION AS SHOWN AND THE GRAPHICAL LINES COMPUTED IN THE DRAWING. A COMPLETE PROPERTY LINE ANALYSIS IS NOT PART OF THE SCOPE OF SERVICES AND PROPERTY CORNERS HAVE NOT BEEN SET IN THE FIELD PER THE AGREED TO SCOPE OF SERVICES.
- THIS SURVEY HAS BEEN PREPARED WITH THE BENEFIT OF A CURRENT INFORMATIONAL TITLE SEARCH WHICH INCLUDES THE LAST DEED OF RECORD AND A 100 YEAR SEARCH FOR ENCUMBRANCES. THE INFORMATIONAL TITLE SEARCH WAS PREPARED BY ASK SERVICES HAVING AN ORDER NUMBER OF 18127232 AND AN EFFECTIVE DATE OF 11-17-202X. ALL PLOTTABLE ENCUMBRANCES LISTED ON SCHEDULE B-II EXCEPTIONS OF THIS TITLE SEARCH HAVE BEEN SHOWN ON THIS SURVEY IF THEY FALL WITHIN THE
- LIMITS OF DETAILED MAPPING. . THE BASIS OF BEARINGS IS THE STATE PLANE GRID.
- THE COORDINATE SYSTEM FOR THIS SURVEY IS THE STATE PLANE COORDINATE SYSTEM, MICHIGAN SOUTH ZONE (2113), BASED ON NAD83 (NSRS2011). UNITS ARE INTERNATIONAL FEET. COORDINATES WERE ESTABLISHED USING A DATA LINK TO THE MDOT CONTINUOUSLY OPERATING REFERENCE
- THE VERTICAL DATUM OF THIS SURVEY IS BASED UPON THE NORTH AMERICAN VERTICAL DATUM OF 1988 (NAVD'88) AS ESTABLISHED WITH RTK GPS MEASUREMENTS USING A DATA LINK TO THE MDOT CONTINUOUSLY OPERATING REFERENCE STATIONS (CORS).
- THE PARKING LOT STRIPING SHOWN ON THIS SURVEY IS APPROXIMATE. DIMENSIONAL AND/OR ORIENTATION VARIATIONS MAY EXIST. THIS DRAWING SHOULD NOT BE USED FOR A PARKING SPACE
- THE UTILITY INFORMATION SHOWN ON THIS SURVEY IS BASED UPON A COMBINATION OF RECORD INFORMATION AND FIELD MEASUREMENTS. A MISS DIG DESIGN TICKET NUMBER OF 2023101902860 HAS BEEN REFERENCED TO THIS PROJECT AND A UTILITY PROVIDER CHART IS SHOWN ON THIS DRAWING. THERE ARE NO ASSURANCES THAT ALL PROVIDERS HAVE RESPONDED AND THE SURVEYOR DOES NOT GUARANTEE THAT ALL UNDERGROUND UTILITIES ARE SHOWN AND/OR POSITIONED PROPERLY ON THIS DRAWING DUE TO AMBIGUOUS PLANS AND RECORDS PROVIDED TO US. THE INFORMATION SHOWN ON THIS DRAWING IS INTENDED TO BE USED AS A GUIDE FOR POSSIBLE UNDERGROUND UTILITY CONFLICTS. IT IS THE RESPONSIBILITY OF OTHERS TO RESOLVE THE ACTUAL LOCATION OF ANY UNDERGROUND UTILITY THROUGH THE MISS DIG FIELD VERIFICATION SYSTEM PRIOR TO ANY SITE EXCAVATION. CALL 811 OR 800-482-7171.

#### BENCHMARK DESCRIPTIONS

DATUM: GPS-DERIVED NAVD'88

SET BENCH TIE IN WEST FACE OF U.P. LOCATED 55 FT WEST OF CENTERLINE OF McCANN AVE AND ±40FT NORTH OF CENTERLINE NORTH ENTRANCE TO ATHLETIC

ELEV =598.53

ELEV =597.85 SCRIBED "X" ON EAST SIDE OF LIGHT POLE BASE LOCATED ±60FT NORTH AND ±115FT WEST OF THE NORTH WEST CORNER OF FIELD HOUSE BUILDING.


ELEV =598.94 SCRIBED "X" ON EAST SIDE OF LIGHT POLE BASE LOCATED ±70FT SOUTH AND ±115FT WEST OF THE NORTH WEST CORNER OF FIELD HOUSE BUILDING

#### **LEGAL DESCRIPTION**

SOURCE: ASK SERVICES OWNER: SOUTHGATE CITY TAX PARCEL ID: 53-024-99-0002-001

35AA1A1 BB1A1 BB2A E 1/2 OF NW 1/4 OF SE 1/4 OF SEC 35 T3S R10E EXC N 43FT ALSO EXC SW TRIANGULAR PT MEAS 240.62FT ON W LINE AND 378.60FT ON S LINE OF PARCEL ALSO NE 1/4 OF SE 1/4 SEC 35 EXC N 43FT THEREOF ALSO PT OF SE 1/4 SEC 35 DESC AS BEG NODEG 01M 42S W 888.51FT FROM SE COR SEC 35 TH NODEG 01M 42S W 430FT TH N89DEG 24M 42S W 740FT TH S0DEG 01M 42S E 430FT TH S89DEG 24M 44S E 740FT TO POB

ADDRESS: 15475 LEROY & 16500 MCCANN, SOUTHGATE, MI 48195

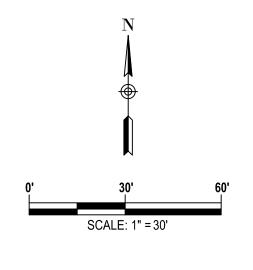







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PROJECT TITLE **Anderson High School** Field House

**Southgate Community Schools** Southgate, Michigan

DRAWING TITLE Topographical Survey

ISSUE	DATES

02-07-2024	CONSTRUCTION DOCUMENTS

ISSUED FOR: DATE:


APPROVED NB


PROJECT NO.

CHECKED NB

**TMP 20035E** SD NP23142

DRAWING NO.

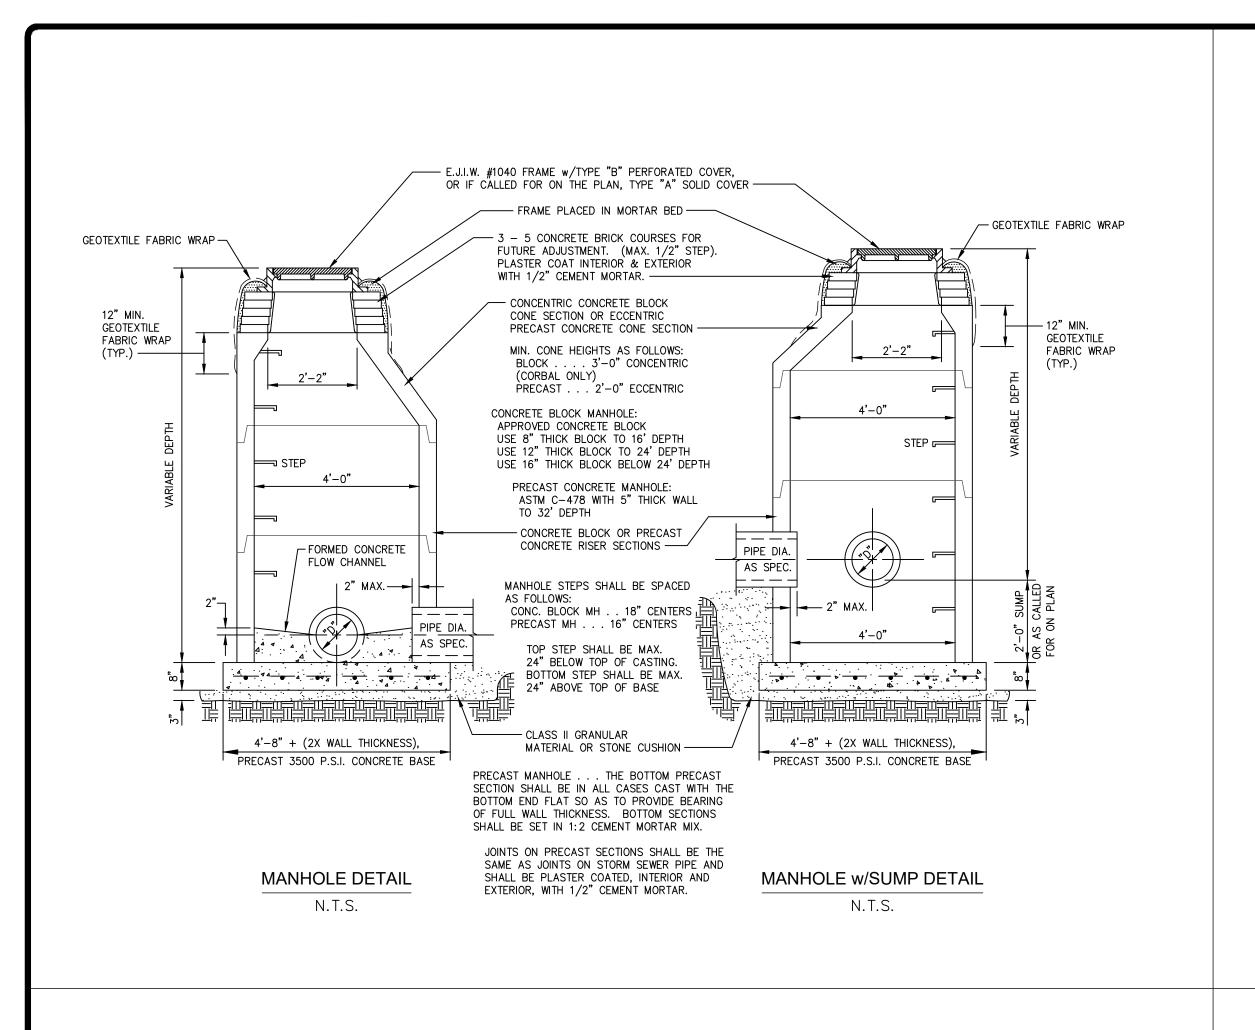

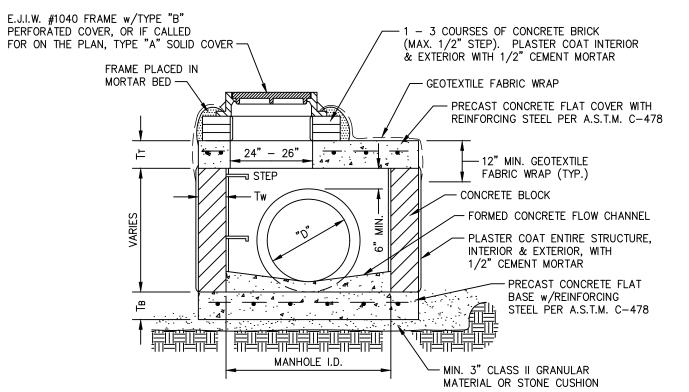

NOTE: PRECAST CONCRETE COMPONENTS PER A.S.T.M. C-478 MAY BE USED

MANHOLE STEPS SHALL BE SPACED AS FOLLOWS: CONCRETE BLOCK MANHOLE . . . . 18" CENTERS PRECAST MANHOLE . . . . 16" CENTERS

TOP STEP SHALL BE MAX. 24" BELOW TOP OF CASTING BOTTOM STEP SHALL BE MAX. 24" ABOVE TOP OF BASE


MANHOLE PLAN DIA.	MH I.D.	FLAT COVER DIAMETER	Тт	FLAT BASE DIAMETER	Тв	CONCRETE BLOCK Tw
4'-0"	±43"	60"	8"	72"	8"	8"
5'-0"	±59"	84"	8"	96"	12"	12"
6'-0"	±71"	96"	8"	96"	12"	12"
8'-0"	±95"	120"	12"	120"	12"	12"

MANHOLE TYPE "D"

N.T.S.

#### STORM SEWER NOTES

- 1. ALL STORM SEWER PIPE 12-INCHES AND LARGER SHALL BE REINFORCED CONCRETE, ASTM C-76, CL. IV OR CL.V PIPE WITH MODIFIED GROOVE TONGUE WITH RUBBER JOINTS, N-12 WT IB PIPE MEETING CURRENT ASTM F2648 AND AASHTO M294 STANDARDS FOR SIZES 12-INCH THROUGH 60-INCH, CONTECH D-2000 (12-INCH THROUGH 36-INCH) PIPE MEETING CURRENT ASTM F949 OR AASHTO M294 STANDARDS OR CONTECH DUROMAXX (24-INCH THROUGH 120-INCH) PIPE.
- ALL CONSTRUCTION SHALL CONFORM TO CURRENT CITY OF SOUTHGATE DETAILED SPECIFICATIONS FOR STORM SEWER UTILITIES.
- 3. A 4" COMPACTED SAND BEDDING SHALL BE PROVIDED UNDER ALL SEWER PIPE.
- 4. ALL TRENCH DETAILS FOR BOTH TRENCH A AND TRENCH B SHALL BE BASED ON THE MANUFACTURER'S RECOMMENDATIONS FOR THE GIVEN TYPE OF PIPE.
- 5. ALL ROAD CATCH BASINS AND INLETS SHALL HAVE UNDERDRAINS, A MINIMUM OF 5 FEET LONG WITH END PLUG OR CAP, PLACED INTO THE SEWER TRENCH AND WRAPPED WITH SOIL FILTRATION FABRIC. THE UNDERDRAIN SHALL BE EITHER CORRUGATED OR SMOOTH WALL PLASTIC TUBING OF POLYETHYLENE OR POLYVINYLCHLORIDE AND SHALL CONFORM TO THE REQUIREMENTS FOR HEAVY—DUTY TUBING OF ASTM F 405, EXCEPT THAT THE BASIC MATERIALS FOR USE IN FABRICATING PVC TUBING SHALL BE A PVC PLASTIC MEETING THE REQUIREMENTS AS SPECIFIED IN ASTM D 3033. THE PERFORATIONS SHALL BE IN THE LOWER SEGMENT ONLY AND SHALL BE CLEARLY MARKED WITH A TOP LOCATING STRIPE OR EMBOSSMENT.
- 6. ALL DRAINAGE STRUCTURES SHALL HAVE A GEOTEXTILE FABRIC WRAPPED AROUND THE BRICK AND MORTAR WORK. THE FABRIC SHALL BE A NON-WOVEN GEOTEXTILE MEETING THE MINIMUM ASTM REQUIREMENTS FOR GEOTEXTILE BLANKET AS ESTABLISHED BY MDOT, SECTION 910.
- 7. STROM MANHOLES AND CATCH BASINS SHALL BE PRECAST STRUCTURES. FRAMES AND CASTINGS FOR MANHOLES AND CATCH BASINS SHALL BE AS MANUFACTURED BY EJ (FORMERLY EAST JORDAN IRON WORKS). ALL STORM SEWER STRUCTURES SHALL BE PRECAST STRUCTURES WITH RUBBER GASKETED JOINTS FOR THE MANHOLE SECTIONS. EACH MANHOLE AND CATCH BASIN SECTION AND JOINT SHALL BE SEALED EXTERNALLY USING A "CRETEX WRAP" EXTERNAL JOINT SEALER OR APPROVED EQUAL.

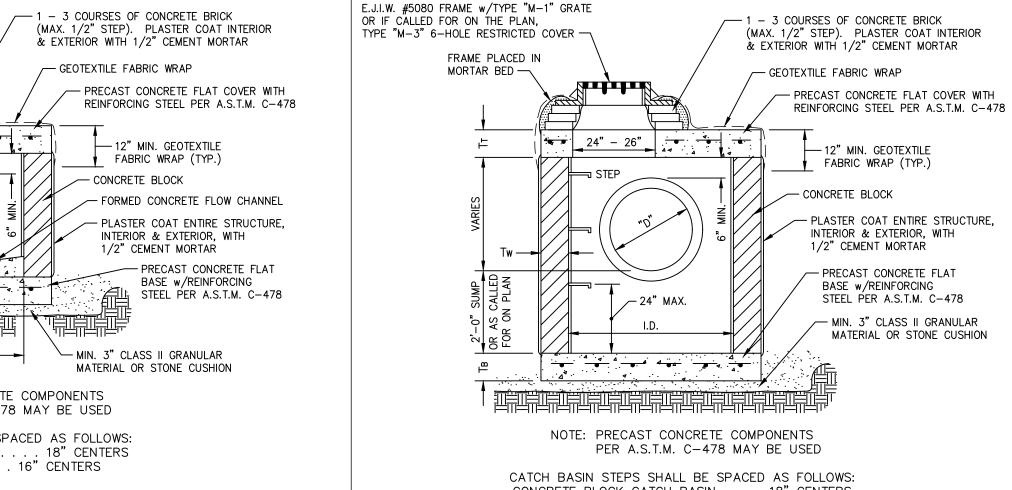

CATCH BASIN STEPS SHALL BE SPACED AS FOLLOWS: CONCRETE BLOCK CATCH BASIN . . . . 18" CENTERS PRECAST CATCH BASIN . . . . 16" CENTERS

TOP STEP SHALL BE MAX. 24" BELOW TOP OF CASTING

CATCH BASIN PLAN DIA.	I.D.	FLAT COVER DIAMETER	Тт	FLAT BASE DIAMETER	Тв	CONCRETE BLOCK Tw
4'-0"	±43"	60"	8"	72"	8"	8"
5'-0"	±59"	84"	8"	96"	12"	12"
6'-0"	±71"	96"	8"	96"	12"	12"

CATCH BASIN TYPE "D"

N.T.S.

- E.J.I.W. #5080 FRAME w/TYPE "M-1" GRATE OR IF CALLED FOR ON THE PLAN. GEOTEXTILE FABRIC WRAP-TYPE "M-3" 6-HOLE RESTRICTED COVER 5' MIN. OR AS SPECIFIED - FRAME PLACED IN ON THE PLAN MORTAR BED GEOTEXTILE 6" DIA. PERFORATED FABRIC WRAP 3 – 5 CONCRETE BRICK COURSES FOR UNDERDRAIN PIPE -FUTURE ADJUSTMENT. (MAX. 1/2" STEP) PLASTER COAT INTERIOR & EXTERIOR WITH 1/2" CEMENT MORTAR. ← STEP RECOMMENDED — PLASTER COAT JOINT, INTERIOR & MANUFACTURERS PLUG -EXTERIOR, WITH 1/2" CEMENT MORTAR - CONCRETE & RUBBER O-RING JOINT CATCH BASIN OR INLET STRUCTURE — PIPE DIA. AS SPECIFIED. <del>- - - - - -</del> 2'-0" SUMP -FOR 5'-0" DIA. OR GREATER CATCH BASIN, SEE MANHOLE WITH SUMP ALL CATCH BASINS AND INLETS SHALL HAVE AN UNDERDRAIN DETAIL FOR CONSTRUCTION FROM

BASE TO TRANSITION SLAB.


- CLASS II GRANULAR MATERIAL

OR STONE CUSHION


PRE-CAST CATCH BASIN DETAIL N.T.S.

4 4 4

DIA.+8" + (2X WALL THICKNESS)

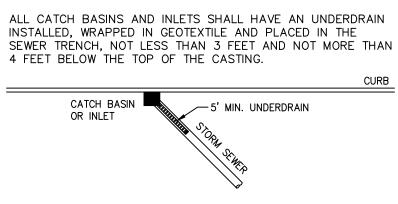

CATCH BASIN OR INLET UNDERDRAIN DETAIL

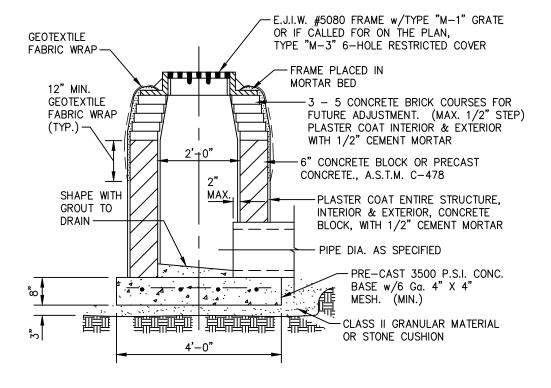

N.T.S.

- CLASS II GRANULAR MATERIAL BACKFILL SHALL BE USED WHEN SEWER IS UNDER OR WITHIN 3 FEET OF EXISTING OR PROPOSED PAVEMENT - SUITABLE EXCAVATED MATERIAL 30" MAX. FOR 6" THRU COMPACTED TO DENSITY 12" DIA. PIPE EQUIVALENT TO ADJACENT SOIL O.D. + 16" MAX. FOR 15" THRU 36" DIA. PIPE O.D. + 20" MAX. FOR 42" THRU 60" DIA. PIPE GRANULAR MATERIAL, CLASS II, COMPACTED 95% MAX. UNIT WEIGHT 6" MIN. (TYP.) (ASTM D-1557 MODIFIED PROCTOR) --4" MIN. CLASS II GRANULAR MATERIAL CUSHION

SEWER TRENCH DETAIL

N.T.S.

ENGINEERING THE FUTUR SOUTHGATE, MI 48195 (734) 759-1600

12-1-08

DESIGNED BY:

DRAWN BY:

CHECKED BY:

*APPROVED BY:* 

**REVISIONS** 

4-17-12


Standard Notes


Updated



STORM SEWER DETAILS
STANDARD DETAILS
CITY OF SOUTHGATE
WAYNE COUNTY, MICHIGAN

SHEET

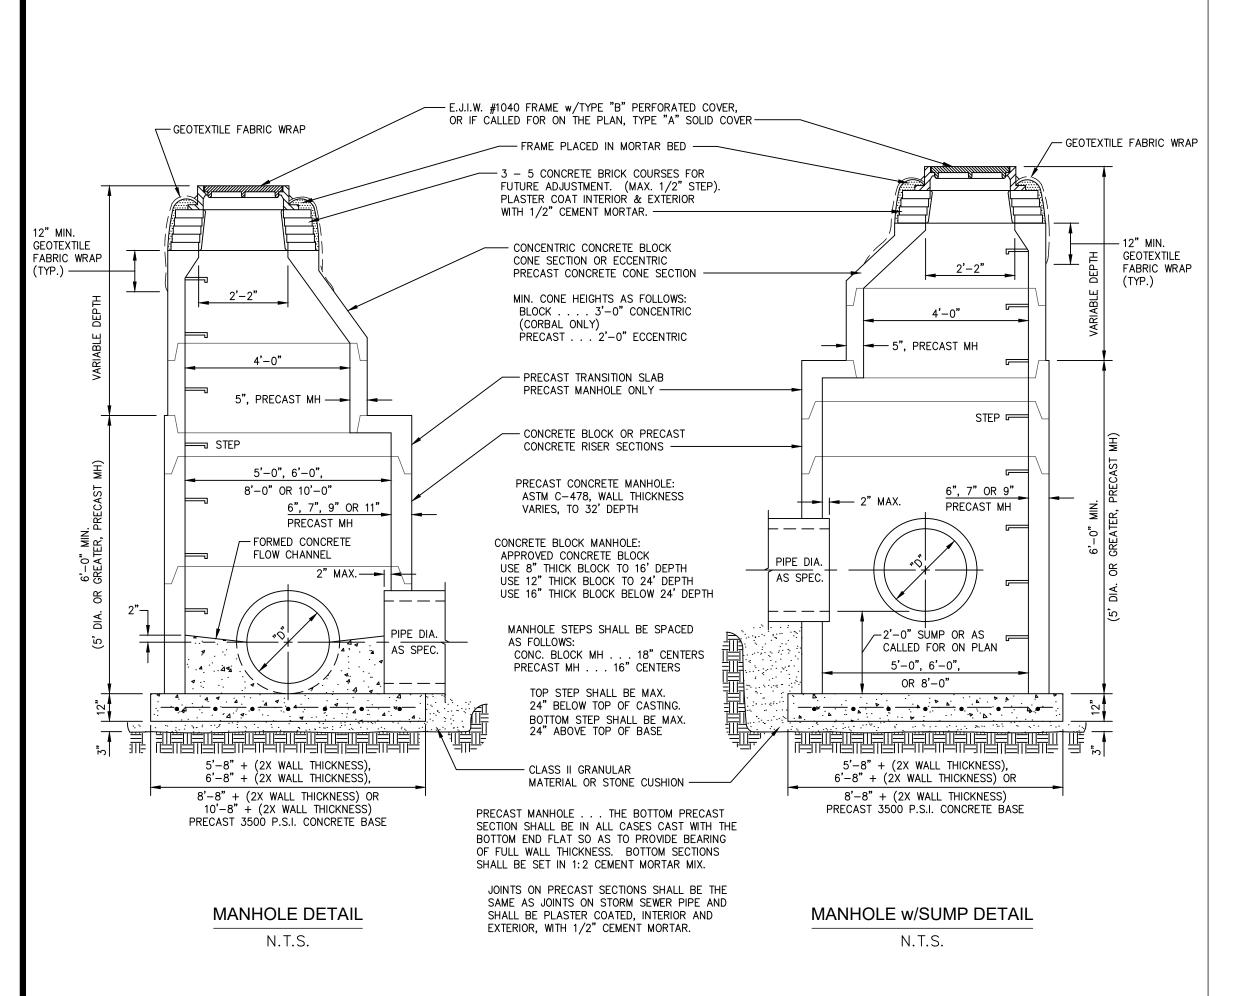

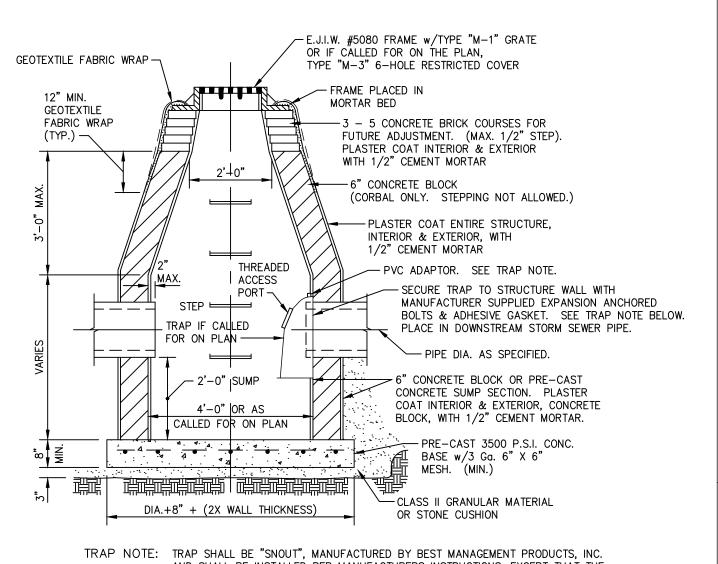

TRAP SHALL BE "SNOUT", MANUFACTURED BY BEST MANAGEMENT PRODUCTS, INC. AND SHALL BE INSTALLED PER MANUFACTURERS INSTRUCTIONS, EXCEPT THAT THE 1 INCH PVC ANTI-SIPHON PIPE SHALL BE CUT TO A REASONABLE HEIGHT ABOVE THE ADAPTOR AND CAPPED. CONTRACTOR SHALL APPLY A SILICONE BASED LUBRICANT TO THE THREADS OF THE ACCESS PORT COVER. TRAP SHALL BE INSTALLED WHERE CALLED FOR ON PLAN.

STEP NOTE: STEPS SHALL BE SPACED AT 18" CENTERS FOR CONCRETE BLOCK CATCH BASIN. TOP STEP SHALL BE MAX. 24" BELOW TOP OF CASTING. BOTTOM STEP SHALL BE MAX. 24" ABOVE TOP OF BASE.

C.B. NOTE: FOR 5'-0" DIA. OR GREATER CATCH BASINS, SEE CATCH BASIN TYPE "D" DETAIL FOR CONSTRUCTION.

CATCH BASIN DETAIL

N.T.S.