



Van Buren Public Schools

RAHS Belleville High School

501 W Columbia Ave Belleville, MI 48111

List of Drawings

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MECHANICAL

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M1.1 First Floor Demolition Plan

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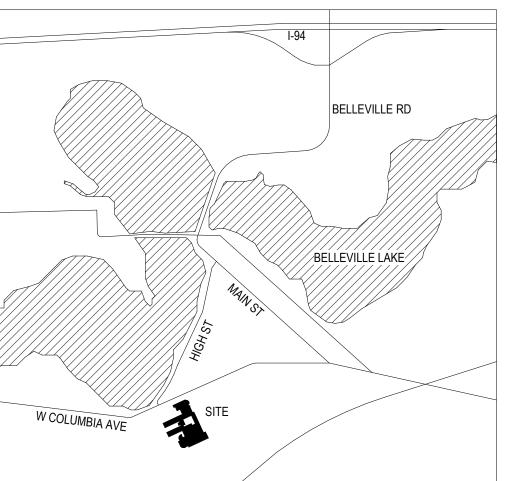
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Code Information





Registration Seal

Signature
Signature
Signature
Date
Date

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24167-1000

Issued for

Design Development 07-03-2024


Issue Date

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248.823.2100

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Project Administrator A. Maurer


THIS PROJECT MAY NOT UTILIZE ALL THE SYMBOLS, MATERIALS, ABBREVIATIONS AND STANDARD INFORMATION SHOWN ON THIS SHEET

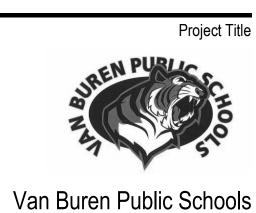Project Designer
A. Pelfrey
Project Architect / Engineer
C. King
Drawn By
C. King
Q.M. Review
<u>-</u>
Approved
-
Drawing Scale
No Scale
Issued for Issue Date
Design Development 07-03-2024

 \circ 2024 Integrated $ext{design}$ solutions, L

Architectural Reference Information

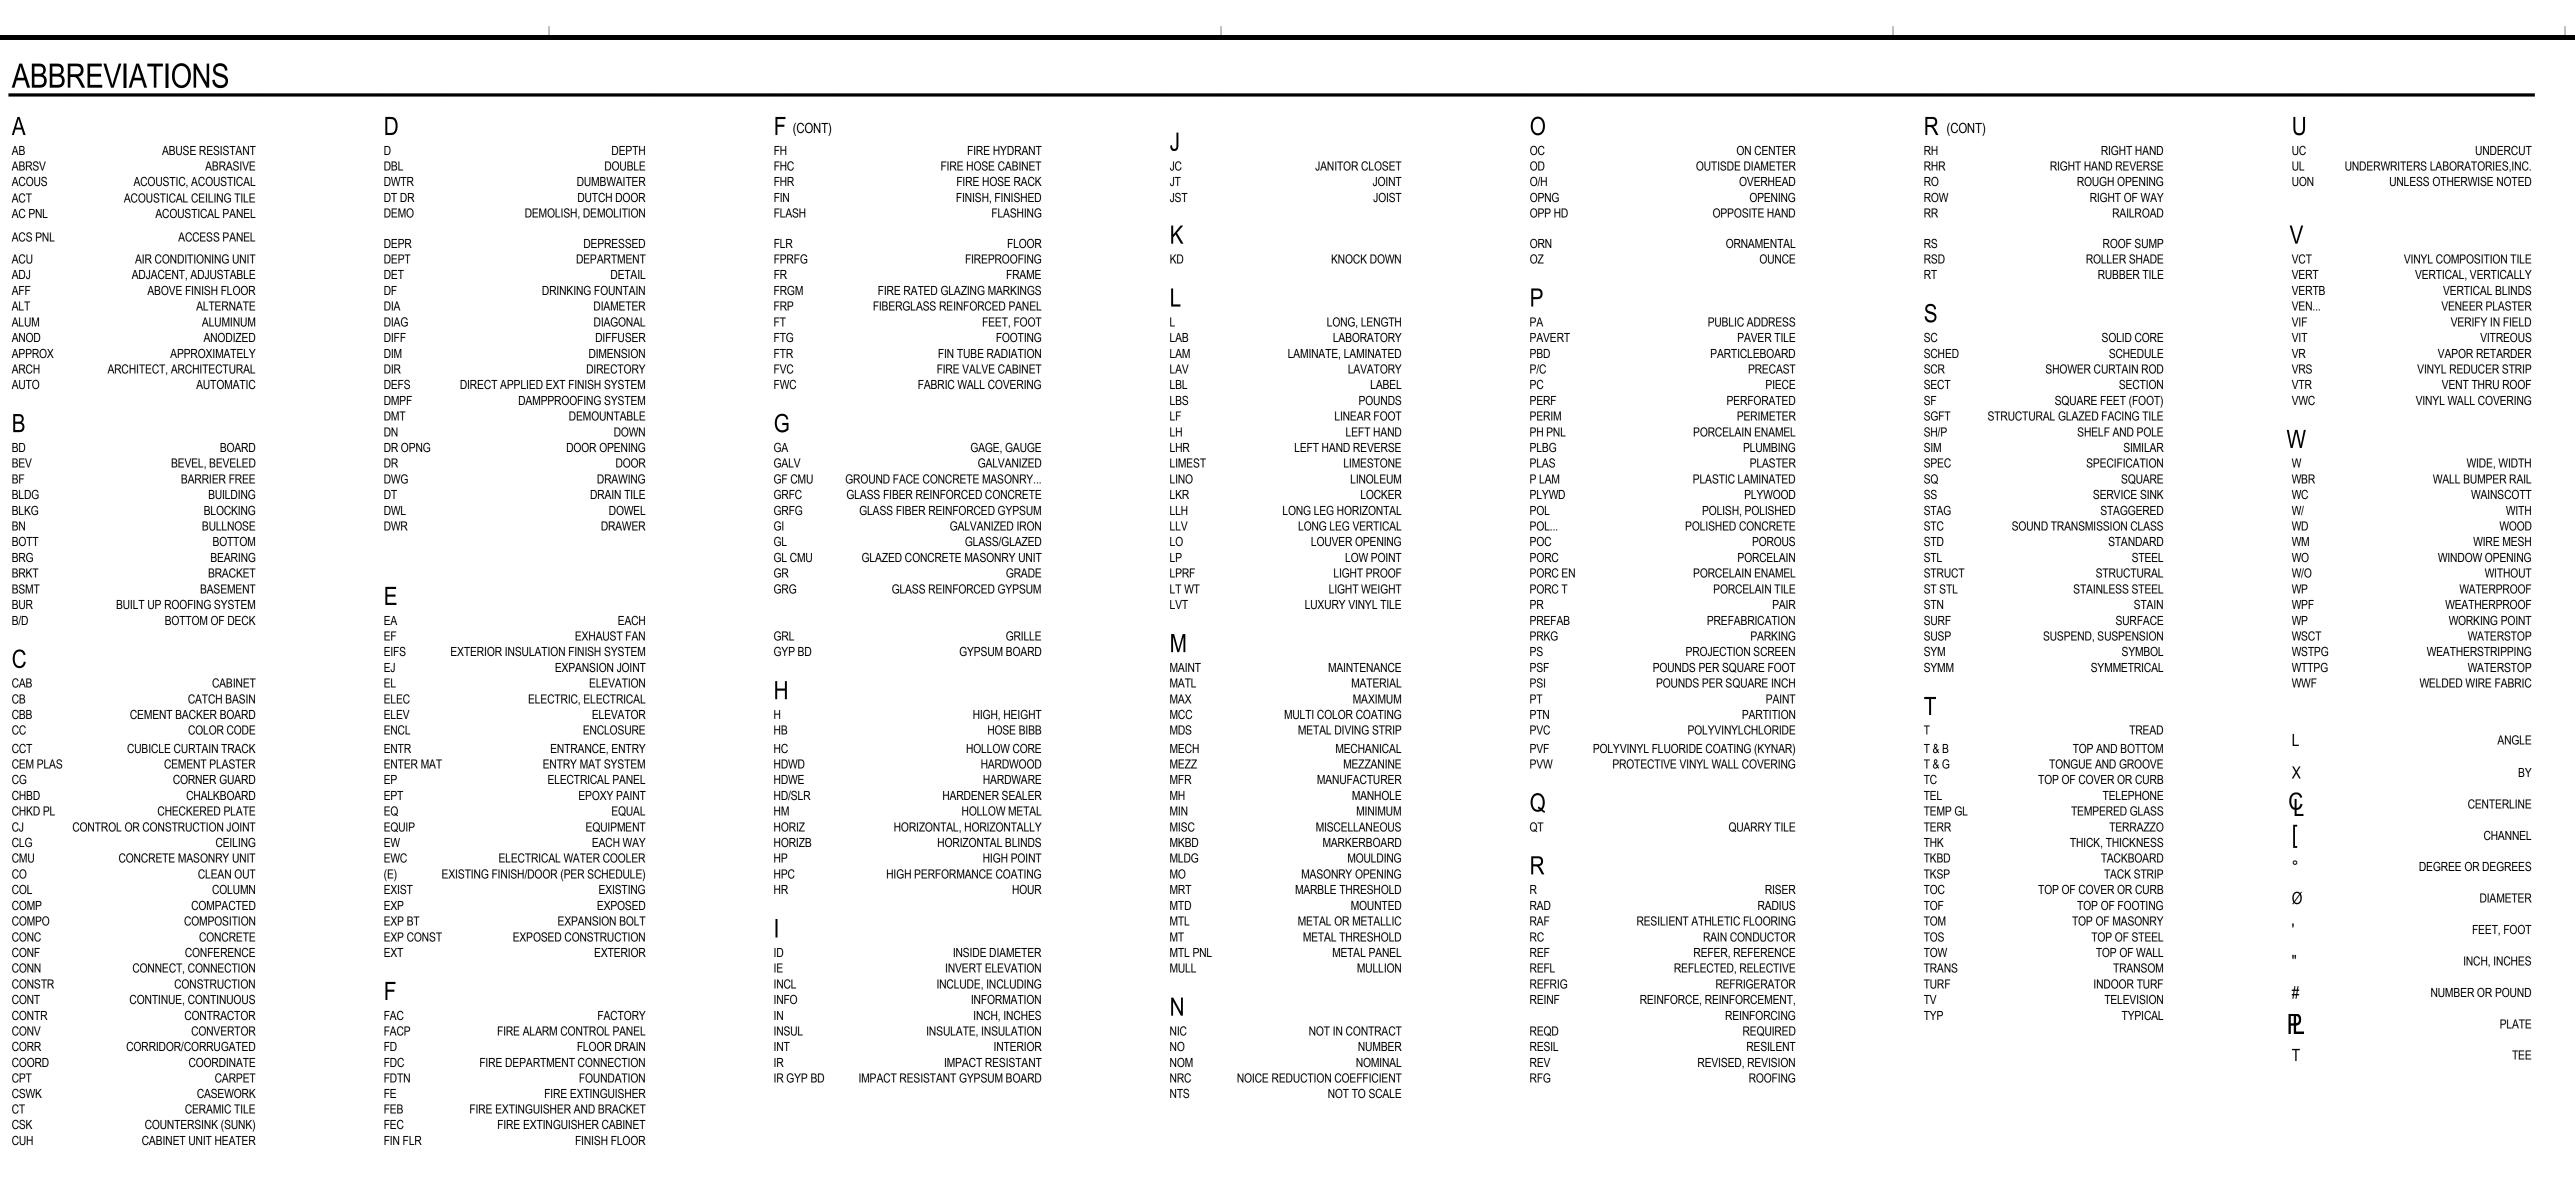24167-1000



MATERIAL LEGEND PREMOLDED EXPANSION JOINT OR COMPRESSIBLE FILLER STRIP SOIL STRUCTURAL GLAZED BATT INSULATION **FACING TILE** GRANULAR FILL GLASS OR PLASTIC · STONE STONE RIGID INSULATION GLAZING GRAVEL MARBLE PLASTER OR GYPSUM BOARD CONCRETE METALS CERAMIC OR QUARRY TILE TERRAZZO CONCRETE MASONRY UNIT FINISH WOOD ACOUSTICAL PANEL OR PLYWOOD ACOUSTICAL TILE GLAZED CMU

MOUNTING HEIGHTS

SYMBOL LEGEND SECTION OR DETAIL TITLE - SECTION OR DETAIL IDENTIFICATION SECTION OR DETAIL SHEET WHERE DETAIL IS REFERENCED OR CUT SECTION OR DETAIL IDENTIFICATION A9.1 SHEET WHERE SECTION OR DETAIL INTERIOR ELEVATION SYMBOL

EXTERIOR WALL SECTION LOCATOR LARGE SCALE PLAN OR DETAIL - ELEVATION IDENTIFICATION SHEET WHERE ELEVATION EXTERIOR ELEVATION SYMBOL - ELEVATION IDENTIFICATION **EXISTING** SHEET WHERE ELEVATION

SHEET WHERE PLAN OR DETAIL IS DRAWN COLUMN DESIGNATION/CENTERLINE (1) -----

BUILDING SECTION LOCATOR

BUILDING SECTION IDENTIFICATION

WALL SECTION IDENTIFICATION

SHEET WHERE WALL SECTION IS DRAWN

SHEET WHERE BUILDING SECTION IS DRAWN

PLAN OR DETAIL

BF ROLL-IN SHOWER WITH BENCH BACK WALL / CONTROL WALL

AMBULATORY STALL

BACK WALL

--6" MAX

BF TRANSFER SHOWER SIDE WALL / CONTROL WALL

MATERIAL KEYNOTE

ROOM NAME AND NUMBER

DOOR NUMBER

EXISTING DOOR

PROJECT MANUAL SECTION

— BUILDING OR UNIT (IF ANY)

(REFER TO FLOOR PLAN)

BUILDING OR UNIT (IF ANY)

MOUNTING HEIGHTS SHOWN ARE BASED UPON RECOGNIZED DESIGN STANDARDS AND/OR BARRIER FREE CODE REQUIREMENTS. IT IS INTENDED THAT LIKE DEVICES ALL BE MOUNTED AT THE SAME HEIGHT THROUGHOUT THE ENTIRE PROJECT, RECESSED DEVICES IN MASONRY WALLS MAY DICTATE A DEVIATION (± 2") FROM THESE HEIGHTS (WHEN PERMITTED BY CODE) SO AS TO ALLOW THE BOTTOM OR THE TOP OF THE DEVICE RECESS TO ALIGN WITH MASONRY COURSING. COORDINATE THESE DEVIATIONS WITH THE

ARCHITECT'S/OWNER'S REPRESENTATIVE.

NOTED ON DRAWINGS.

MOUNTING HEIGHTS ARE TYPICAL UNLESS OTHERWISE


NEW DOOR

PARTITION TYPE IDENTIFICATION

IDENTIFICATION

ī**D**§ Project Number

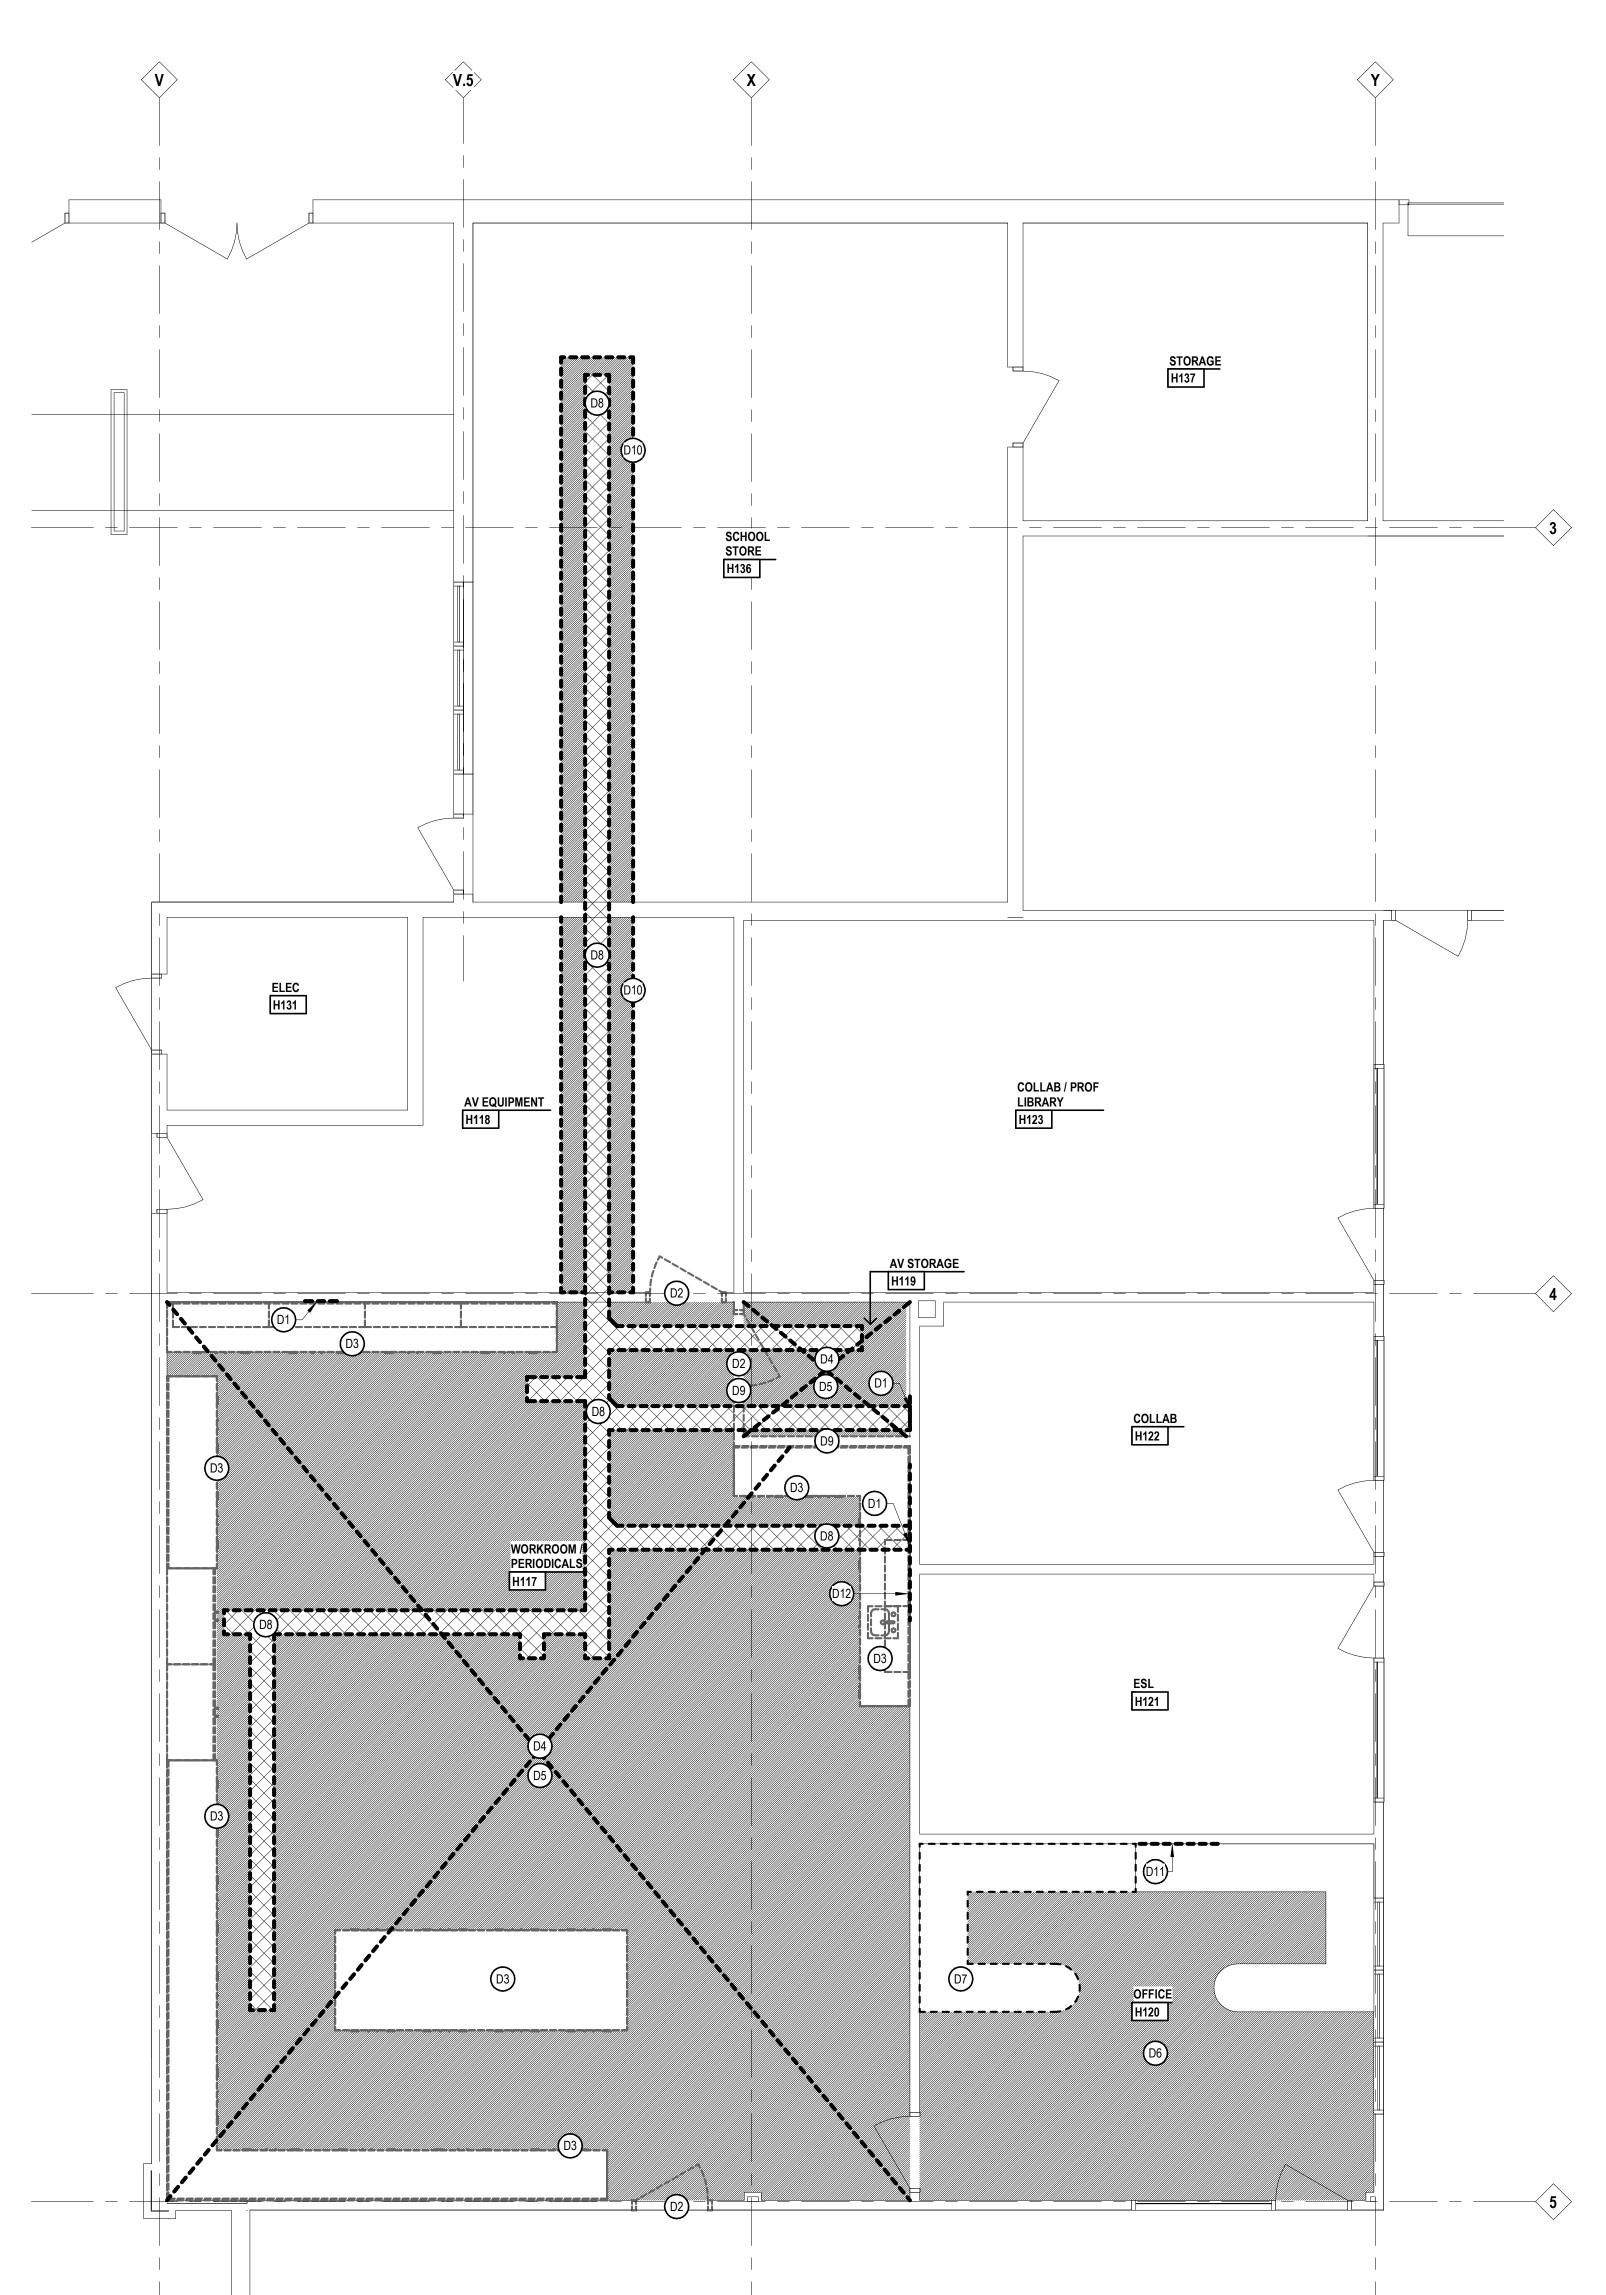AR.0



DEMOLITION PLAN

- A. ALL DEMOLITION WORK REQUIRED IS NOT NECESSARILY LIMITED TO WHAT IS SHOWN ON THE DEMOLITION PLAN. THE INTENT IS TO REMOVE ALL MECHANICAL, ELECTRICAL, AND ARCHITECTURAL ITEMS AS REQUIRED TO FACILITATE NEW CONSTRUCTION.
- B. CONTRACTOR SHALL PROVIDE TEMPORARY DUSTPROOF PARTITIONS WITH DOORS AT LOCATIONS INDICATED AND/OR AS REQUIRED TO ADEQUATELY SEPARATE OCCUPIED AREAS FROM CONSTRUCTION HAZARDS, NOISE AND/OR DUST. REFER TO SPECIFICATIONS FOR

ADDITIONAL INFORMATION. COORDINATE ALL LOCATIONS WITH

C. CONTRACTOR SHALL PROVIDE DUST MATS AT ALL CONSTRUCTION AREA ENTRANCES AND EXIT LOCATIONS. COORDINATE ALL LOCATION'S WITH ARCHITECT'S/OWNER'S REPRESENTATIVES.

ARCHITECT'S/OWNER'S REPRESENTATIVE.

- D. CONTRACTOR SHALL CONTINUOUSLY MAINTAIN ALL MEANS OF EGRESS AND ALL FIRE PROTECTION FEATURES FOR PORTIONS OF THE BUILDING THAT REMAIN OCCUPIED DURING CONSTRUCTION.
- E. COORDINATE SCOPE AND EXTENT OF DEMOLITION WITH NEW WORK PLANS AND DETAILS.
- F. REFER TO MECHANICAL AND ELECTRICAL DEMOLITION SHEETS FOR ADDITIONAL INFORMATION.

LEGEND

DEMOLITION PLAN NOTE: NOT ALL SYMBOLS MAY BE USED

EXISTING TO BE REMOVED

EXISTING TO REMAIN

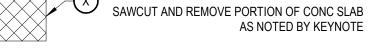
AS NOTED BY KEYNOTE

EXISTING CEILING TO BE REMOVED AS NOTED BY KEYNOTE

EXISTING FLOOR/FINISH TO BE REMOVED



SAWCUT AND REMOVE PORTION OF CON



KEYNOTES

DEMOLITION PLAN SHADED ITEMS HAVE BEEN REVISED FROM PREVIOUS NOTE: NOT ALL KEYNOTES MAY BE USED

LEGEND SYMBOL INDICATOR

- D1 REMOVE PORTION OF GYPSUM BOARD. COORDINATE WITH NEW WORK PLANS.
- D2 REMOVE DOOR, FRAME, AND SILL IN ITS ENTIRETY
- D3 REMOVE BASE CABINETS, COUNTERTOP, BACKSPLASH AND/OR WALL MOUNTED CABINETS IN THEIR ENTIRETY
- D4 REMOVE ACOUSTIC CEILING TILES, GRID, AND SUSPENSION SYSTEM IN ITS ENTIRETY
- D5 REMOVE VCT / LINOLEUM FLOORING, BASE, AND ADHESIVE DOWN TO STRUCTURAL SLAB
- D6 REMOVE CARPET, WALL BASE, AND ADHESIVE DOWN TO STRUCTURAL
- D7 REMOVE FURNITURE AND RETURN TO OWNER
- D8 SAW CUT AND REMOVE PORTION OF CONCRETE FLOOR SLAB. COORDINATE WITH NEW WORK PLANS.
- D9 REMOVE GYPSUM BOARD / METAL STUD PARTITION. COORDINATE WITH NEW WORK PLANS.
- D10 REMOVE CARPET AS REQUIRED FOR FLOOR TRENCHING SALVAGE,
- PROTECT AND STORE CARPET FOR REINSTALLATION

 1. DEMOVE MARKEDBOARD / TACKBOARD / WHITEBOARD IN ITS
- D11 REMOVE MARKERBOARD / TACKBOARD / WHITEBOARD IN ITS ENTIRETY. RETURN TO OWNER.

D12 REMOVE AND SALVAGE WALL MOUNTED PAPER TOWEL DISPENSER

AND SOAP DISPENSER AND RETURN TO OWNER.

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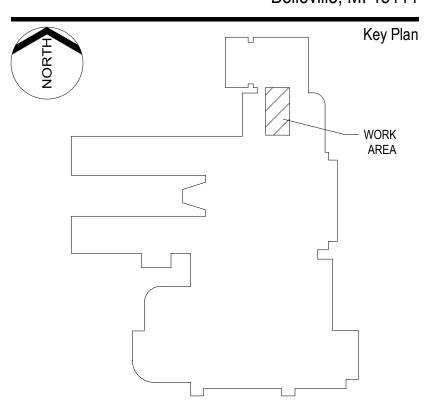
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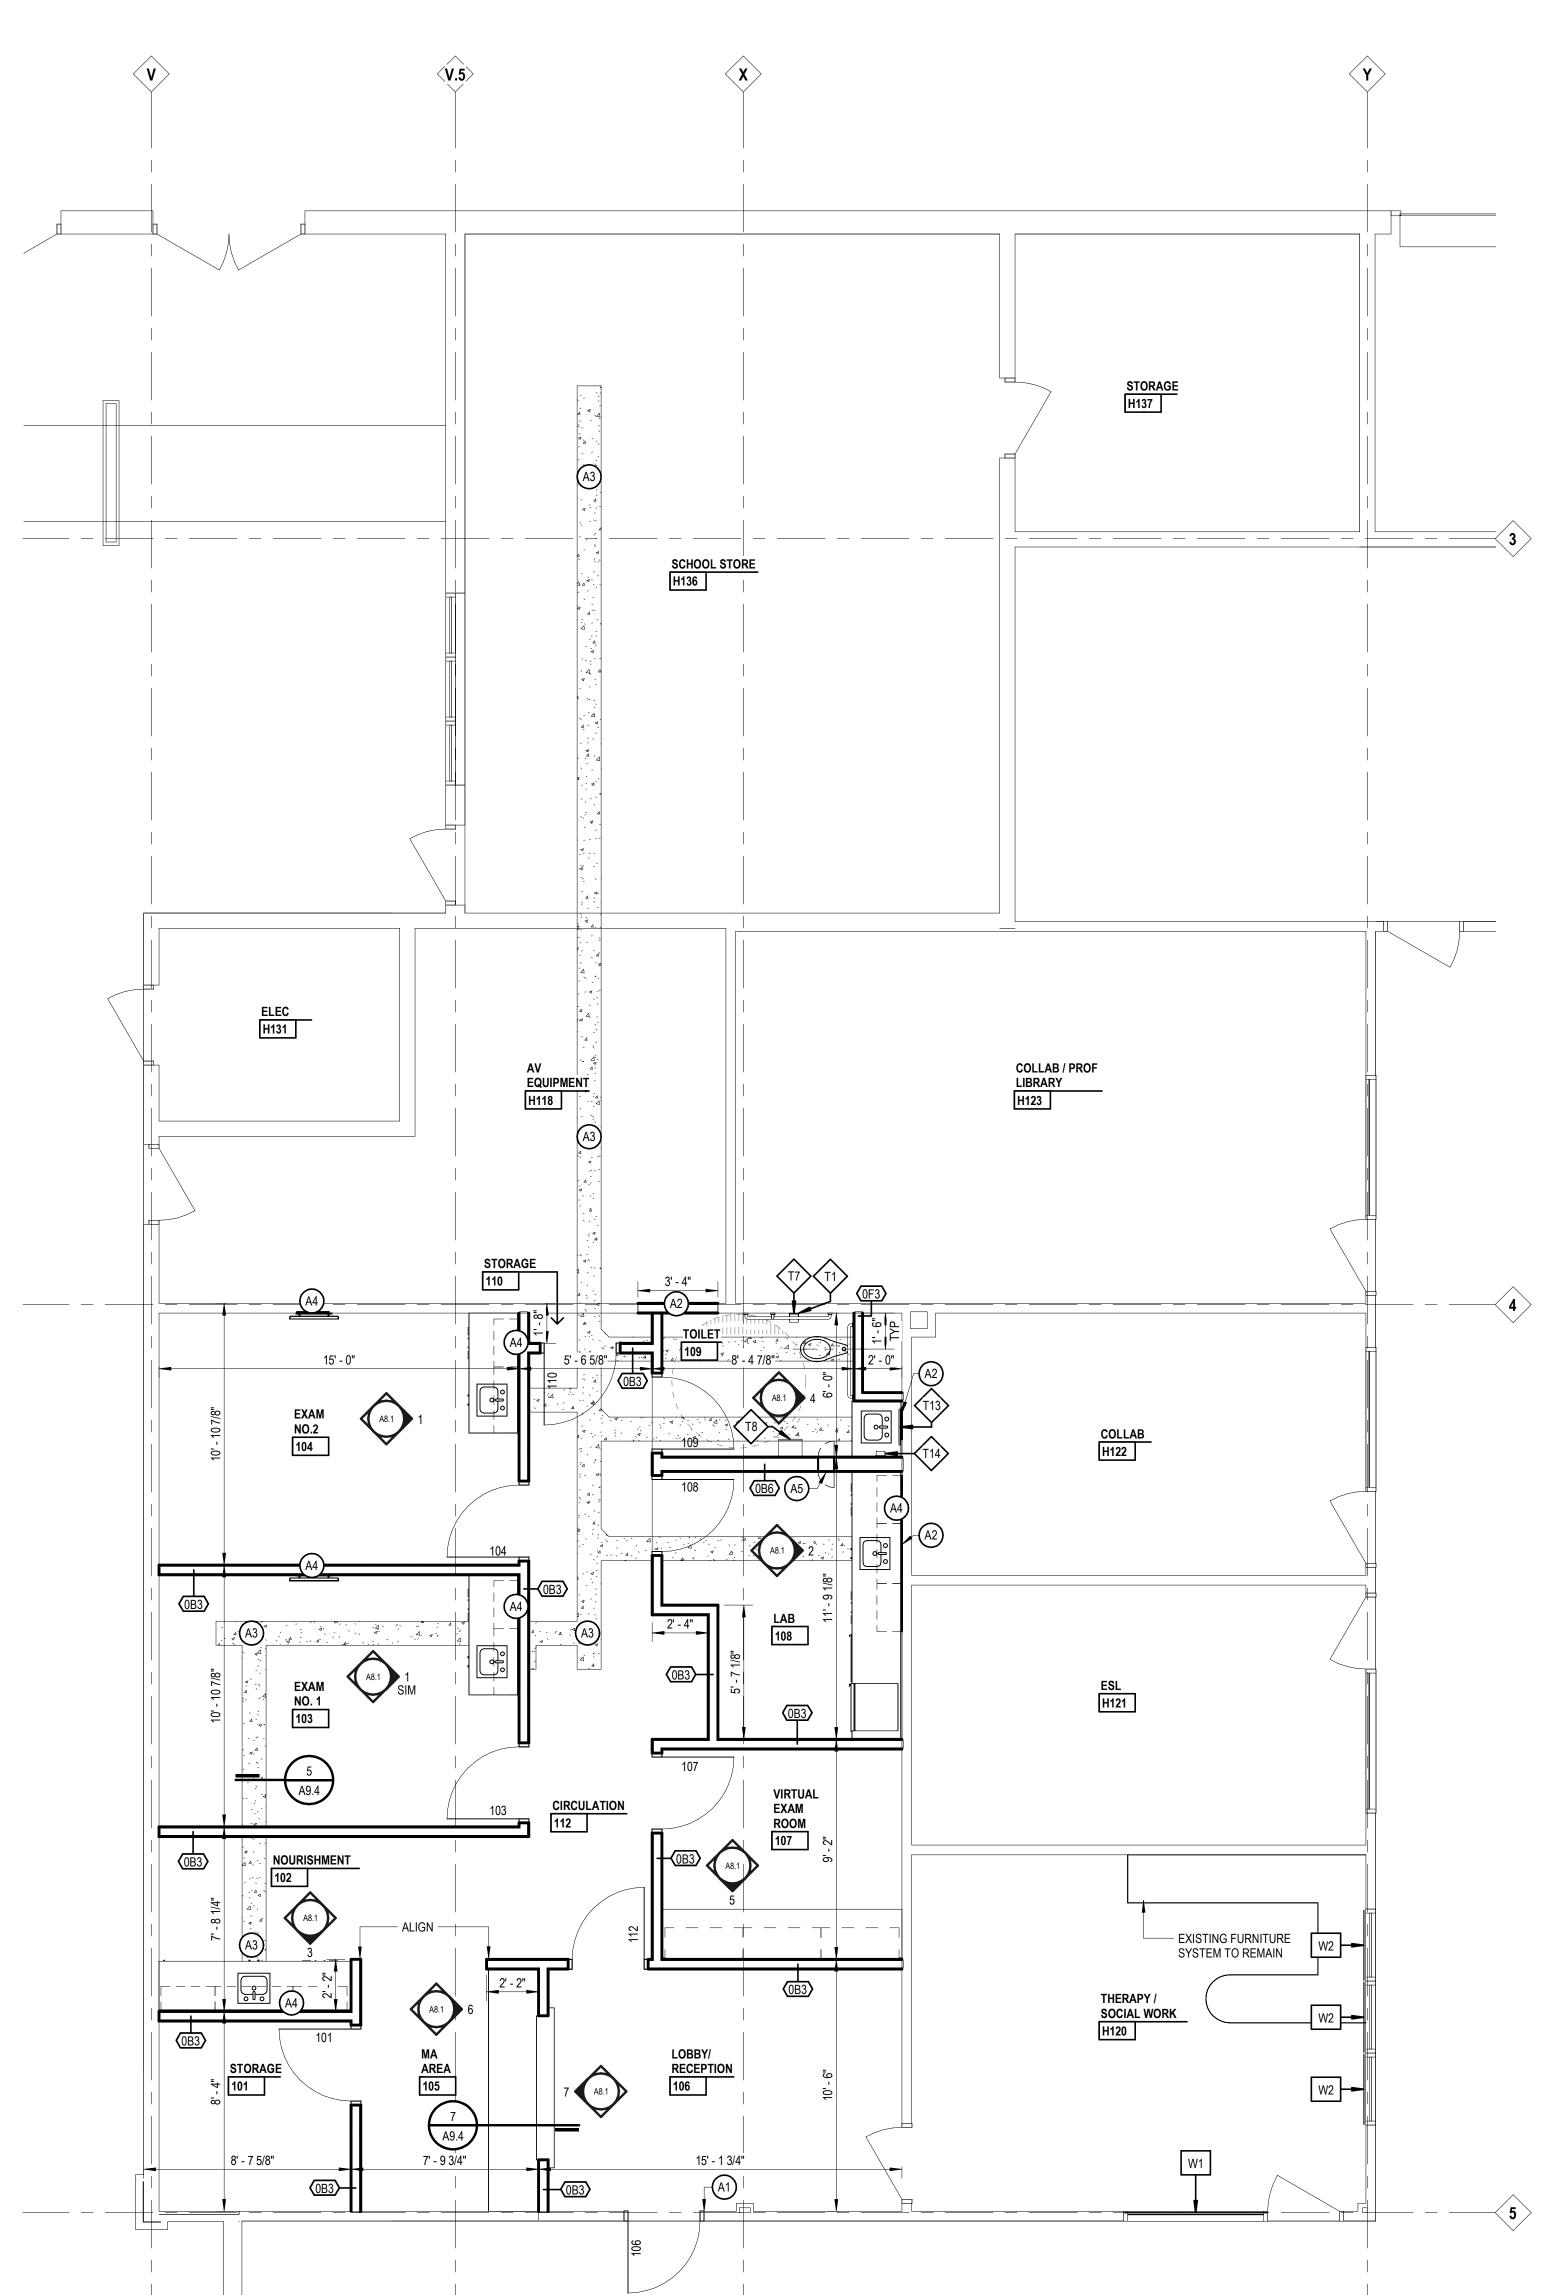


	Project Design
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Project A	rchitect / Engine C. Kin
	C. KIII
	Drawn E
	A. Pelfre
	Q.M. Revie
	A
	Approve
	Drawing Sca
	1/4" = 1' - (
Issued for	Issue Dat
Design Development	07-03-202

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First Floor Demolition Plan

ī**D**§ Project Number



- **NEW WORK PLAN**
- A. REFER TO SHEET A9.2 FOR DOOR SCHEDULE AND COLORS.
- B. REFER TO SHEET A9.1 FOR FINISH SCHEDULE AND COLORS. C. REFER TO LIFE SAFETY PLANS FOR PARTITION RATINGS.
- D. PARTIAL WALL POCHEING IS SHOWN THROUGHOUT THIS PLAN AND THE TERMINATION OF SAME SHALL NOT BE CONSTRUED TO REPRESENT A CHANGE IN WALL MATERIAL. VERIFY WALL MATERIALS WITH PARTITION TYPES AND SCHEDULES.
- E. PATCH AND/OR REPAIR ALL EXISTING FLOOR, WALL AND OR CEILING FINISHES AS REQUIRED TO MATCH EXISTING OR TO ACCEPT NEW FINISHES AS SCHEDULED AT ALL AREAS AFFECTED BY THE DEMOLITION WORK. REFER TO MECHANICAL AND ELECTRICAL SHEETS FOR ADDITIONAL SCOPE OF WORK.
- F. INFILL ALL OPENINGS IN EXISTING WALLS ABOVE CEILINGS THAT ARE THE RESULT OF MECHANICAL OR ELECTRICAL DEMOLITION. OPENINGS IN MASONRY WALLS SHALL BE FILLED WITH MASONRY OF SIMILAR TYPES AND THICKNESS AS EXISTING. OPENINGS IN OTHER TYPES OF WALL CONSTRUCTION SHALL MATCH EXISTING MATERIALS, FINISHES AND WALL THICKNESS. REFER TO MECHANICAL AND ELECTRICAL SHEETS FOR SCOPE OF WORK.
- G. PROVIDE POSITIVE SLOPE TO ALL FLOOR DRAINS WHILE KEEPING FLOOR LEVEL AT WALL BASE.
- H. COORDINATE SIZE AND LOCATION OF ALL ACCESS DOORS WITH TRADES REQUIRING SAME. QUANTITIES SHOWN DO NOT NECESSARILY REPRESENT ALL ACCESS DOORS REQUIRED FOR ACCESSIBILITY.

LEGEND

NEW WORK PLAN NOTE: NOT ALL SYMBOLS MAY BE USED

EXISTING CONSTRUCTION NEW CONSTRUCTION PARTITION TYPE - REFER TO PARTITION DETAILS SHEET A9.3 SHALL COMPLY WITH BARRIER FREE REQUIREMENTS

XXXX XXXX

CASEWORK/ MILLWORK TAG 10 1100 VISUAL DISPLAY SURFACE MK= MARKERBOARD, TK=TACKBOARD XXXX INDICATES BOARD SIZE

12 2413 ROLLER WINDOW SHADE

CORNER GUARD

KEYNOTES

NEW WORK FLOOR PLAN SHADED ITEMS HAVE BEEN REVISED FROM PREVIOUS

NOTE: NOT ALL KEYNOTES MAY BE USED

LEGEND SYMBOL INDICATOR

A1 AT BOTH SIDES OF DOOR PATCH & REPAIR 09 2900 GYPSUM BOARD JAMBS TO MATCH ADJACENT CONSTRUCTION - REINSTALL EXISTING WALL BASE AS REQUIRED.

- A2 PATCH/REPAIR GYPSUM BOARD/ PARTITION TO MATCH ADJACENT CONSTRUCTION.
- A3 03 3000 PATCH AND REPAIR CONCRETE FLOOR SLAB AT LOCATION OF REMOVED WALL OR SLAB PORTION. REFER TO TYPICAL DETAIL 5/A9.4
- A4 REINFORCE PARTITION WITH 06 1000 WOOD BLOCKING AS REQUIRED TO ACCOMODATE MILLWORK, TELEVISIONS, AND ACCESSORIES. REFER TO TYPICAL DETAIL 6/A9.4
- A5 10 2800 SAMPLE PASS THRU WINDOW

LEGEND

TOILET ACCESSORIES

SHADED ITEMS HAVE BEEN REVISED FROM PREVIOUS NOTE: NOT ALL KEYNOTES MAY BE USED

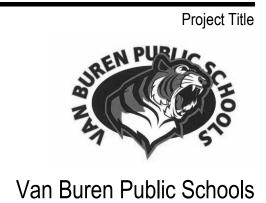
REFER TO SPECIFICATION SECTION 10 2800 FOR ADDITIONAL INFORMATION ALL TOILET ACCESSORIES ARE CONTRACTOR FURNISHED AND INSTALLED UON (OF/OI): OWNER FURNISHED/OWNER INSTALLED (OF/CI): OWNER FURNISHED/CONTRACTOR INSTALLED REFER TO DRAWING AR.0 FOR TYPICAL MOUNTING HEIGHTS

- ↓ LEGEND SYMBOL INDICATOR
- T1 GRAB BAR SET 1 (1) GRAB BAR TYPE 1, (1) GRAB BAR TYPE 2, (1) GRAB BAR TYPE 3 (CF/CI)
- T7 TOILET PAPER DISPENSER (OF/CI) T8 PAPER TOWEL DISPENSER (OF/CI)
- T13 MIRROR (CF/CI) T14 SOAP DISPENSER (OF/CI)

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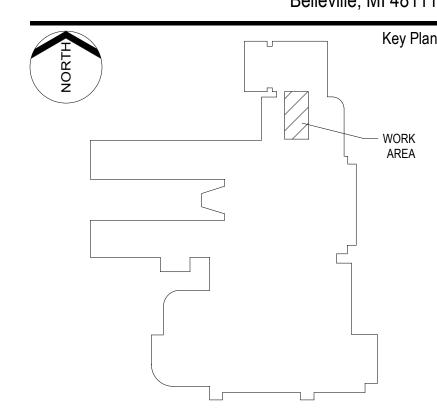
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A. Maurer Project Designer A. Pelfrey Project Architect / Engineer C. King C. King Q.M. Review Drawing Scale 1/4" = 1' - 0" Issue Date Issued for Design Development 07-03-2024

First Floor New Work Plan

 \circ 2024 Integrated $ext{design}$ solutions, LL

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24167-1000

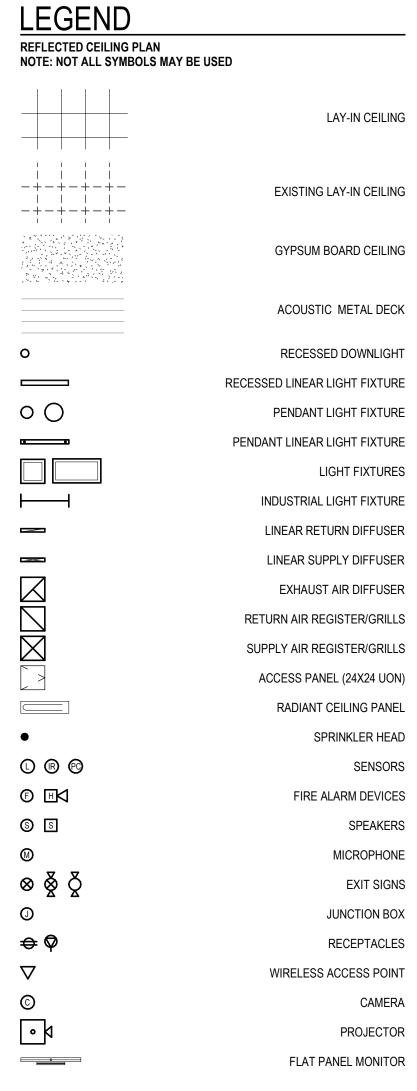
A2.1

REFLECTED CEILING PLAN

A. CEILING HEIGHT 9'-0" AFF UNLESS OTHERWISE NOTED.

- B. ACOUSTICAL CEILING PANELS AND/OR TILES SHALL BE CENTERED WITHIN THE ROOM OR BORDER UNLESS OTHERWISE NOTED.
- C. REFER TO FLOOR PLANS FOR PARTITION TYPE DESIGNATION.
- D. COORDINATE CEILING SUSPENSION SYSTEMS WITH OTHER CEILING SPACE EQUIPMENT SUPPORTING DEVICES.
- E. UNLESS OTHERWISE NOTED LOCATION OF ITEMS SHOWN IN AREAS WITHOUT FINISH CEILINGS IS APPROXIMATE. COORDINATE EXACT LOCATION BETWEEN TRADES.
- F. COORDINATE SIZE AND LOCATION OF ALL ACCESS DOORS WITH TRADES REQUIRING SAME. QUANTITIES SHOWN DO NOT NECESSARILY REPRESENT ALL ACCESS DOORS REQUIRED FOR ACCESSIBILITY.





<u>KEYNOTES</u>

REFLECTED CEILING PLAN
SHADED ITEMS HAVE BEEN REVISED FROM PREVIOUS
NOTE: NOT ALL KEYNOTES MAY BE USED

NOTE: NOT ALL KEYNOTES MAY BE USED


LEGEND SYMBOL INDICATOR

C1 GYPSUM BOARD/METAL STUD SOFFIT ABOVE. REFER TO TYPICAL DETAIL 9/A9.4



RAHS Belleville High School

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Pr	oject Administrator
	A. Maurer
	Project Designer
	A. Pelfrey
Project A	Architect / Engineer
	C. King
	Drawn By
	A. Pelfrey
	Q.M. Review
	-
	Approved
	-
	Drawing Scale
	1/4" = 1' - 0"
Issued for	Issue Date
Design Development	07-03-2024
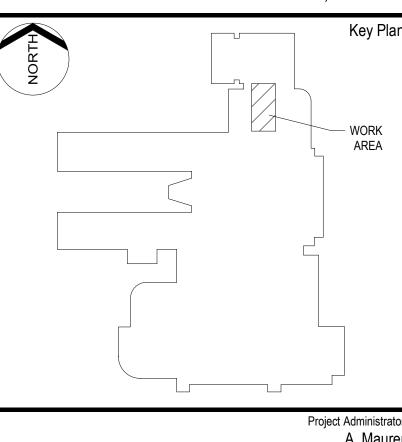
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First Floor Reflected Ceiling Plan

ī **D** Project Number

Drawing Number

24167-1000

A3.1

GENERAL NOTES INTERIOR ELEVATIONS A. ALL DIMENSIONS ARE TO FACE OF GYP BOARD UON. B. COORDINATE THE INTERFACING OF ALL TRADES WITH RESPECT TO DELIVERY AND INSTALLATION OF ALL FIXTURES AND EQUIPMENT C. CONTRACTOR TO FIELD VERIFY EXISTING CONDITIONS BEFORE INSTALLATION. CONSULT ARCHITECT WHEN ACTUAL FIELD INTEGRATED design SOLUTIONS architecture engineering interiors & technology CONDITIONS VARY FROM THOSE SHOWN ON CONSTRUCTION DOCUMENTS. D. COORDINATE LOCATIONS OF ALL REQUIRED UTILITIES WITH THE TRADE PROVIDING THE SAME. REFER TO MECHANICAL AND ELECTRICAL SHEETS FOR ADDITIONAL INFORMATION. E. FASTEN ALL TALL CASES TO THE ADJOINING WALL THROUGH THE BACK OR SIDE OF THE UNIT. F. ALL COUNTERTOPS INSTALLED ALONG A WALL OR EQUIPMENT ARE TO HAVE 4" BACKSPLASH AND SIDE SPLASH UON. G. FINISH ALL EXPOSED ENDS AND BACKS OF FREESTANDING CASEWORK/ MILLWORK. H. PROVIDE LOCKS ON ALL CABINET DOORS AND DRAWERS UON. ALL LOCKS SHOULD BE KEYED ALIKE BY ROOM, PROVIDE MASTER I. REFER TO A9.1 ROOM FINISH SCHEDULE FOR COLORS AND FINISHES OF MATERIALS J. REFER TO PLANS, SECTIONS AND DETAILS FOR CASEWORK DEPTH. K. PROVIDE CABINET FILLERS AS NEEDED. L. FURNITURE AND SPECIALTY EQUIPMENT BY OTHERS SHOWN FOR REFERENCE ONLY M. FURNITURE SHOWN AT HALFTONE BY OWNER N. PROVIDE PARTITION REINFORCEMENT AT LOCATIONS OF WALL MOUNTED EQUIPMENT. REFER TO DETAIL X/AX.X FOR TYPICAL REQUIREMENTS AT NEW CONSTRUCTION. CONDITIONS MAY VARY AT EXISTING PARTITIONS. O. NOT ALL SIGN LOCATIONS ARE ELEVATED

> **LEGEND** INTERIOR ELEVATIONS

NOTE: NOT ALL SYMBOLS MAY BE USED

XXXX 06 4023 CASEWORK / MILLWORK TAG XXXX 10 1100 VISUAL DISPLAY SURFACE MK= MARKERBOARD, TK=TACKBOARD XXXX INDICATES BOARD SIZE XXXX SPECIALTY EQUIPMENT BY OTHERS REFER TO FF&E OR TECHNOLOGY PACKAGES

P. COORDINATE LOCATIONS OF ALL REQUIRED UTILITY CONNECTIONS AND/OR REQUIREMENTS WITH THE TRADE PROVIDING THE SAME

ACCENT MATERIAL, REFER TO COLOR CODES

LEGEND

ELEVATION MATERIALS NOTE: NOT ALL SYMBOLS MAY BE USED

09 2900 GYP BOARD

Van Buren Public Schools

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501 W Columbia Ave

1441 west long lake, suite 200

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A. Maurer Project Designer A. Pelfrey

> Drawn By D. Sandle Q.M. Review

Drawing Scale As Noted

Issue Date

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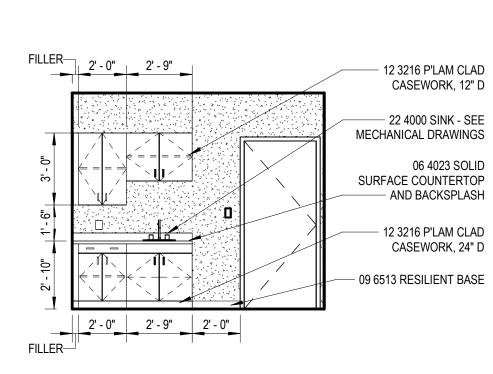
Interior Elevations

Drawing Number

A8.1

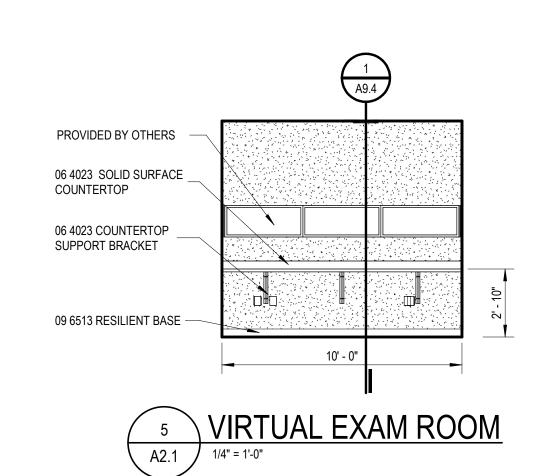
Project Architect / Engineer C. King

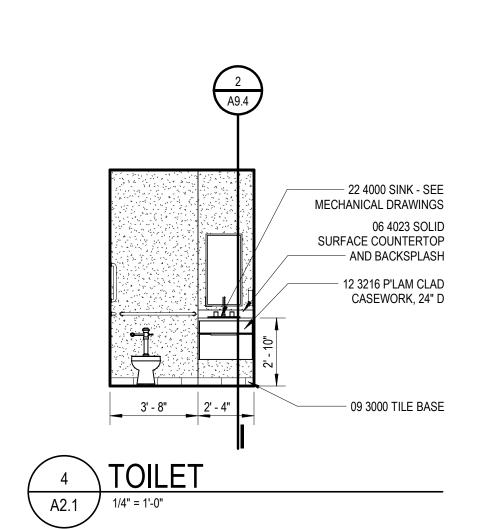
- 06 4023 SOLID SURFACE COUNTERTOP — 06 4023 COUNTERTOP SUPPORT BRACKET - 09 6513 RESILIENT BASE 6 MA AREA
1/4" = 1'-0"

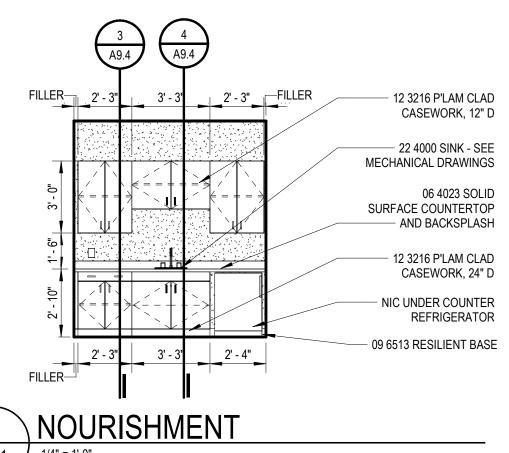


2' - 0" 2' - 9" 2' - 0" FILLER

EXAM ROOM







06 4023 SOLID SURFACE COUNTERTOP - AND BACKSPLASH 12 3216 P'LAM CLAD CASEWORK, 24" D 2' - 3" 3' - 3' 2' - 4" - 09 6513 RESILIENT BASE A2.1 / 1/4" = 1'-0"

7 LOBBY
A2.1 1/4" = 1'-0"

2 LAB
A2.1 1/4" = 1'-0"

06 4023 SOLID SURFACE COUNTERTOP

- 09 6513 RESILIENT BASE

- AND BACKSPLASH

- 12 3216 PLASTIC

- 12 3216 P'LAM CLAD CASEWORK, 12" D

- 22 4000 SINK - SEE

- AND BACKSPLASH

NIC UNDER COUNTER

- 09 6513 RESILIENT BASE

REFRIGERATOR

12 3216 P'LAM CLAD

CASEWORK, 24" D

06 4023 SOLID

MECHANICAL DRAWINGS

SURFACE COUNTERTOP

A2.1 / 1/4" = 1'-0"

24167-1000

ī **D** S Project Number

	SCH	EDULE	- ROON	/I FINISI	-	
NUMBER	NAME	FLOOR	BASE	WALL	CEILING	REMARKS
101	STORAGE	LVT-01	B-01	PT-01	AC-01	4
102	NOURISHMENT	LVT-01	B-01	PT-01	AC-01	1,4
103	EXAM NO. 1	LVT-01	B-01	PT-01,PT-02	AC-01,GYP-01,PT- 04	1,4
104	EXAM NO.2	LVT-01	B-01	PT-01,PT-02	AC-01,GYP-01,PT- 04	1,4
105	MA AREA	LVT-01	B-01	PT-01	AC-01	1,4
106	LOBBY/ RECEPTION	LVT-01	B-01	PT-01	AC-01	4,5
107	VIRTUAL EXAM ROOM	LVT-01	B-01	PT-01,PT-02	AC-01	1,4
108	LAB	LVT-01	B-01	PT-01,PT-02	AC-01,GYP-01,PT- 04	1,4
109	TOILET	FT-01	B-02	PT-01,PT-02	GYP-01,PT-04	4,6
110	STORAGE	LVT-01	B-01	PT-01	GYP-01	1
111	PATIENT INTAKE	LVT-01	B-01	PT-01,PT-02	AC-01	
112	CIRCULATION	LVT-01	B-01	PT-01	AC-01	1
H118	AV EQUIPMENT	CPT-02, (E)	(E)	PT-03	(E)	2
H120	THERAPY / SOCIAL WORK	CPT-01	B-01	PT-01	AC-01	4,5,8
H136	SCHOOL STORE	CPT-02,(E)	(E)	(E)	(E)	2

			SCHEDULE - COL	LOR CODES			
COLOR CODES	PRODUCT / MATERIAL	MANUFACTURER	PRODUCT NAME / NUMBER	COLOR NAME / NUMBER	SIZE	FINISH	NOTES
(E)	EXISTING FINISH						
AC-01	ACOUSTICAL PANEL						
B-01	RESILIENT BASE						
B-02	TILE BASE						
CG-01	CORNER GUARD						
CPT-01	CARPET (TILE/ BROADLOOM)						
CPT-02	CARPET (TILE/ BROADLOOM)			MATCH EXISTING			
FT-01	FLOOR TILE						
GYP-01	GYPSUM BOARD						
LVT-01	LUXURY VINYL TILE						
PL-01	PLASTIC LAMINATE						
PT-01	PAINT						FIELD
PT-02	PAINT						ACCENT
PT-03	PAINT			MATCH EXISTING			
PT-04	PAINT						CEILING
SC-01	SHADE CLOTH	DRAPER	FLEXSHADE ASCEND				MOUNTING: FASCIA WITH ENDCAPS
SS-01	SOLID SURFACE MATERIAL						
WD-01	WOOD						

ABBREVIATIONS

ROOM FINISH SCHEDULE AC PANEL ACOUSTICAL PANEL ACT ACOUSTICAL CEILING TILE COLOR CODE CORNER GUARD CMU CONCRETE MASONRY UNIT CERAMIC TILE CEM PLAS CEMENT PLASTER CONC DEFS CONCRETE DIRECT APPLIED EXTERIOR FINISH SYSTEM EXISTING FINISH EXTERIOR INSULATION FINISH SYSTEM EIFS **EPOXY PAINT** E TERR EPOXY TERRAZZO ENTR MAT ENTRY MAT SYSTEM EXP CONST EXPOSED CONSTRUCTION FWC FABRIC WALL COVERING GF CMU GL CMU GROUND FACE CONCRETE MASONRY UNIT GLAZED CONCRETE MASONRY UNIT GYP BD HD/SLR GYPSUM BOARD HARDENER/ SEALER IR GYP BD IMPACT RESISTANT GYPSUM BOARD LIMEST LIMESTONE LINO LINOLEUM MULTI-COLORED COATING MCC METAL MTL PNL METAL PANEL P LAM PLASTIC LAMINATE PAVER T PAVER TILE PLAS PLASTER POL CONC POLISHED CONCRETE PORC T PORCELAIN TILE QUARRY TILE RAISED ACCESS FLOORING **RUBBER TILE** RESIN FLR RESINOUS FLOORING RESILIENT RESIL STRUCTURAL GLAZED FACING TILE SGFT SHT V SHEET VINYL SOLID SURFACE MATERIAL SSM ST STL STAINLESS STEEL TRAFFIC COATING TERR TERRAZZO VCT VINYL COMPOSITION TILE VINYL WALLCOVERING VEN PLAS VENEER PLASTER WD WOOD

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GENERAL NOTES

ROOM FINISH SCHEDULE

* REFER TO ABBREVIATIONS LIST FOR MATERIAL CODE DESCRIPTIONS A. "ROOM NUMBER AND ROOM NAME" CORRESPOND TO THE NUMBER AND NAMES INDICATED ON THE SHEETS.

B. "MATERIAL/FINISH" INDICATE THE SPECIFIC MATERIALS AND FINISHES TO BE USED TO CONSTRUCT AND FINISH THE FLOORS, BASE, WALLS AND CEILINGS.

C. "CC" INDICATES THE COLOR CODE FOR EACH MATERIAL AND/OR FINISH, REFER TO "COLOR CODES".

D. "REMARKS" INDICATES ANY SPECIAL REQUIREMENTS FOR THE MATERIAL AND FINISH IN A ROOM - SEE "ROOM FINISH SCHEDULE REMARKS".

E. "CEILING" IS THE MATERIAL AND FINISH AT THE UNDERSIDE OF THE FLOOR OR ROOF ABOVE. "SOFFIT" IS THE MATERIAL AND FINISH AT THE UNDERSIDE OF THE STAIR RUN.

F. REFER TO A10 SERIES FOR FLOOR TILE PATTERNS AND MATERIALS.

G. REFER TO A8 SERIES FOR INTERIOR ELEVATIONS. H. "E" PREFIX TO THE "PT" CODE REFER TO EPOXY PAINT MATERIAL

REMARKS

(E PT-XX).

ROOM FINISH SCHEDULE

1. PL-01 PLASTIC LAMINATE, SS-01 SOILD SURFACE 2. CPT-02 AT AREAS EFFECTED BY FLOOR TRENCHING

3. PT-03 AT DOOR INFILL LOCATIONS

CLEAR ANODIZED

4. TOUCH UP PAINT REQUIRED. PATCH/REPAIR/PAINT ALL LOCATIONS WHERE WALL MOUNTED ITEMS ARE REMOVED, INCLUDING BUT NOT LIMITED TO CLOCKS, ALARMS, WIREWAYS, ETC. OR WHERE SELECTIVE DEMOLITION OCCURS - COORDINATE EXTENTS WITH DEMO AND NEW

5. TRANSITION AT CARPET TO LVT OR CARPET TO EXISTING TO BE SCHLUTER RENO U AEU 100 IN SATIN ANODIZED ALUMINUM

6. GROUT AT FLOOR TILE TO BE XXX. TRANSITION AT CERAMIC FLOOR TILE TO BE MARBLE THRESHOLD

7. SC-01 TO BE MOUNTED WITH FASCIA WITH ENDCAPS IN THE COLOR

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Key Plan

Project Administrator A. Maurer Project Designer A. Pelfrey Project Architect / Engineer C. King Drawn By D. Sandle Q.M. Review Approved Drawing Scale As Noted Issue Date Issued for Design Development 07-03-2024

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m design}$ solutions, LLC

Room Finish Schedule

ī**D**§ Project Number

	SCHEDULE - WINDOW SHADES									
TYPE	LENGTH	WIDTH	HOUSING	MANUFACTURER	MATERIAL	MECHANISM	MOUNTING			
W1	4' - 0"	6' - 0"	0"	DRAPER	SC-01	MANUAL- SINGLE ROLLER	OUTSIDE TOP MOUNT, SMALL HEADBOX			
W1: 1										
W2	4' - 0"	3' - 0"	0"	DRAPER	SC-01	MANUAL - SINGLE ROLLER	OUTSIDE TOP MOUNT, SMALL HEADBOX			

08 1113 HM FRAME -

 $\left\langle \text{DR SCHED} \right\rangle 3" = 1'-0"$

08 1113 HM FRAME -

NOTE: LOCATE GLASS ON

THE SIDE OF THE FRAME

NUMBERED THE SAME AS THE FRAME/DOOR

FACING THE ROOM

08 1113 HM GLASS

08 8000 GLASS -REFER TO FRAME TYPES AND/OR SCHEDULE

DR SCHED 3" = 1'-0"

08 8000 GLASS -REFER TO FRAME TYPES

AND/OR SCHEDULE

08 1113 HM GLASS

08 1113 HM FRAME -

FACING THE ROOM NUMBERED THE SAME AS THE FRAME/DOOR

NOTE: LOCATE GLASS ON THE SIDE OF THE FRAME

NOTE: LOCATE GLASS ON THE SIDE OF THE FRAME

FACING THE ROOM NUMBERED THE SAME AS THE FRAME/DOOR

08 1113 HM GLASS

TO FRAME TYPES

08 8000 GLASS -REFER

DR SCHED 3" = 1'-0"

STOP -

08 1113 HM FRAME ———

5 FRAME - HM

DR SCHED 3" = 1'-0"

STOP -

STOP —

PARTITION 7/16" WIDTH - SEE PLAN 4 7/8" AT CMU

FRAME - DOUBLE EGRESS HEAD

7/16" WIDTH - SEE PLAN 7/16"

4 7/8" AT CMU

10 FRAME - DOUBLE EGRESS JAMB

FRAME - HM W/ GLASS

1 15/16" 2 1/4"

7/16" PARTITION WIDTH - SEE PLAN 4 7/8" AT CMU

PARTITION
7/16"—WIDTH - SEE PLAN
4 7/8" AT CMU
7/16"

7/16"——PARTITION
7/16"—WIDTH - SEE PLAN
4 7/8" AT CMU

FRAME - HM W/ GLASS

										OOF	SCHE	DULE	•						
					DO	OR					FRAME			DETAILS			DOOR		
DOOR		5	SIZE													HARDWARE		WALL	
NUMBER	WIDTH	LEAF 1	LEAF 2	HEIGHT	TYPE	MATERIAL	FINISH/ CC	FRGM	TYPE	MATERIAL	FINISH / CC	FRGM	HEAD	JAMB	SILL	SET	RATING	RATING	REMARKS
101	3' - 0"	3' - 0"		7' - 0"	F	WD			Α	HM			4/A9.2	4/A9.2					
103	3' - 0"	3' - 0"		7' - 0"	F	WD			Α	HM			4/A9.2	4/A9.2					
104	3' - 0"	3' - 0"		7' - 0"	F	WD			Α	HM			4/A9.2	4/A9.2					
106	3' - 0"	3' - 0"		7' - 0"	G	WD			Α	HM			4/A9.2	4/A9.2					
107	3' - 0"	3' - 0"		7' - 0"	N	WD			Α	HM			4/A9.2	4/A9.2					
108	3' - 0"	3' - 0"		7' - 0"	N	WD			Α	HM			4/A9.2	4/A9.2					
109	3' - 0"	3' - 0"		7' - 0"	F	WD			Α	HM			4/A9.2	4/A9.2					
110	3' - 0"	3' - 0"		7' - 0"	F	WD			Α	HM			4/A9.2	4/A9.2					
112	3' - 0"	3' - 0"		7' - 0"	G	WD			Α	HM			4/A9.2	4/A9.2					

DETAILO				I	
DETAILS			DOOR	10/01/	
JAMB	SILL	HARDWARE SET	ASSEMBLY RATING	WALL RATING	REMARKS
4/A9.2					

ENERAL NOTES

OR SCHEDULE

OTHERWISE NOTED.

REFER TO THE DRAWINGS FOR DOOR LOCATIONS

- "DOOR NUMBER" CORRESPONDS TO THE DOOR NUMBER INDICATED ON THE DRAWINGS. NOTE: AT EXISTING WALL OPENINGS, FIELD VERIFY SIZE OF DOORS AND FRAMES.
- (DOOR) "SIZE" INDICATES THE NOMINAL WIDTH AND HEIGHT OF THE DOOR IN FEET AND INCHES. ALL DOORS ARE 1 3/4" THICK UNLESS
- . "DOOR AND FRAME TYPE/MATL/FINISH" INDICATES THE CODES FOR TYPE (INDICATED ON THE DRAWINGS), MATERIAL AND FINISH.
- E. "CC" INDICATES THE COLOR CODE FOR FINISHES OF DOORS AND FRAMES, SEE "SCHEDULE - COLOR CODES".
- F. "DETAILS HEAD- JAMB-SILL" INDICATES THE DETAIL NUMBER INDICATED ON THE DRAWINGS.
- G. "HARDWARE SET" INDICATES HARDWARE SET NUMBERS SPECIFIED IN 08 7100 - DOOR HARDWARE.
 - H. "DOOR ASSEMBLY RATING" INDICATES THE MINIMUM FIRE RESISTANCE RATING FOR FIRE DOORS AND/OR SIDELITES. I. "WALL RATING" INDICATES THE FIRE RESISTANCE RATING OF THE
 - WALL CONTAINING THE DOOR. J. "FRGM" INDICATES FIRE-RATED GLAZING MARKINGS.
 - K. "REMARKS" INDICATES ANY SPECIAL REQUIREMENTS FOR A DOOR AND FRAME - SEE "DOOR SCHEDULE - REMARKS".

REMARKS

- DOOR SCHEDULE
- ACCESS CONTROL SYSTEM REMOVABLE MULLION
- 3. LOW ENERGY POWER OPERATED DOOR 4. POWER OPERATED DOOR PACKAGE DOOR ASSEMBLY (ALL
- HARDWARE BY DOOR MANUFACTURER) HOLLOW METAL ASTRAGAL


FIRE-RATED GLAZING ASSEMBLIES MARKING W MEETS WALL ASSEMBLY CRITERIA

- OH MEETS FIRE WINDOW ASSEMBLY CRITERIA INCLUDING THE HOSE STREAM TEST
- MEETS FIRE DOOR ASSEMBLY CRITERIA MEETS FIRE DOOR ASSEMBLY "HOSE STREAM" TEST
- MEETS 450 DEG F TEMPERATURE RISE CRITERIA FOR 30 MINUTES NT DOES NOT MEET 450 DEG F TEMPERATURE RISE CRITERIA FOR 30
- XXX TIME IN MINUTES OF THE FIRE RESISTANCE OR FIRE PROTECTION RATING OF THE GLAZING ASSEMBLY

ABBREVIATIONS

DOOR SCHEDULE	
ALUM	ALUMINUN
ANOD	ANODIZED
CC	COLOR CODES
(E)	EXISTING
FBR	FIBERGLASS
FRP	FIBERGLASS REINFORCED PANEI
FAC	FACTOR
GL	GLASS
180	180 MINUTES (3 HOUR
90	90 MINUTES (1 1/2 HOUR
60	60 MINUTES (1HOUR
45	45 MINUTES (3/4 HOUR
20	20 MINUTES (1/3 HOUR
HM	HOLLOW META
HDWE	HARDWARE
MATL	MATERIA
P LAM	PLASTIC LAMINATE
PT DVF	PAINT
PVF	POLYVINYL FLUORIDE COATING (KYNAR
STN	STAIN COAIN FOR STEEL
ST STL	STAINLESS STEE
STL	STEEI
WD	WOOL

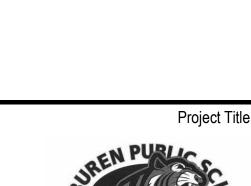WIRE MESH



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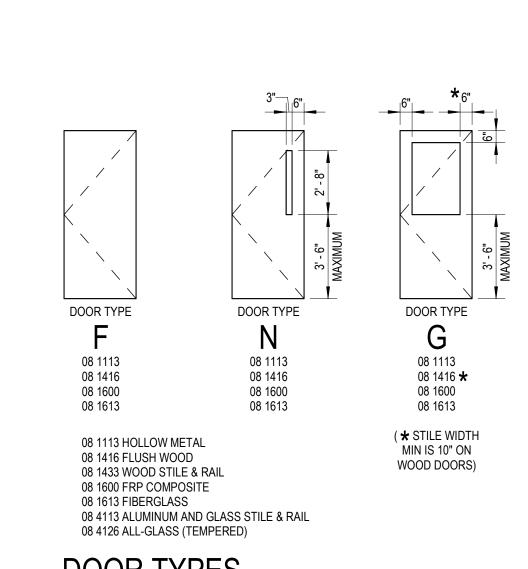
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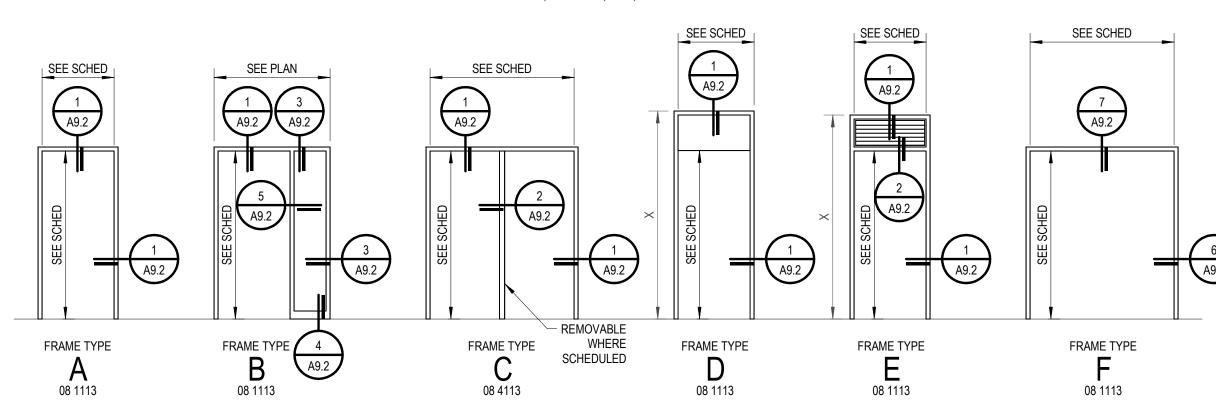
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NOTE: ALL GLASS TO BE 1/4" SAFETY GLASS EXCEPT USE FIRE RATED GLASS AT FIRE RATED DOORS, SIDELITES, ETC., UON



FRAME TYPES

NOTE: ALL GLASS TO BE 1/4" SAFETY GLASS EXCEPT USE FIRE RATED GLASS AT FIRE RATED DOORS, SIDELITES, ETC., UON

JAMB(HEAD SIM) 3" = 1'-0"	
N.	
	SEE NOTES BELOW
DOOR STOP	DOOR AND FRAME AS SCHEDULED
09 6543 EDGE STRIP 09 6816 CARPET OR 09 6813 CARPET TILE	09 6516/6519 RESILIENT FLOORING EXISTING CONCRETE TOP OF FLOOR SLAB
3 SILL 3" = 1'-0"	
	SEE NOTES BELOW
DOOR STOP	DOOR AND FRAME AS SCHEDULED
09 3000 TILE AS SCHEDULED	09 6516/6519 RESILIENT FLOORING
	TOP OF FLOOR SLAB
09 3000 MORTAR SETTING BED	09 3000 METAL EDGE STRIP
² SILL	
3" = 1'-0"	SEE NOTES BELOW
	DOOR AND FRAME AS SCHEDULED

WIDTH - SEE PLAN

INTERSECTING WALL

08 1113 FLOOR ANCHOR CLIP (BELOW)

DOOR STOP -

09 6816 CARPET OR

09 6813 CARPET TILE

CONDITION —

- PARTITION TYPE-

REFER TO PLAN

07 9200 SEALANT

FRAME PROFILE)

ANCHOR CLIP-GROUT

09 6513 RESILIENT

- 09 6816 CARPET OR

09 6813 CARPET TILE

TOP OF FLOOR SLAB

EDGE STRIP

- 08 1113 HOLLOW METAL FRAME

(REFER TO FRAME TYPE FOR

(BOTH SIDES)

A. Maurer Project Designer A. Pelfrey Project Architect / Engineer C. King Drawn By A. Pelfrey Q.M. Review Drawing Scale As Noted Issue Date Issued for Design Development 07-03-2024 \circ 2024 Integrated $ext{design}$ solutions, LL Door Schedule and Details

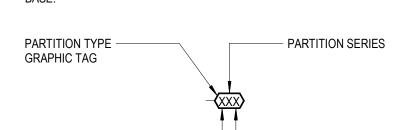
ī **D** Project Number Drawing Number

24167-1000

A9.2

- INTERIOR PARTITIONS

 1. "WALL" AND "PARTITION" ARE USED TO DENOTE EITHER WALLS OR
- PARTITIONS INTERCHANGEABLY.
- REFER TO SHEET AR.0 ARCHITECTURAL REFERENCE INFORMATION FOR ABBREVIATIONS, SYMBOLS, AND GRAPHIC INDICATIONS.
- 3. REFER TO COMPOSITE LIFE SAFETY PLANS FOR PARTITION FIRE RATINGS.
- 4. REFER TO ROOM FINISH SCHEDULE FOR WALL FINISHES AND WALL



2 = 2-HR FIRE RATED
3 = 30 MIN FIRE RATED

MATERIAL DESIGNATION SIZE ACTUAL SIZE SPACING

MASONRY

4 3 5/8 " N/A
6 5 5/8 "
8 7 5/8 "
12 11 5/8 "

STEEL STUDS
1 1 5/8 "
12 2 1/2 "
3 3 3 5/8 "
4 4"
6 6 6"

FURRING
0 7/8 " 16" OC

5. SUBSTITUTE 09 2900 - TILE BACKING BOARD AT LOCATIONS TO RECEIVE A TILE WALL FINISH.

SHAFTWALL C-H STUDS

CLOSURE AS REQUIRED.

6. ALL NON-LOAD BEARING METAL WALL FRAMING SHALL BE BASED ON TOTAL STUD HEIGHT. REFER TO SPECIFICATION SECTIONS 05 4000 - COLD-FORMED METAL FRAMING, 09 2116 - GYPSUM BOARD SHAFT WALL ASSEMBLIES AND 09 2216 - NON-STRUCTURAL METAL FRAMING FOR ADDITIONAL REQUIREMENTS.

1 5/8 " 2 1/2 " 3 5/8 "

2 1/2 " 24" OC

- 7. WHERE ROOMS WITH DIFFERENT PARTITION REQUIREMENTS ARE ADJACENT, THE PARTITION WITH THE GREATER FIRE-RATING AND/OR STC SHALL BE USED BETWEEN THEM.
- 8. AT INTERSECTIONS OF DIS-SIMILAR PARTITON TYPES, THE HIGHEST RATED PARTITION IS TO RUN THROUGH THE INTERSECTION TO MAINTAIN ENCLOSURE. MAINTAIN RATING OF RATED PARTITION AT INTERSECTION WITH COLUMN ENCLOSURES BY EXTENDING RATED
- 9. FIRE-RATED PARTITIONS SHALL BE CONSTRUCTED ACCORDING TO THE FIRE TEST INDICATED. NO SUBSTITUTIONS OF MATERIALS OR DEVIATIONS FROM CONSTRUCTION ARE ALLOWED. ADDITIONAL LAYERS MAY BE REQUIRED FOR ACOUSTICAL OR OTHER REASONS AND MUST BE EXECUTED AS SHOWN.
- 10. STC RATINGS ARE MINIMUM ACOUSTICAL PERFORMANCE REQUIREMENT. SPECIFIC ACOUSTICAL TESTS ARE GIVEN FOR REFERENCE ONLY. SOUND ATTENUATION BLANKET THICKNESS SHALL BE AS FOLLOWS:
- A. 1 1/2 " FOR PARTITIONS WITH 1 5/8 " AND 2 1/2 " STUDS (INCLUDING SHAFTWALLS).
 B. 3" FOR PARTITIONS WITH 3 5/8 ", 4" OR 6" STUDS.

11. DETAILS ARE DIAGRAMMATIC - PRECISE REQUIREMENTS OF TESTS ASSEMBLIES SHALL GOVERN.

B. 3" FOR PARTITIONS WITH 3 5/8", 4" OR 6" STUDS.
C. 3" FOR SHAFTWALLS WITH 4" OR 6" STUDS UNO.
D. AS REQUIRED FOR FIRE RATING.

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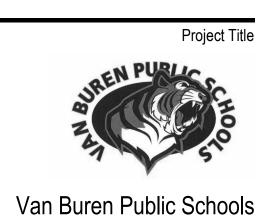
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Key Pi

FACE OF WALL CONSTR
REFER TO PLAN

O9 2216 METAL STUDS

O9 2900 5/8" GYPSUM BOARD

O9 2216 METAL RUNNER CHANNEL
(SECURED TO FLOOR)

BASE AS SCHEDULED

O9 2900 ACOUSTICAL SEALANT (CONT)

11/2"

OF0

2 11/4"

OF3


4 5/8"

OF4

6 5/8"

OF6

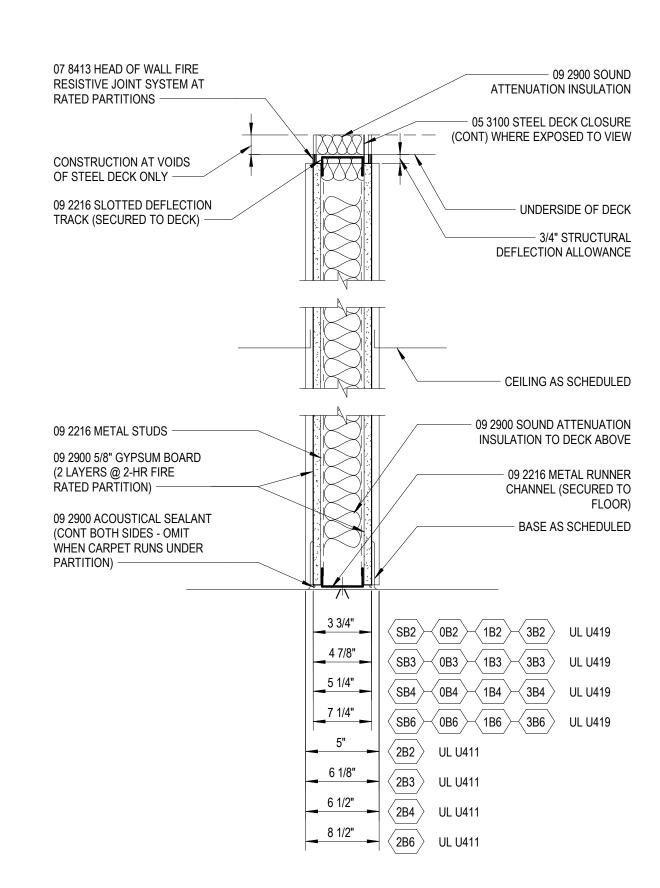PARTITION SERIES 'F'




PARTITION SERIES 'B'

Partition Types


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9 CEILING DROP

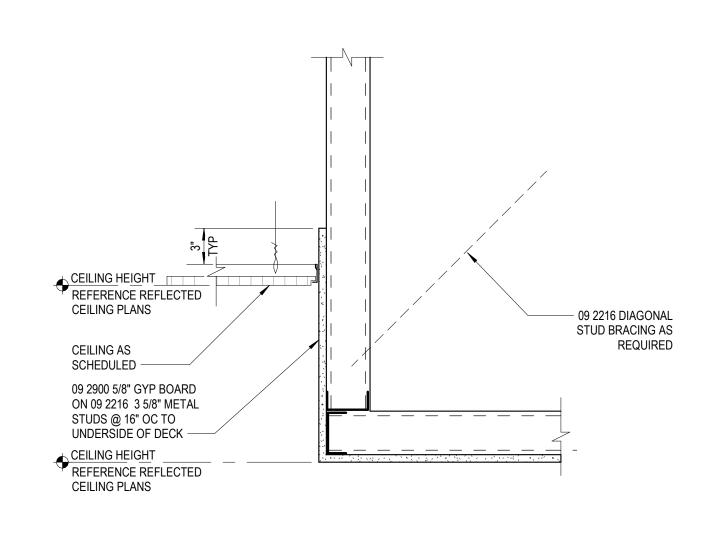A3.1 1/2" = 1'-0"



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> A. Maurer Project Designer A. Pelfrey
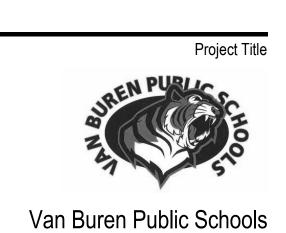
> > C. King Drawn By A. Pelfrey Q.M. Review


Drawing Scale As Noted

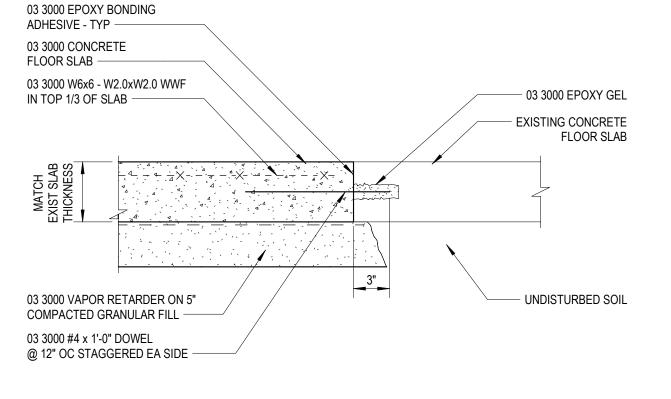Issue Date

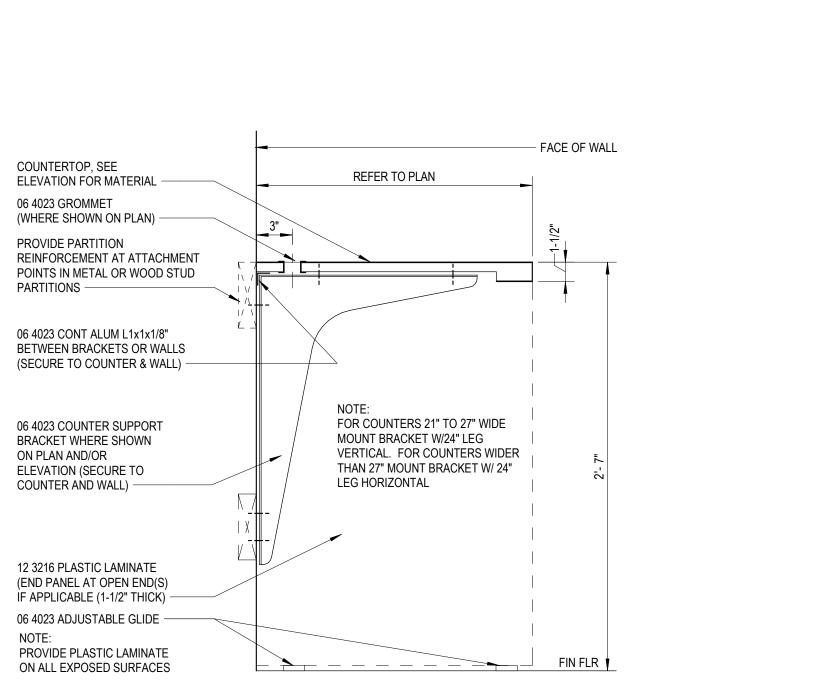
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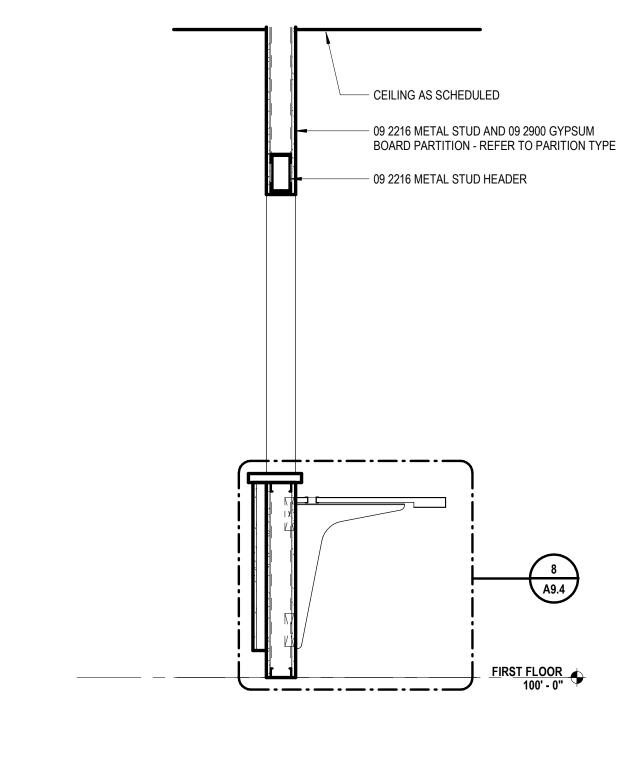
Project Architect / Engineer



CONCRETE FLOOR SLAB INFILL



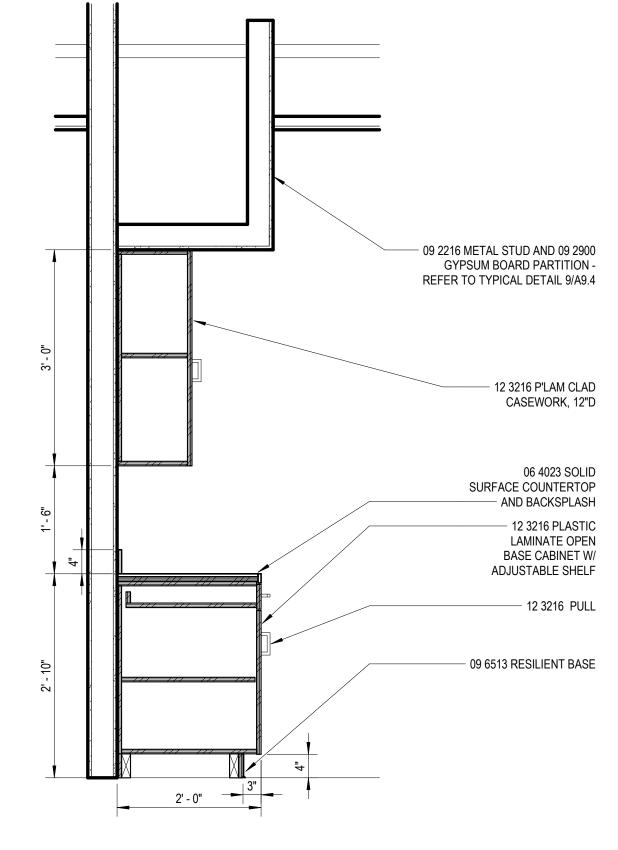
COUNTER (METAL BRACKET) A8.1



WALL SECTION


REINF ONE SIDE ONLY FULL LENGTH OF PARTITION SEE PLAN FIN FLR LINE 06 1000 2x8 TREATED WOOD BLOCKING (SECURE TO FACE OF METAL STUDS) — CENTER LINE & LOCATION OF WOOD BLOCKING (SEE ELEVATION) -METAL STUD PARTITION -REFER TO PLANS —

TYP PTN REINFORCEMENT



BASE CABINET - SECTION DETAIL

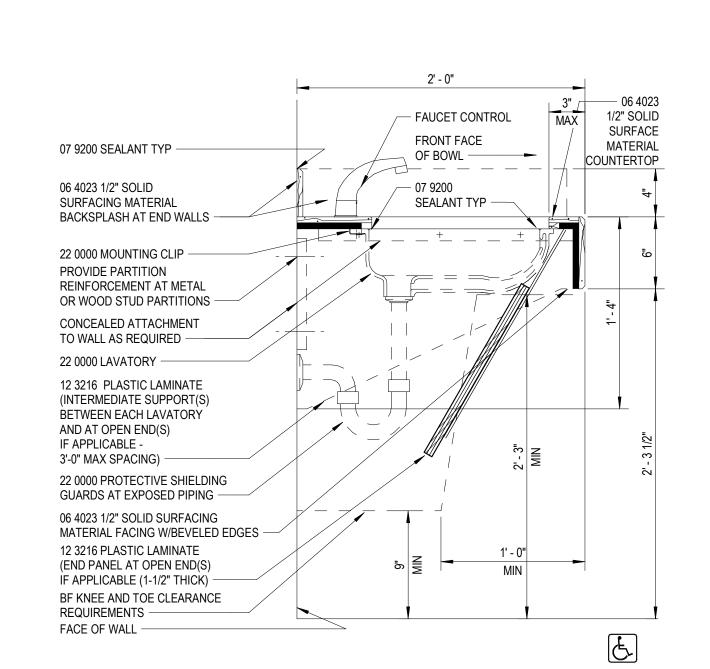3
3/4" = 1'-0"



SECTION DETAL @ADA SINK

- 09 2216 METAL STUD AND 09 2900 GYPSUM BOARD PARTITION -REFER TO TYPICAL DETAIL 9/A9.4 2' - 0"

REFER TO TYPICAL COUNTER SUPPORT DETAIL 1/A8.1

8 WALL SECTION DETAIL

A9.4 1 1/2" = 1'-0"

BASE CABINET - SECTION DETAIL

A8.1

3/4" = 1'-0"

06 4023 SOLID SURFACE COUNTERTOP

- AND BACKSPLASH

— 12 3216 P'LAM CLAD ON

09 2216 METAL STUD AND 09 2900 GYPSUM BOARD PARTITION

09 6513 RESILIENT BASE

FIRST FLOOR 100' - 0"

- 12 3216 P'LAM CLAD

CASEWORK, 12"D

06 4023 SOLID

AND BACKSPLASH

- 12 3216 PLASTIC

LAMINATE OPEN

— 12 3216 PULL

BASE CABINET W/

ADJUSTABLE SHELF

SURFACE COUNTERTOP

ī **D** s Project Number

A9.4

Drawing Number

Sections and Details

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GENERAL NOTES

A. REFER TO ROOM FINISH SCHEDULE AND COLOR CODES FOR MORE INFORMATION.

09 3000 PORC FLOOR TILE FT-01

09 6813 CARPET TILE CPT-01

09 6813 CARPET TILE CPT-02

09 6516/6519 RESILIENT TILE LVT-01

FLOORING INSTALLATION DIRECTION

ACCENT MATERIAL, REFER TO COLOR CODES

FLOORING INSTALLATION METHOD - ASHLAR

FLOORING INSTALLATION METHOD - MONOLITHIC

FLOORING INSTALLATION METHOD - QUARTER TURN

FLOORING INSTALLATION METHOD - NON-DIRECTIONAL

FLOORING INSTALLATION METHOD - HERINGBONE

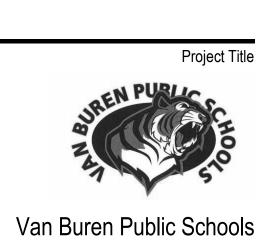
NOTE: FINISHES INDICATED IN ROOM FINISH TAGS ARE GENERAL OVERALL FINISHES FOR

REMARK, DETAIL AND/OR ELEVATION

ROOM UNLESS OTHERWISE INDICATED BY NOTE,


ROOM SPECIFIC FINISH REMARKS, REFER TO REMARKS LEGEND FOR ADDITIONAL INFORMATION

FLOOR MATERIAL TRANSITION TAG REFER TO A.9.2 FOR TRANSITION/ SILL DETAILS



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1/4" = 1' - 0" Issue Date Issued for Design Development 07-03-2024


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First Floor Finish Plan

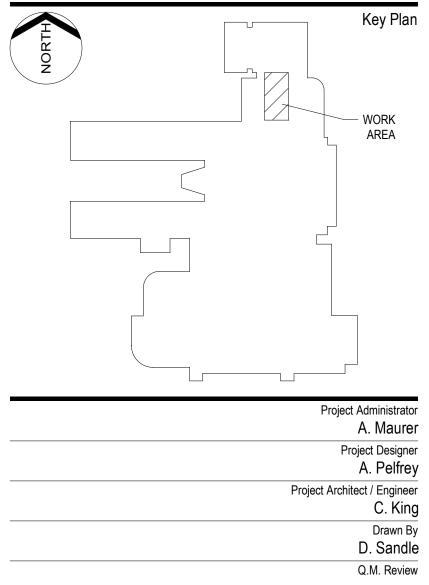ī **D** Project Number

Drawing Number

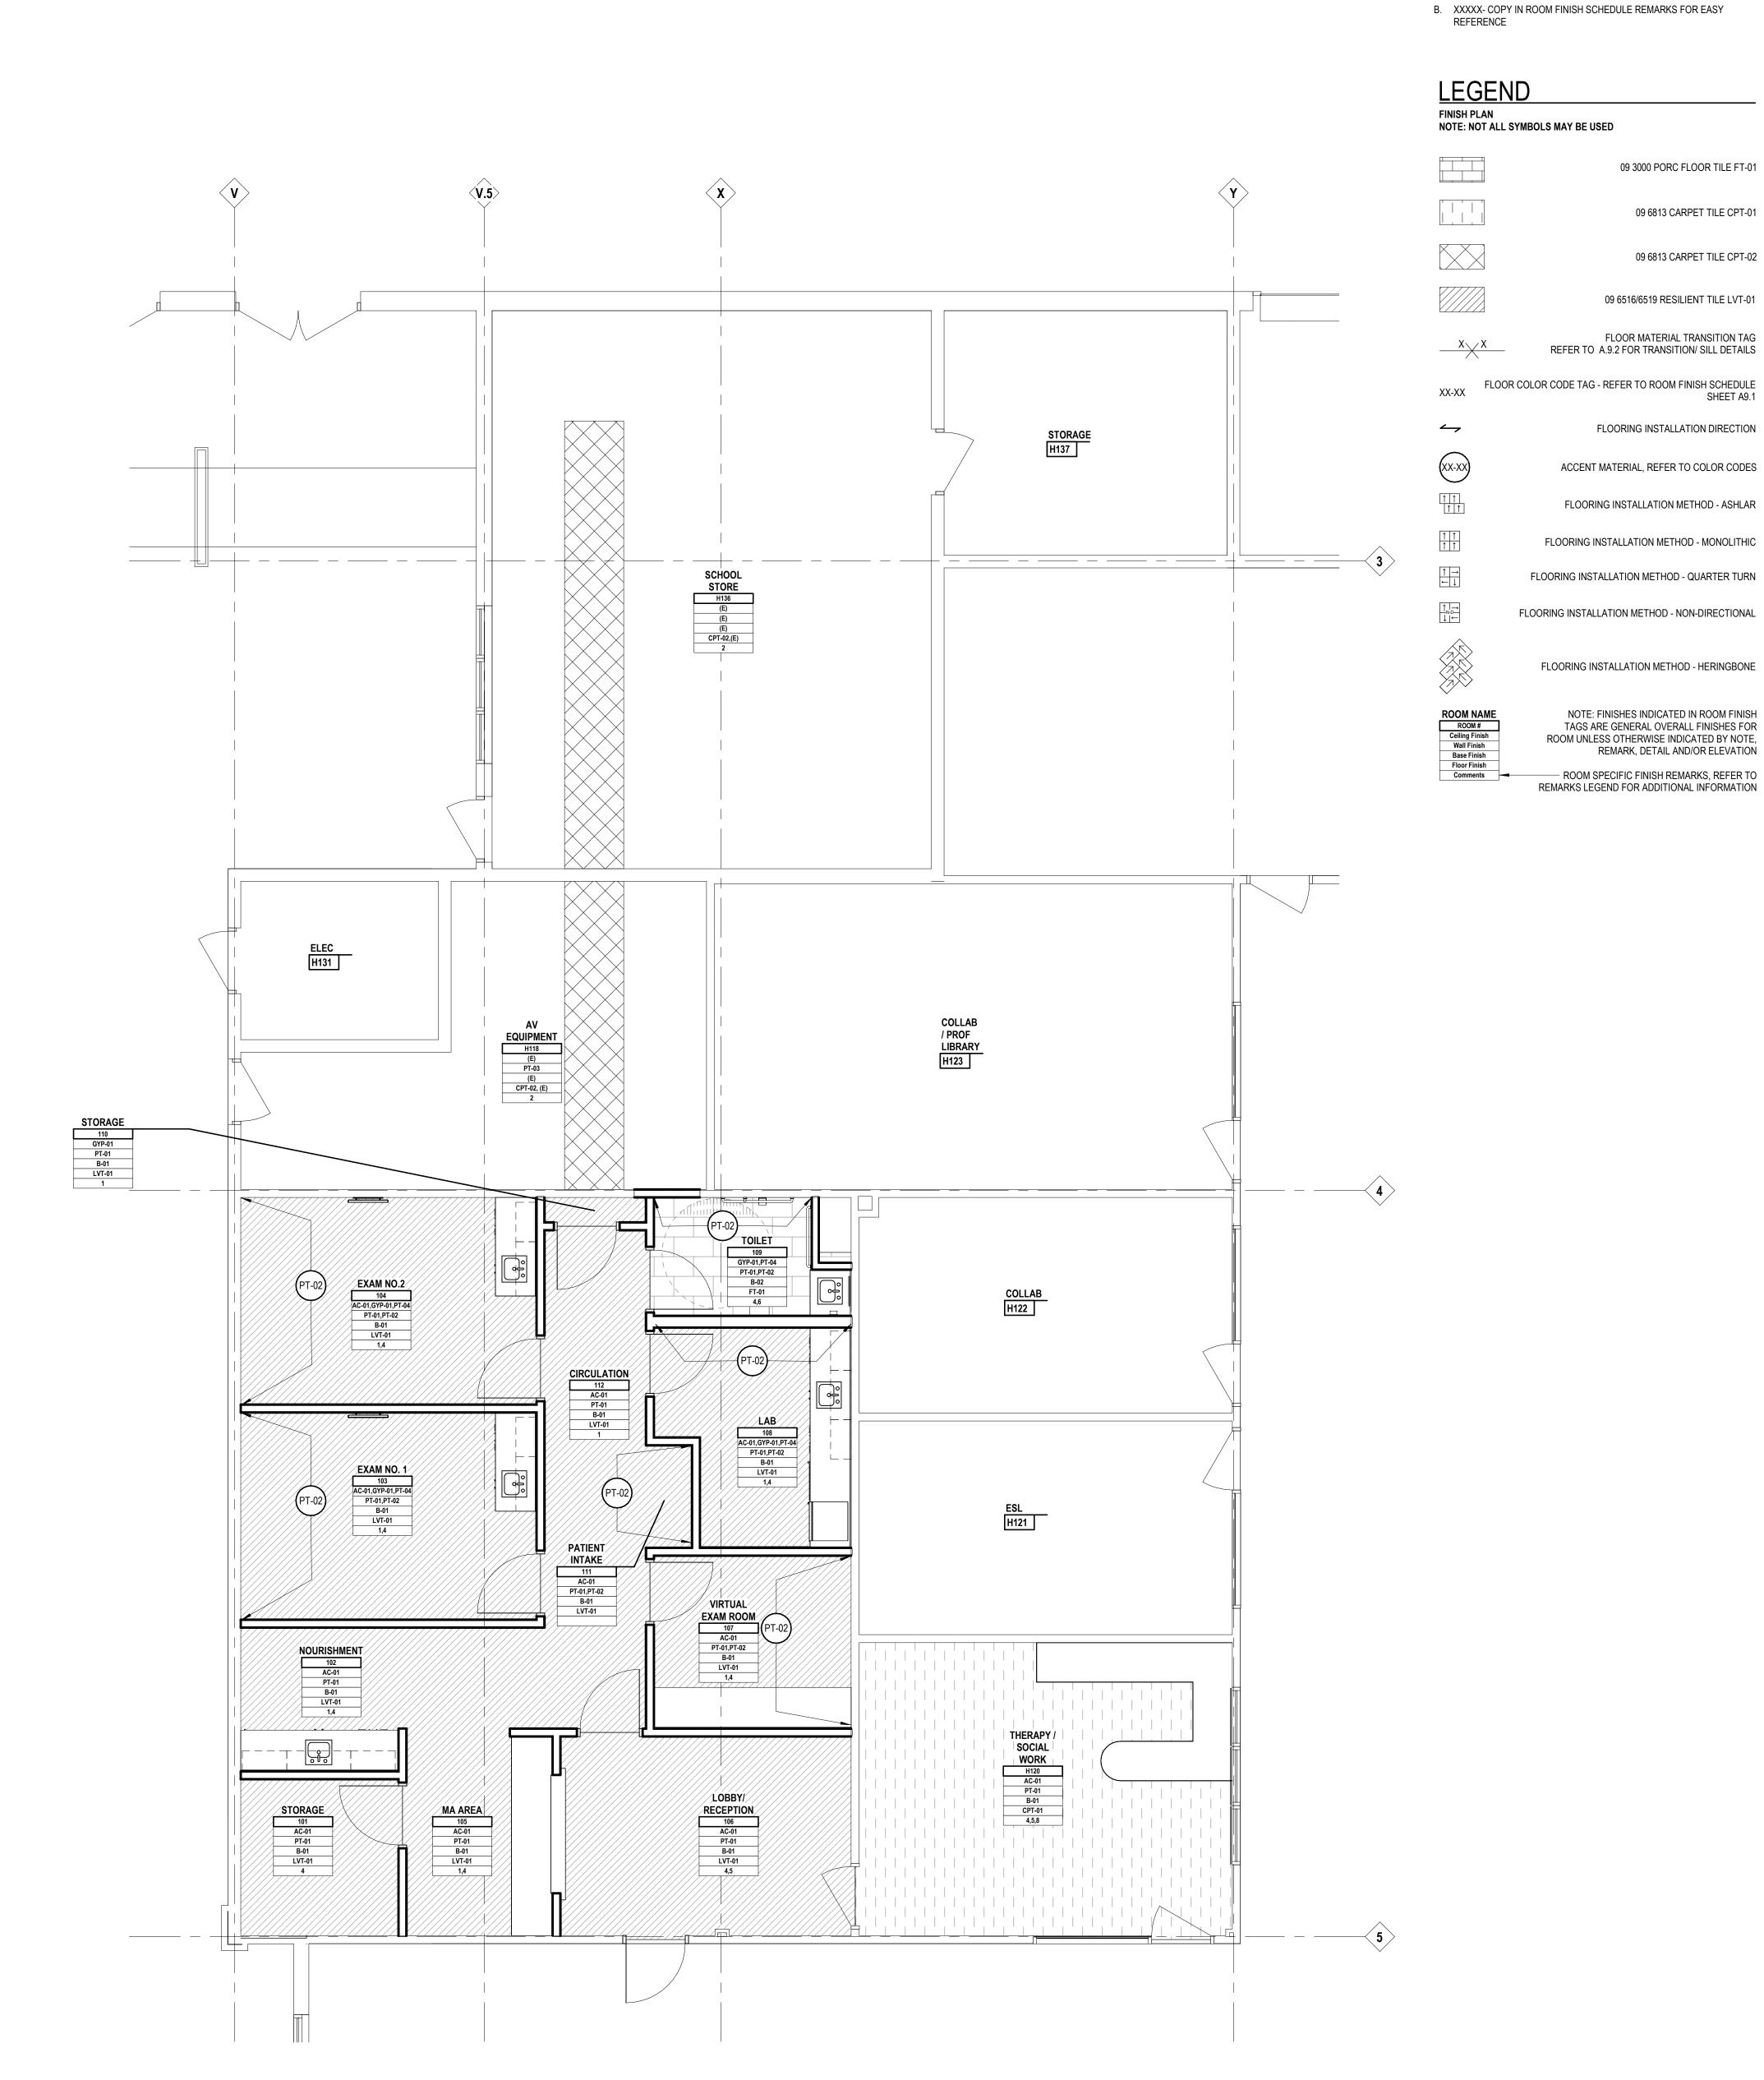A10.1




- FURNITURE FIXTURE AND EQUIPMENT PLAN A. ITEMS SHOWN IN GRAYSCALE ARE FOR REFERENCE ONLY.
- B. COORDINATE THE INTERFACING OF ALL TRADES WITH RESPECT TO DELIVERY AND INSTALLATION OF ALL FURNITURE, FIXTURES AND EQUIPMENT
- C. CONTRACTOR TO FIELD VERIFY EXISTING CONDITIONS BEFORE INSTALLATION. CONSULT ARCHITECT WHEN ACTUAL FIELD CONDITIONS VARY FROM THOSE SHOWN ON CONSTRUCTION DOCUMENTS.
- D. COORDINATE LOCATIONS OF ALL REQUIRED UTILITIES WITH THE TRADE PROVIDING THE SAME. REFER TO MECHANICAL AND ELECTRICAL SHEETS FOR ADDITIONAL INFORMATION.


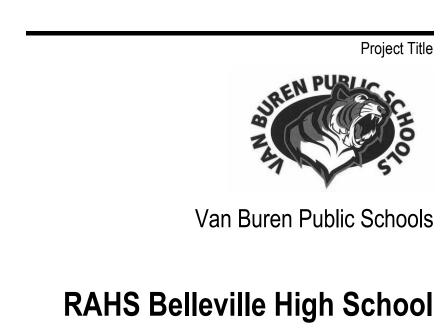
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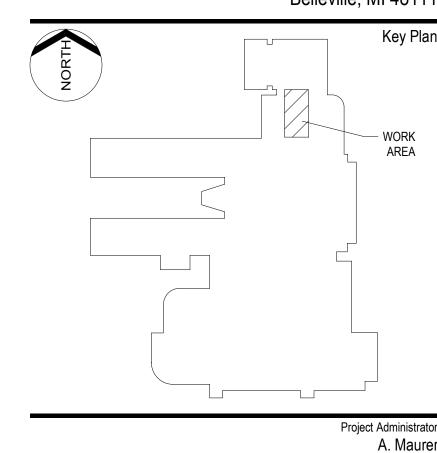
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Project Architect / Engineer
C. King
Drawn By
D. Sandle
Q.M. Review



	Drawing Sca 1/4" = 1' - (
Issued for	Issue Dat
Design Development	07-03-202

First Floor Furniture Plan


 \circ 2024 Integrated $ext{design}$ solutions, LLC IDS Drawing Title


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F2.1





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SUPPLY AIR BRANCH CONNECTION

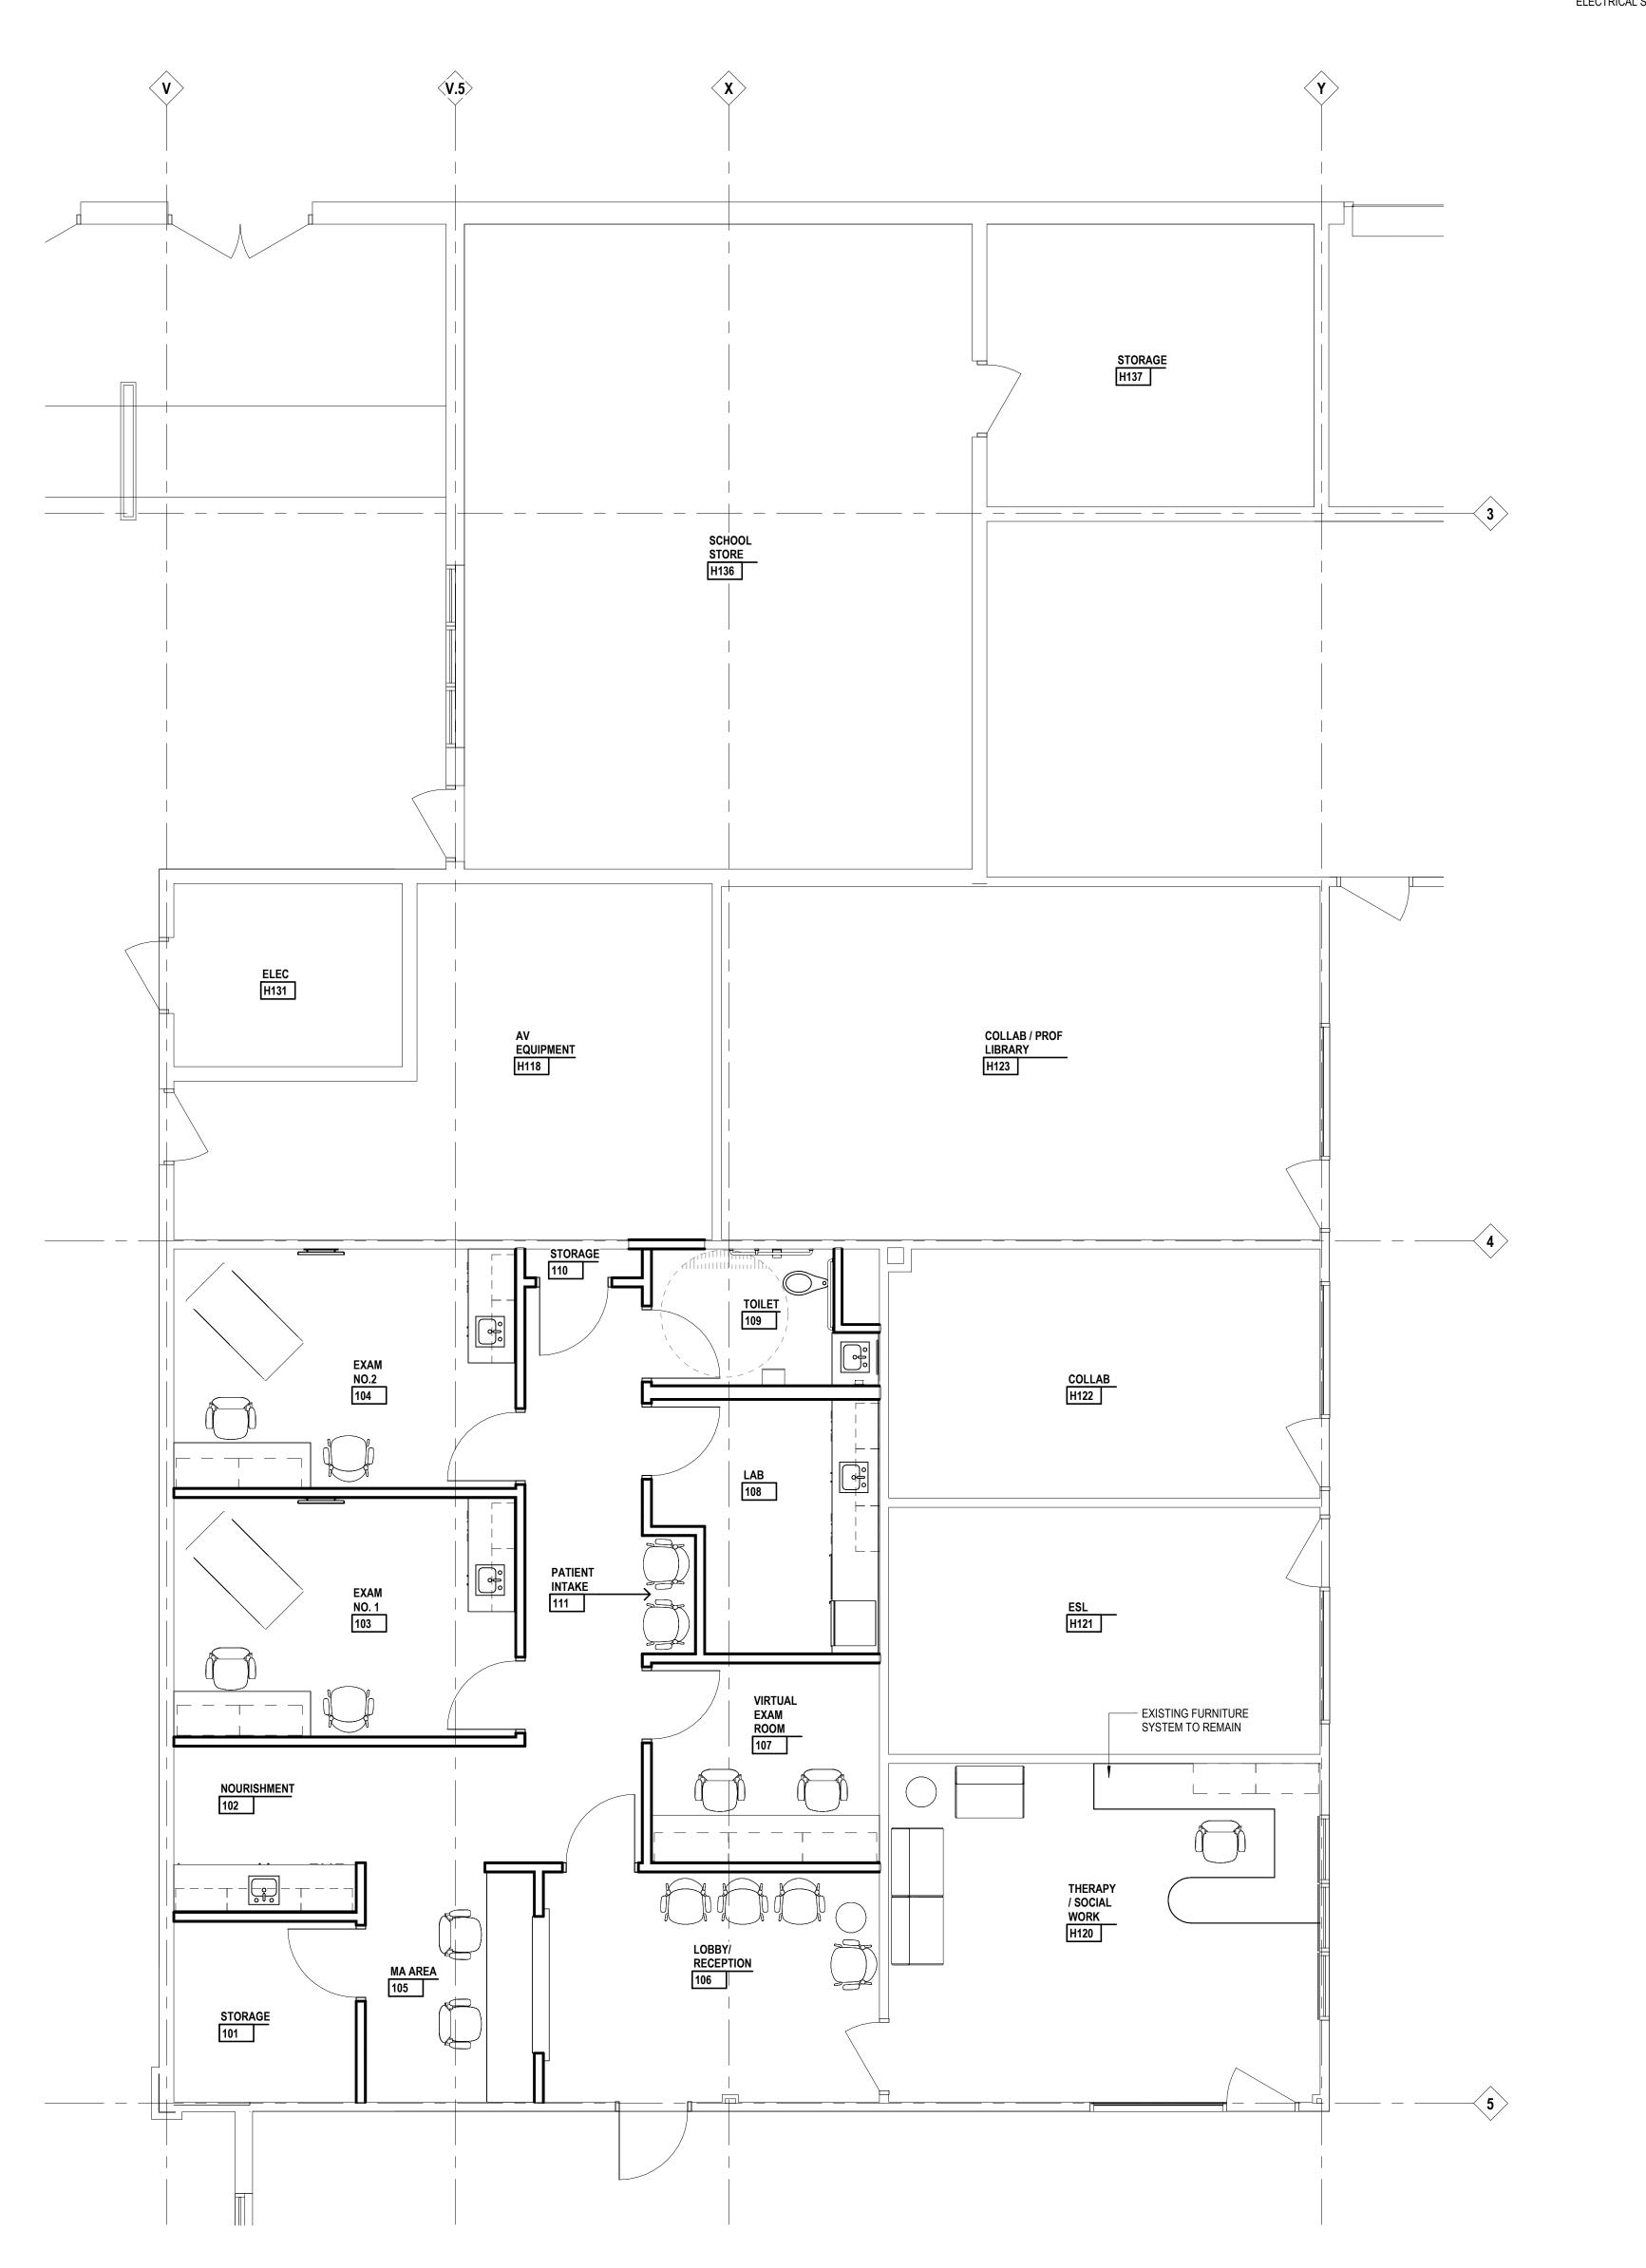EXHAUST FAN No. 1

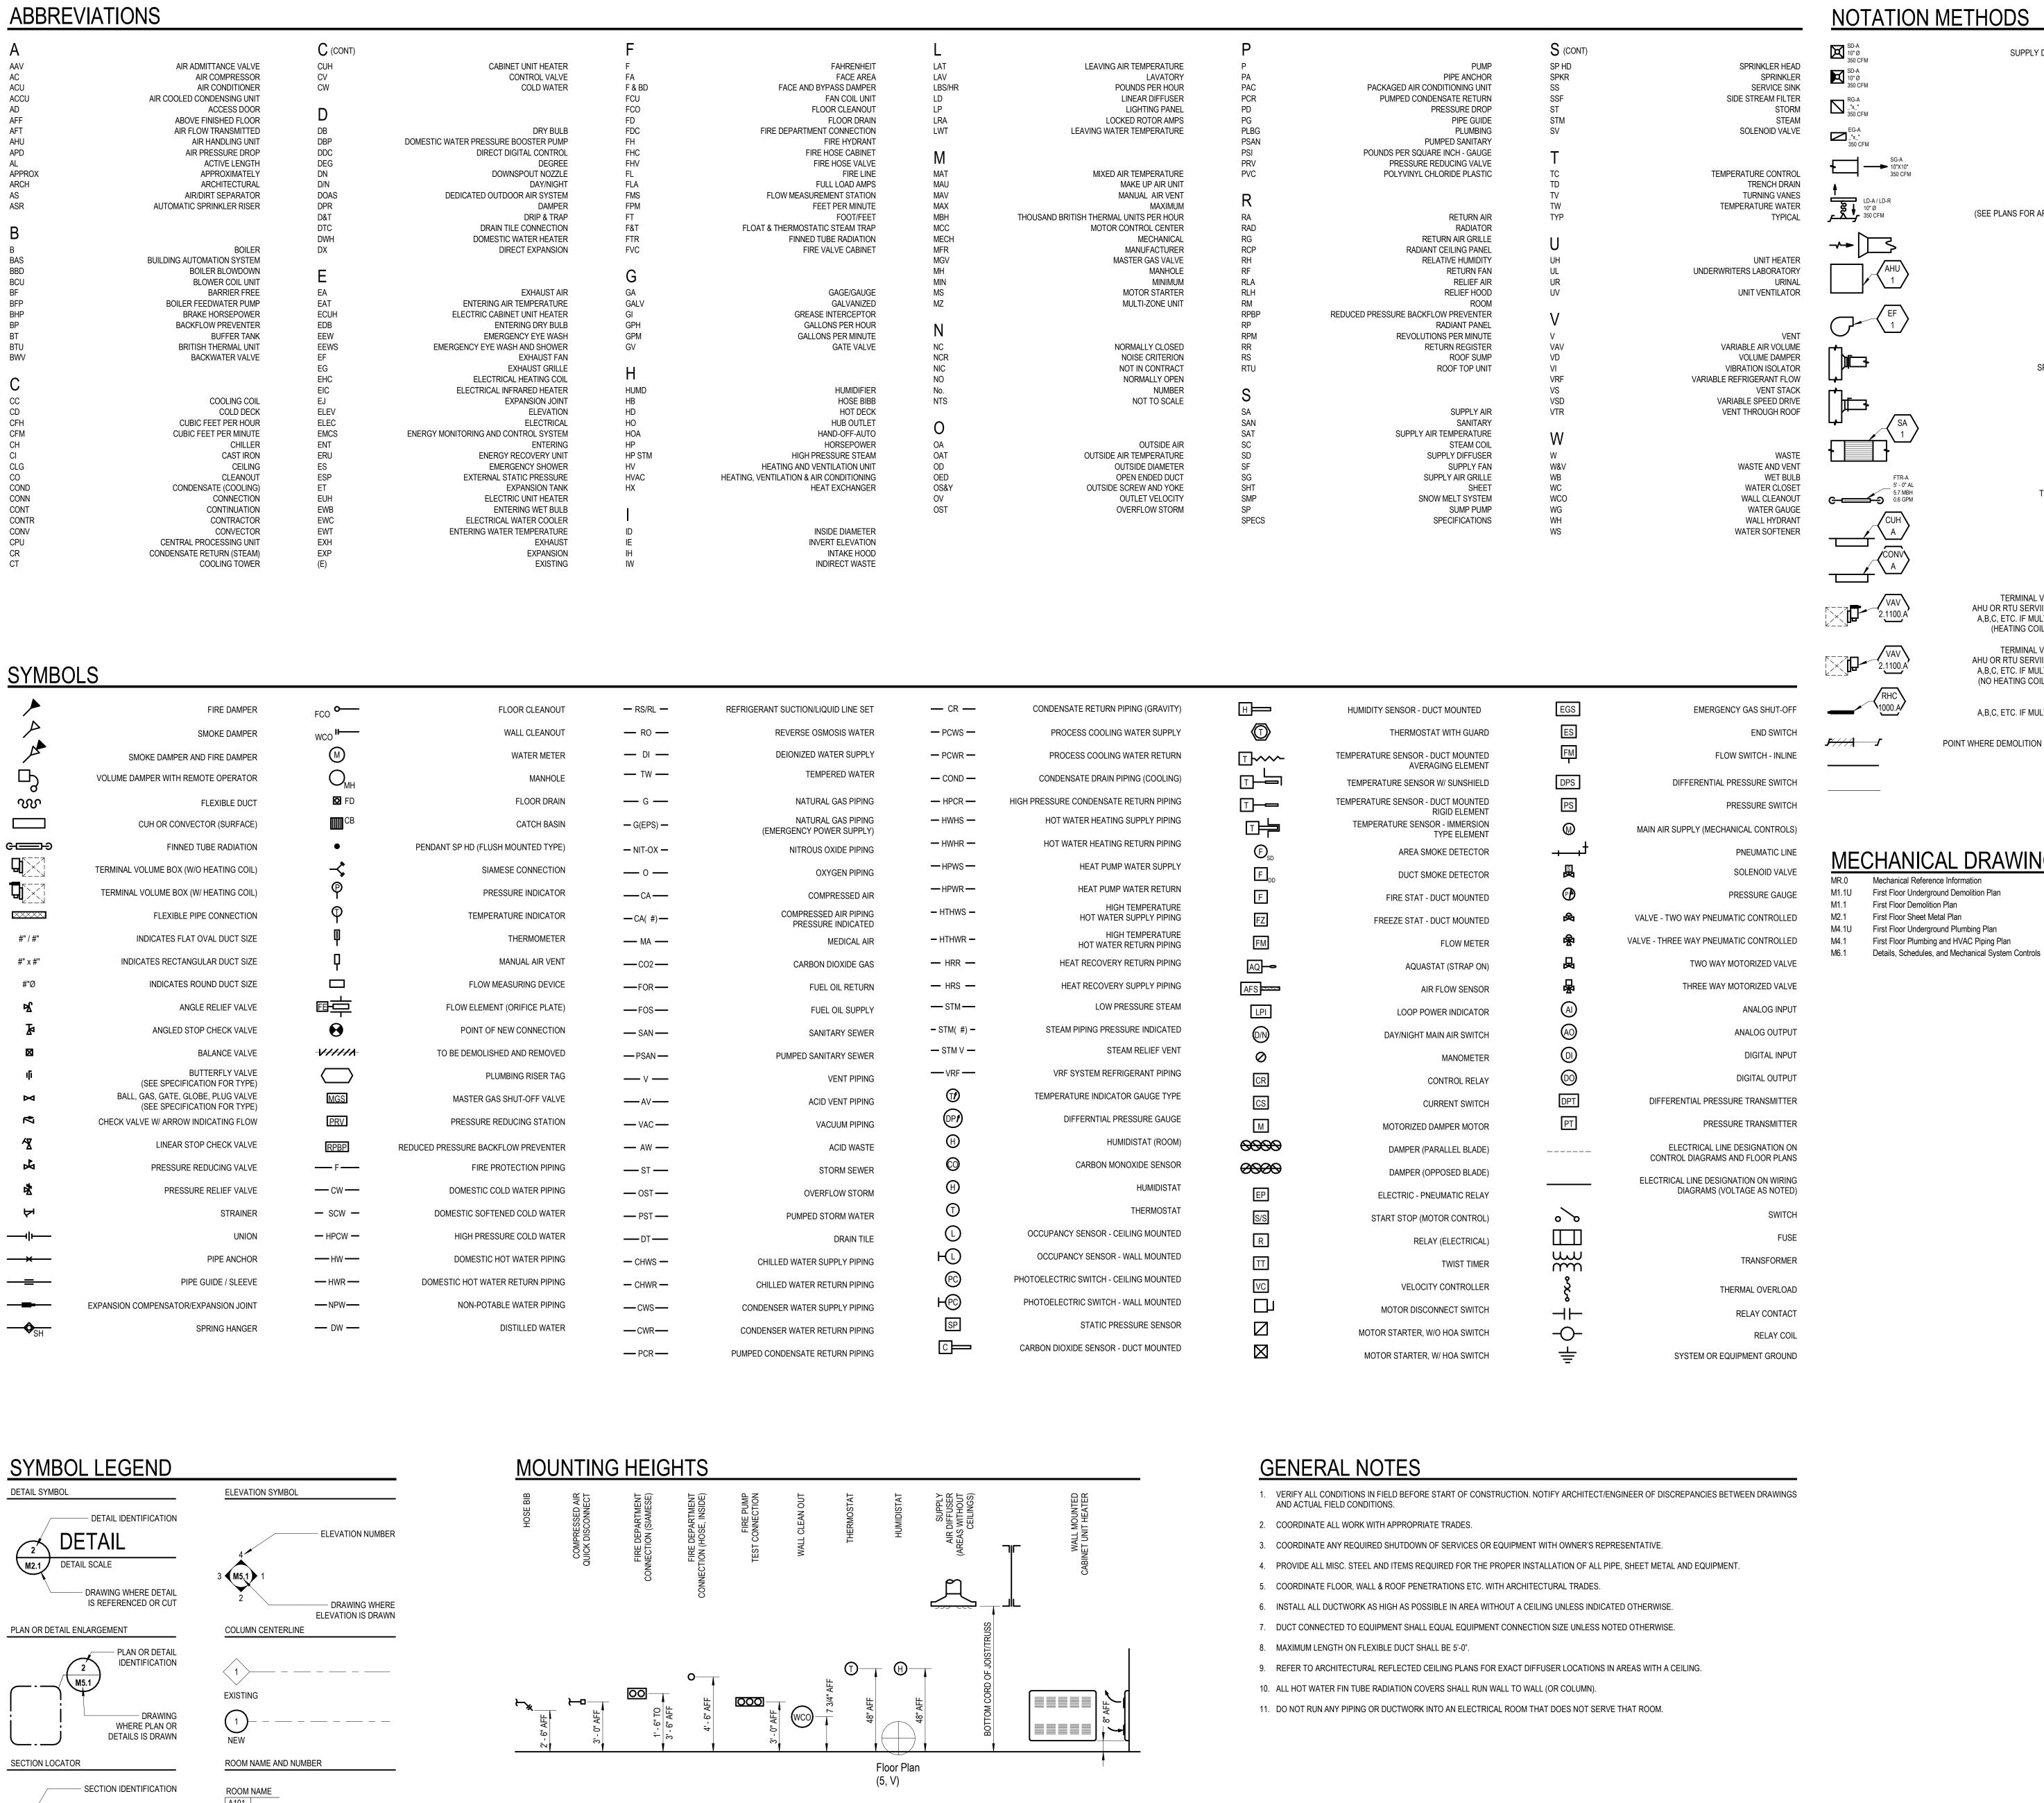AIR HANDLING UNIT No. 1

CONNECTION WITH VOLUME DAMPER SOUND ATTENUATOR FINNED TUBE RADIATION

SUPPLY DIFFUSER, TYPE 'A', 10" NECK, 350 CFM

SUPPLY DIFFUSER (3-WAY)

RETURN GRILLE, TYPE 'A', 350 CFM

EXHAUST GRILLE, TYPE 'A', 350 CFM

SUPPLY GRILLE, TYPE 'A', 350 CFM

LINEAR DIFFUSER, TYPE 'A' WITH

BELL MOUTH AIR INLET AREA SHALL

BE EQUAL TO '2' TIMES DUCT AREA

SPIN-IN FITTING WITH VOLUME DAMPER

RETURN AIR/EXHAUST AIR BRANCH

(SEE PLANS FOR ARROWS INDICATING FLOW DIRECTION)

FLEXIBLE DUCT CONNECTION

CABINET UNIT HEATER, TYPE 'A'

TYPE 'A', 5'-0" ELEMENT, 5.7 TOTAL MBH

(REFER TO EQUIPMENT SCHEDULES)

CONVECTOR, TYPE 'A' TERMINAL VARIABLE OR CONSTANT VOLUME BOX AHU OR RTU SERVIING THE VAV OR CAV. ROOM NUMBER. A,B,C, ETC. IF MULTIPLE COILS SERVE THE SAME SPACE

TERMINAL VARIABLE OR CONSTANT VOLUME BOX AHU OR RTU SERVIING THE VAV OR CAV. ROOM NUMBER. A,B,C, ETC. IF MULTIPLE COILS SERVE THE SAME SPACE (NO HEATING COIL, REFER TO EQUIPMENT SCHEDULES) REHEAT COIL, ROOM NUMBER A,B,C, ETC. IF MULTIPLE COILS SERVE THE SAME SPACE (REFER TO EQUIPMENT SCHEDULES)

(HEATING COIL, REFER TO EQUIPMENT SCHEDULES)

POINT WHERE DEMOLITION ENDS/POINT OF NEW CONSTRUCTION

NEW MECHANICAL

MECHANICAL DRAWING INDEX

First Floor Underground Demolition Plan First Floor Demolition Plan

First Floor Sheet Metal Plan

First Floor Underground Plumbing Plan First Floor Plumbing and HVAC Piping Plan Van Buren Public Schools

RAHS Belleville High School

501 W Columbia Ave Belleville, MI 48111

THIS PROJECT MAY NOT UTILIZE ALL THE SYMBOLS, MATERIALS, ABBREVIATIONS AND STANDARD INFORMATION SHOWN ON THIS

> Project Administrato A. Maurer Project Designer N. Moeggenborg Project Architect / Engineer N. Moeggenborg N. Moeggenborg Q.M. Review

> > J. Schwartz Drawing Scale No Scale Issue Date Issued for

Design Development 07-03-2024

 \circ 2024 Integrated $ext{design}$ solutions, LL

Mechanical Reference Information

ī**D**§ Project Number

Drawing Number

MR.0

24167-1000

M5.1

- DRAWING WHERE PLAN OR DETAILS IS DRAWN — BUILDING OR UNIT (IF ANY)

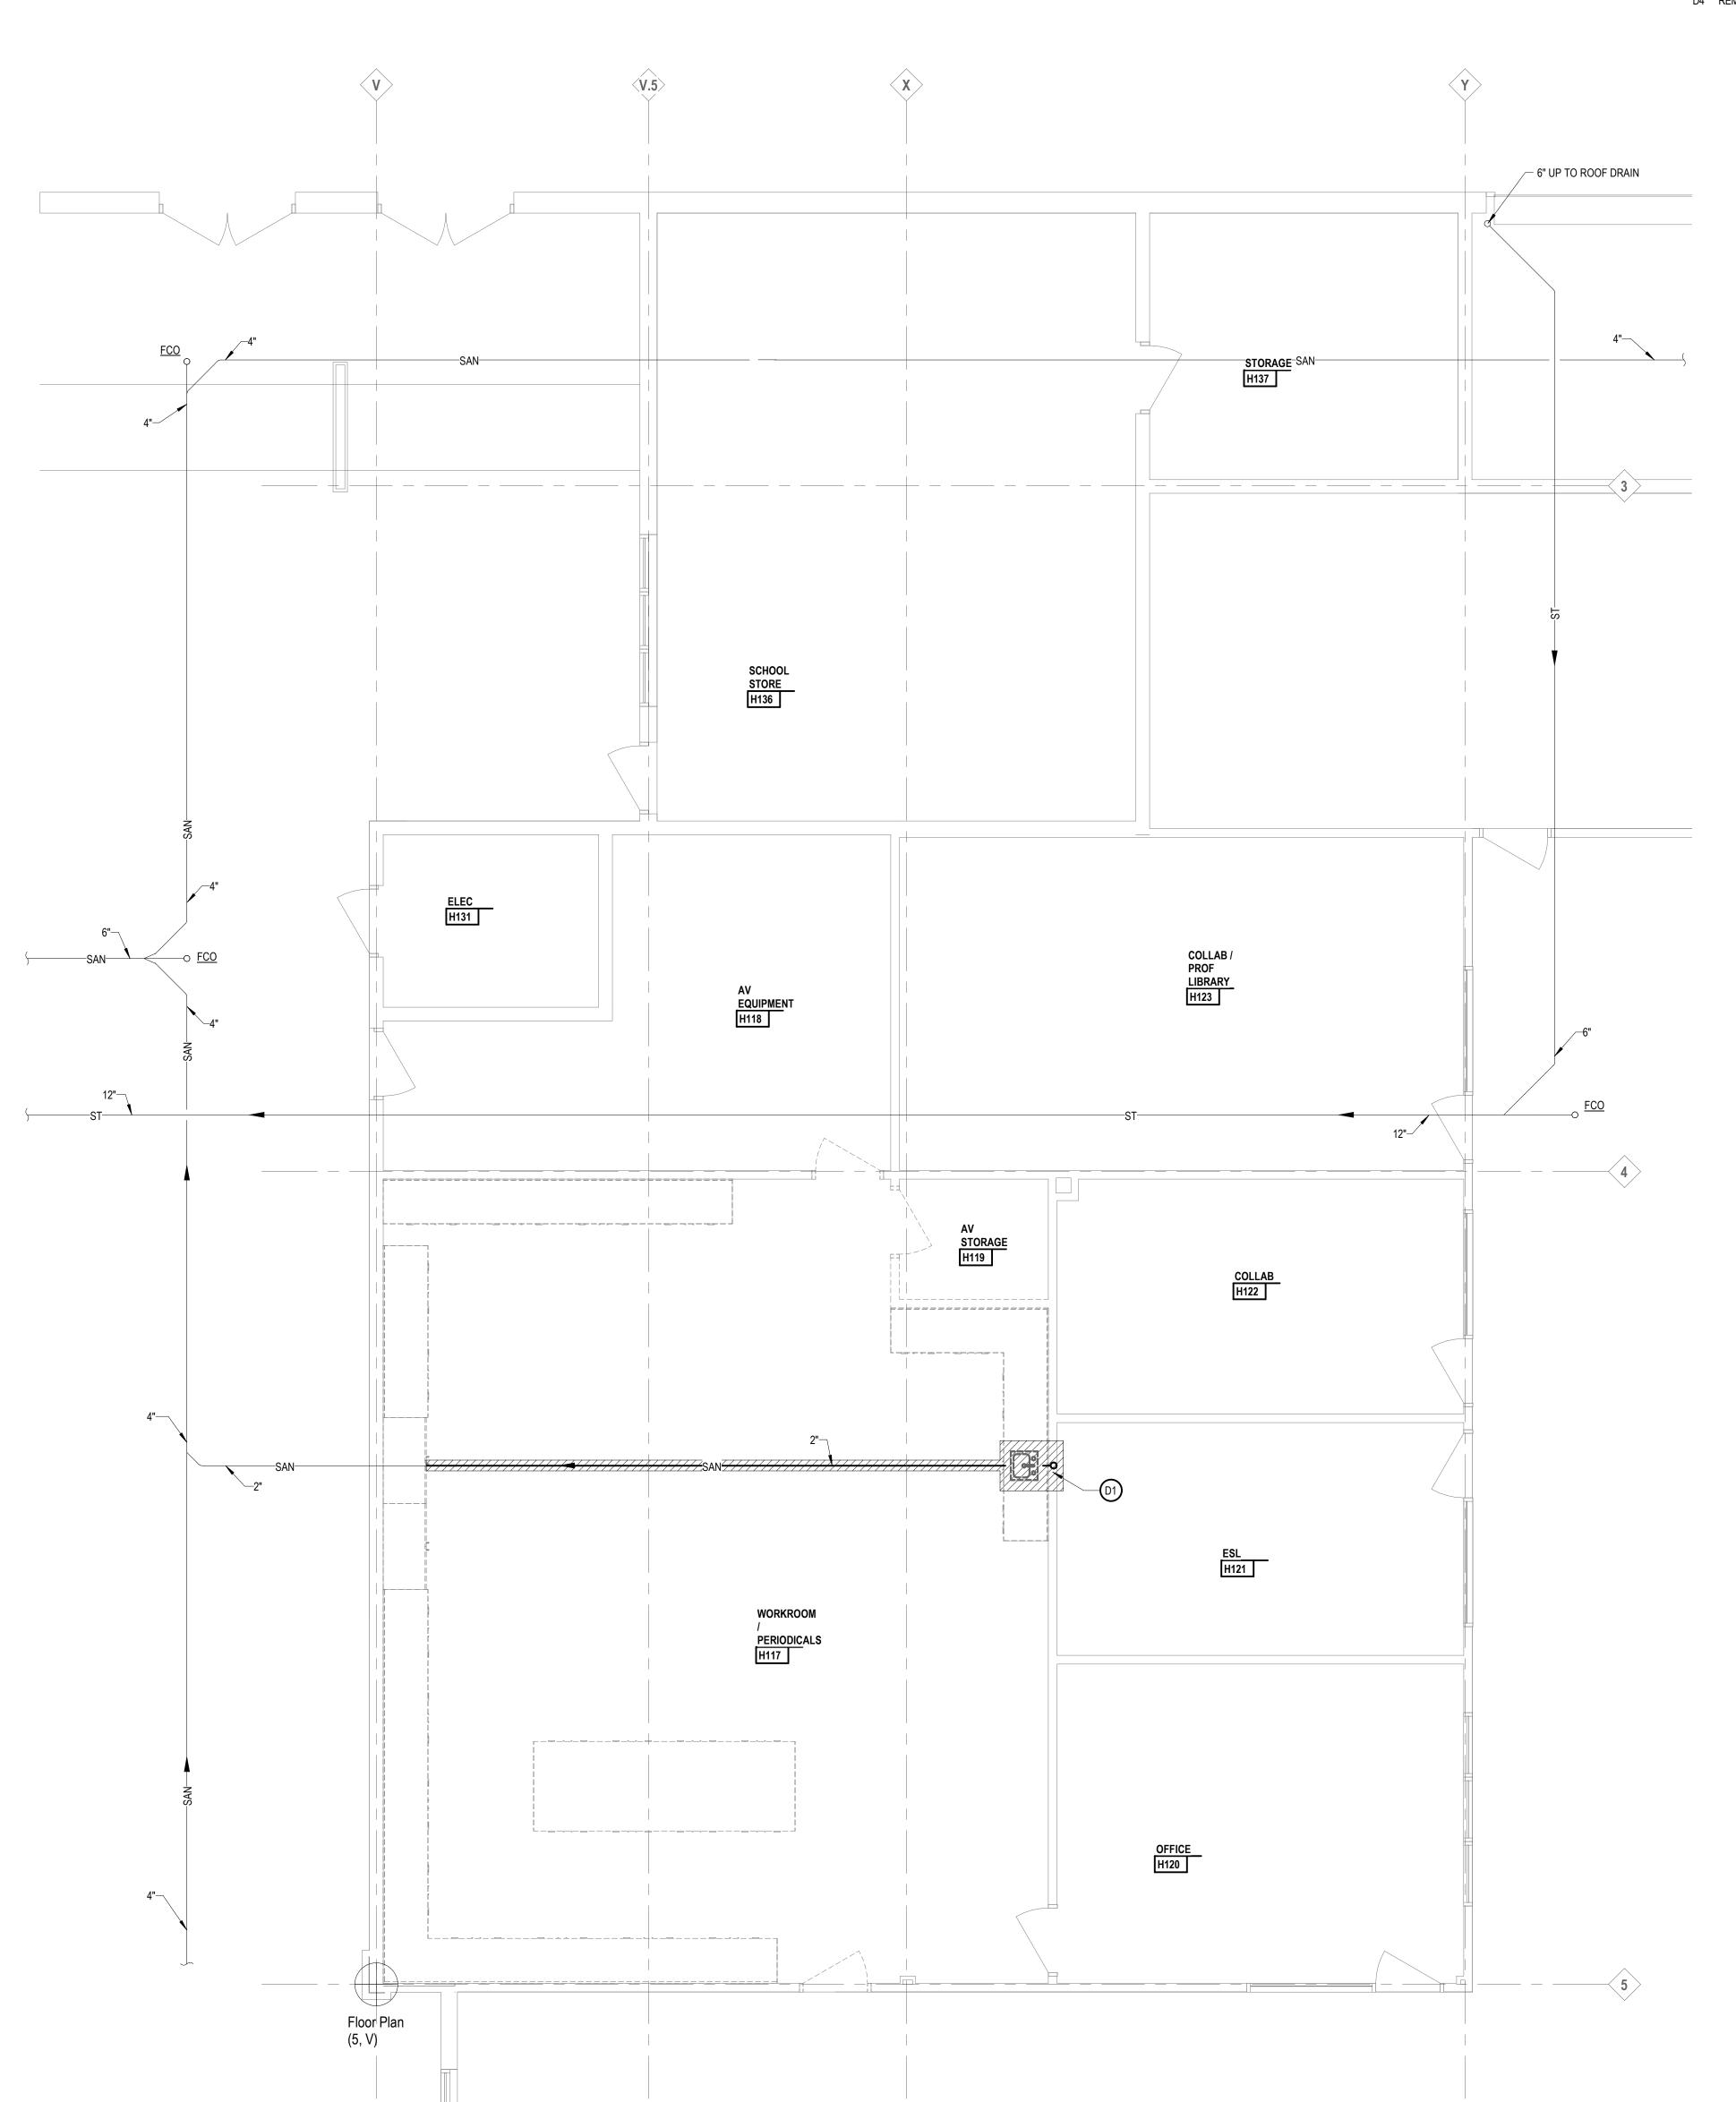
KEYNOTES DEMOLITION

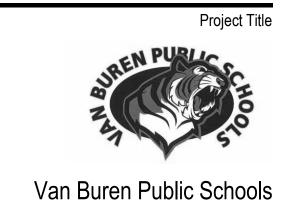
NOTE: NOT ALL KEYNOTES MAY BE USED # LEGEND SYMBOL INDICATOR

D1 REMOVE SANITARY PIPING AND CAP 2'-0" FROM WALL.

- D2 REMOVE SINK, COLD WATER, HOT WATER, SANITARY, AND VENT PIPING.
- D3 REMOVE SUPPLY DIFFUSER, ASSOCIATED DUCT WORK, AND COMPONENTS BACK TO MAIN
- D4 REMOVE RETURN GRILLE.








RAHS Belleville High School

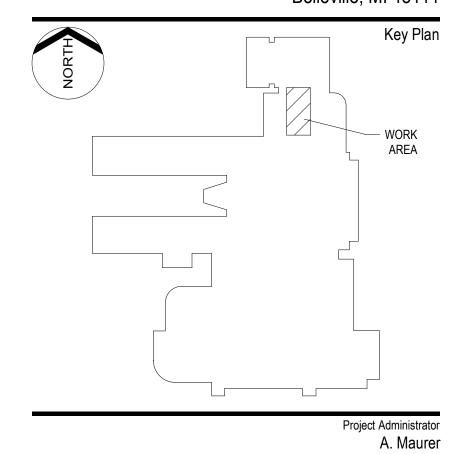501 W Columbia Ave Belleville, MI 48111



Project Designer
N. Moeggenborg
Project Architect / Engineer
N. Moeggenborg Drawn By
N. Moeggenborg Approved
J. Schwartz
Drawing Scale 1/4" = 1'-0" Issue Date Issued for Design Development 07-03-2024

 \circ 2024 Integrated design solutions, LLC IDS Drawing Title

First Floor Underground Demolition Plan

ī**D**§ Project Number

Drawing Number M1.1U


KEYNOTES DEMOLITION

NOTE: NOT ALL KEYNOTES MAY BE USED

LEGEND SYMBOL INDICATOR
D1 REMOVE SANITARY PIPING AND CAP 2'-0" FROM WALL.

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RAHS Belleville High School

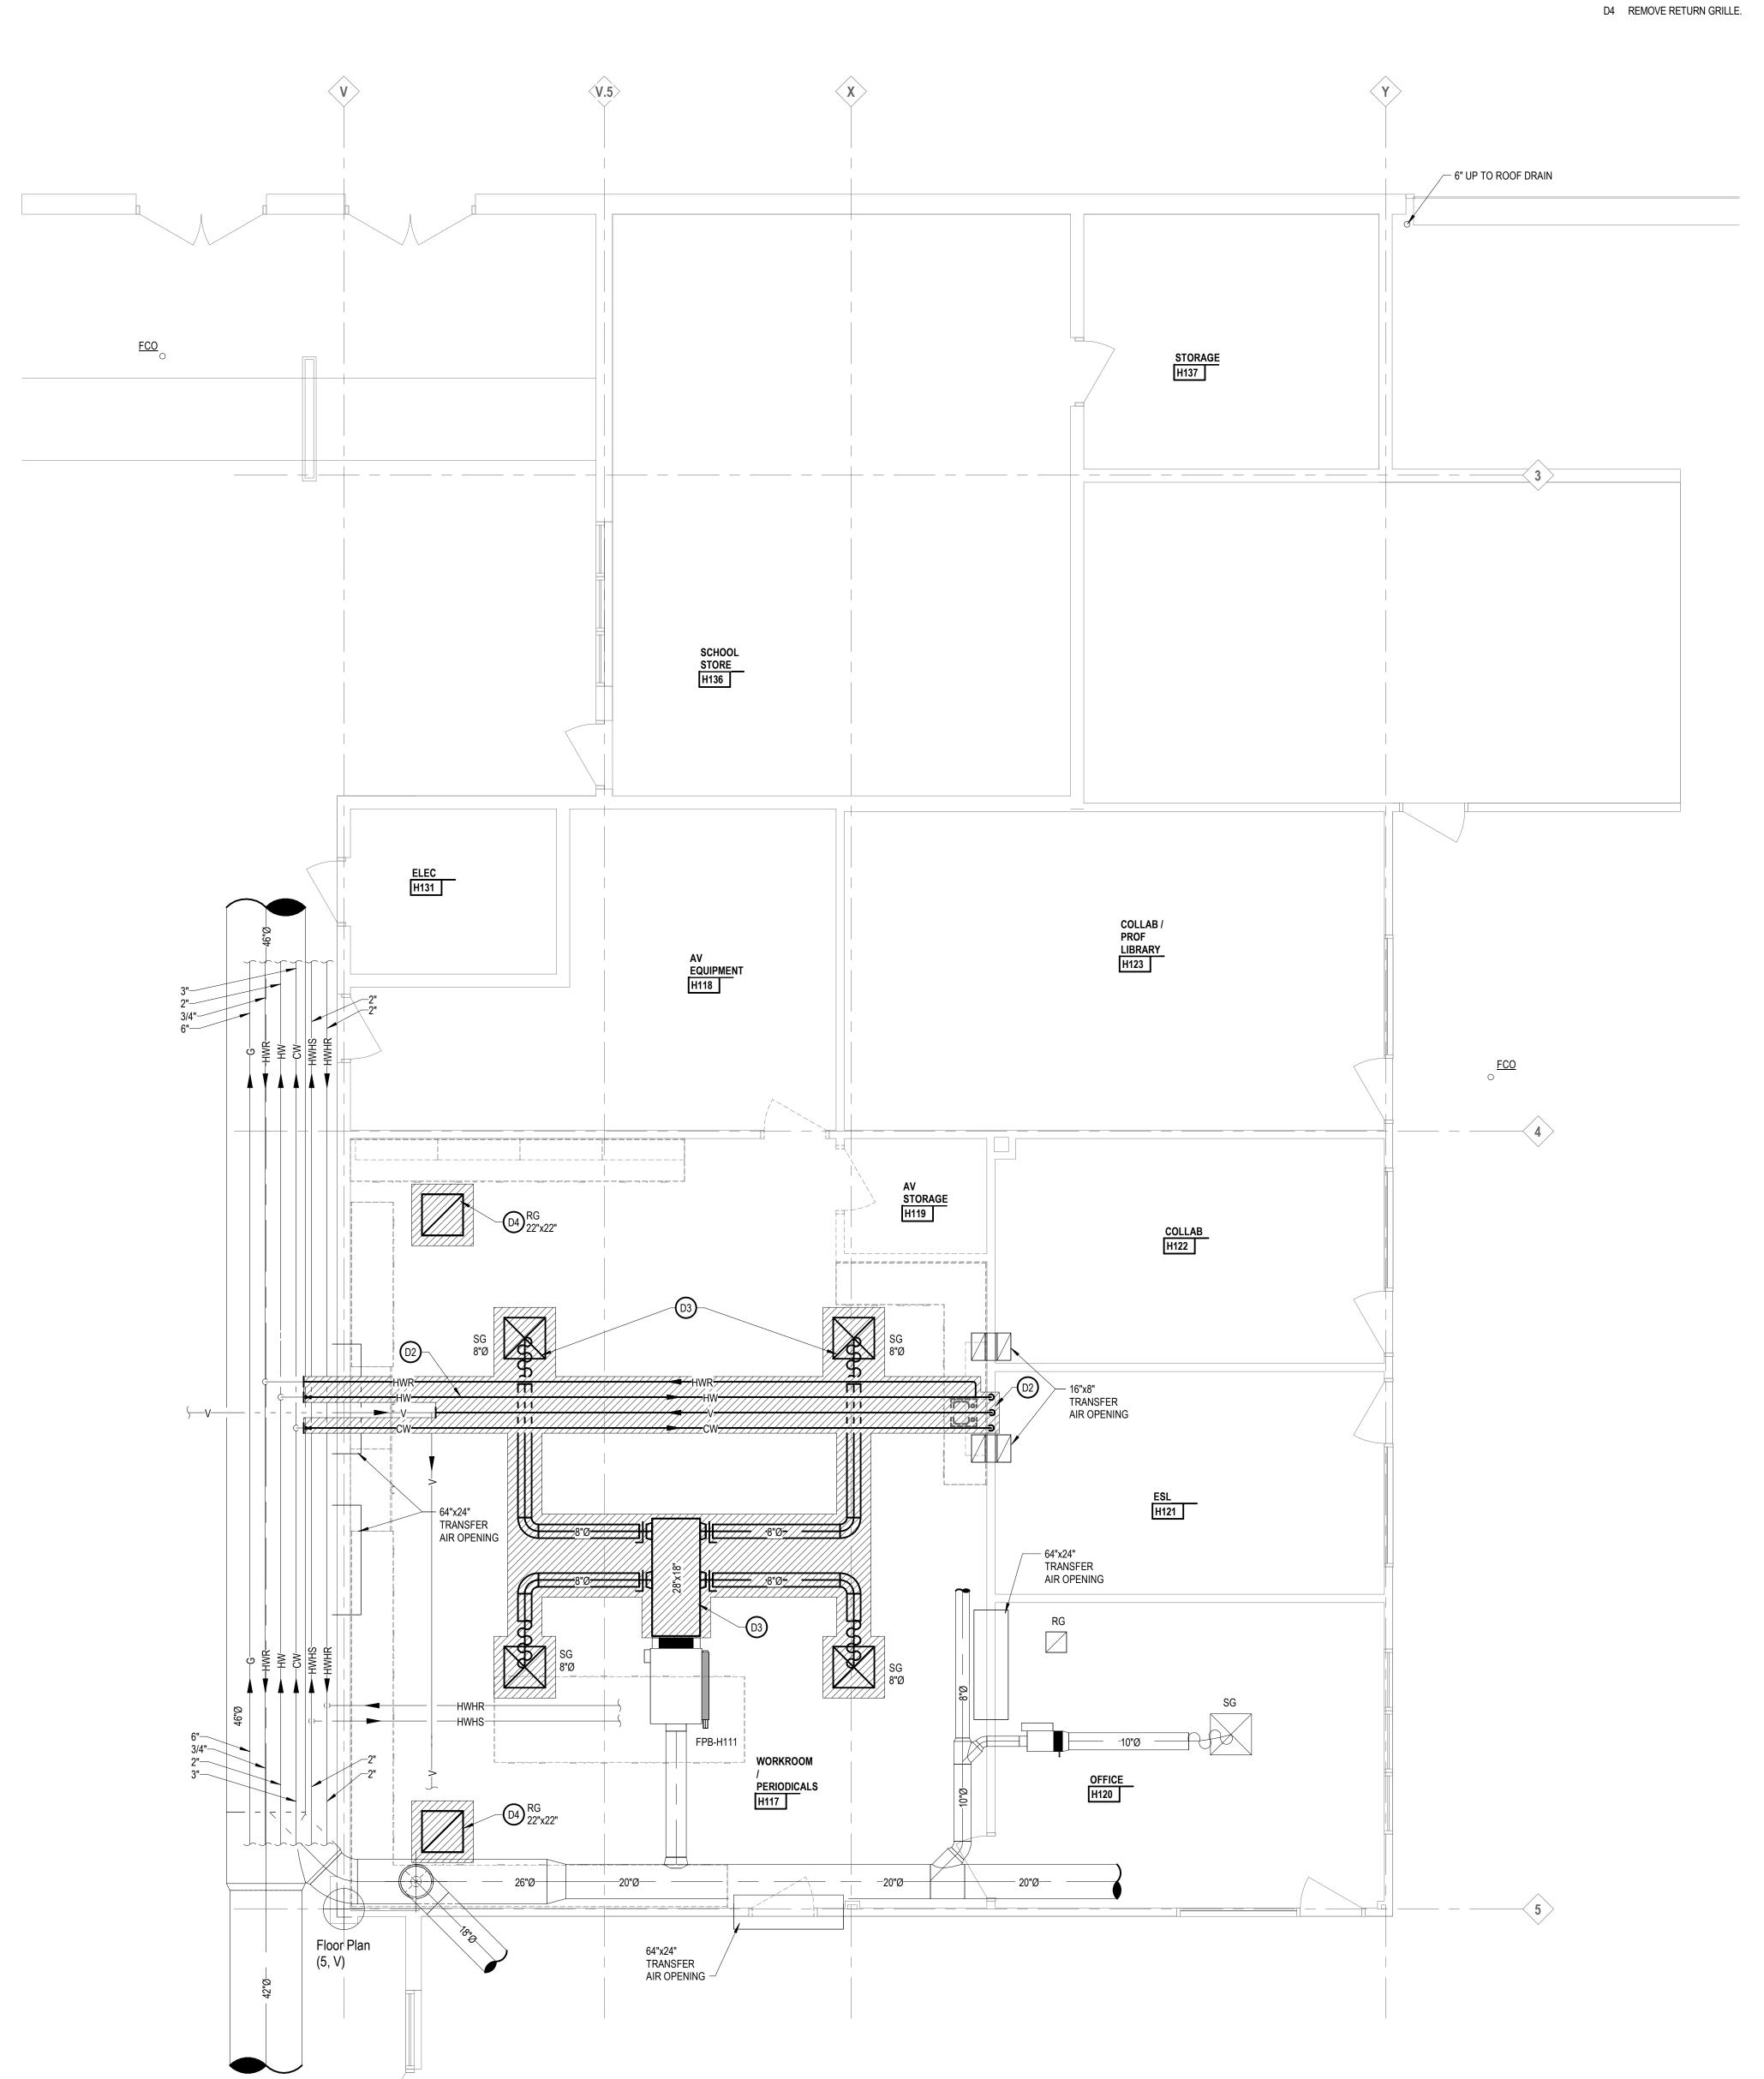Son W Columbia Ave Belleville, MI 48111

Key Plan

Work AREA

Pr	oject Administrator A. Maurer
N.	Project Designer Moeggenborg
•	Architect / Engineer Moeggenborg
N.	Drawn By Moeggenborg
	Q.M. Review
	Approved J. Schwartz
	Drawing Scale 1/4" = 1'-0"
Issued for	Issue Date
Design Development	07-03-2024

 \circ 2024 Integrated design solutions, LLC IDS Drawing Title

First Floor Demolition Plan

ī**D**§ Project Number

Drawing Number

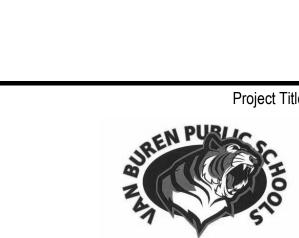
24167-1000

M1.1

1441 west long lake, suite 200 troy, michigan 48098

248.823.2100 www.ids-michigan.com

5211 cascade road SE, suite 300 grand rapids, michigan 49546



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501 W Columbia Ave Belleville, MI 48111

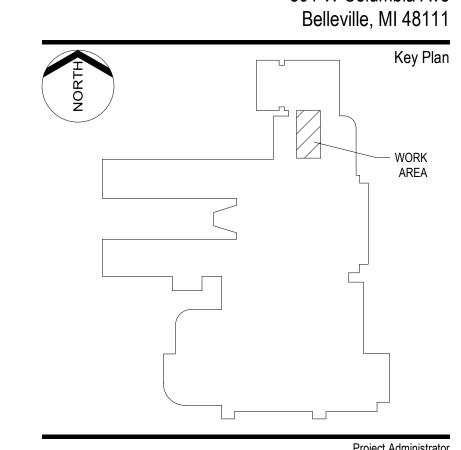
A. Maurer

Project Designer
N. Moeggenborg

Project Architect / Engineer
N. Moeggenborg

N. Moeggenborg

Van Buren Public Schools



Approved J. Schwartz Drawing Scale 1/4" = 1'-0" Issue Date Issued for Design Development 07-03-2024

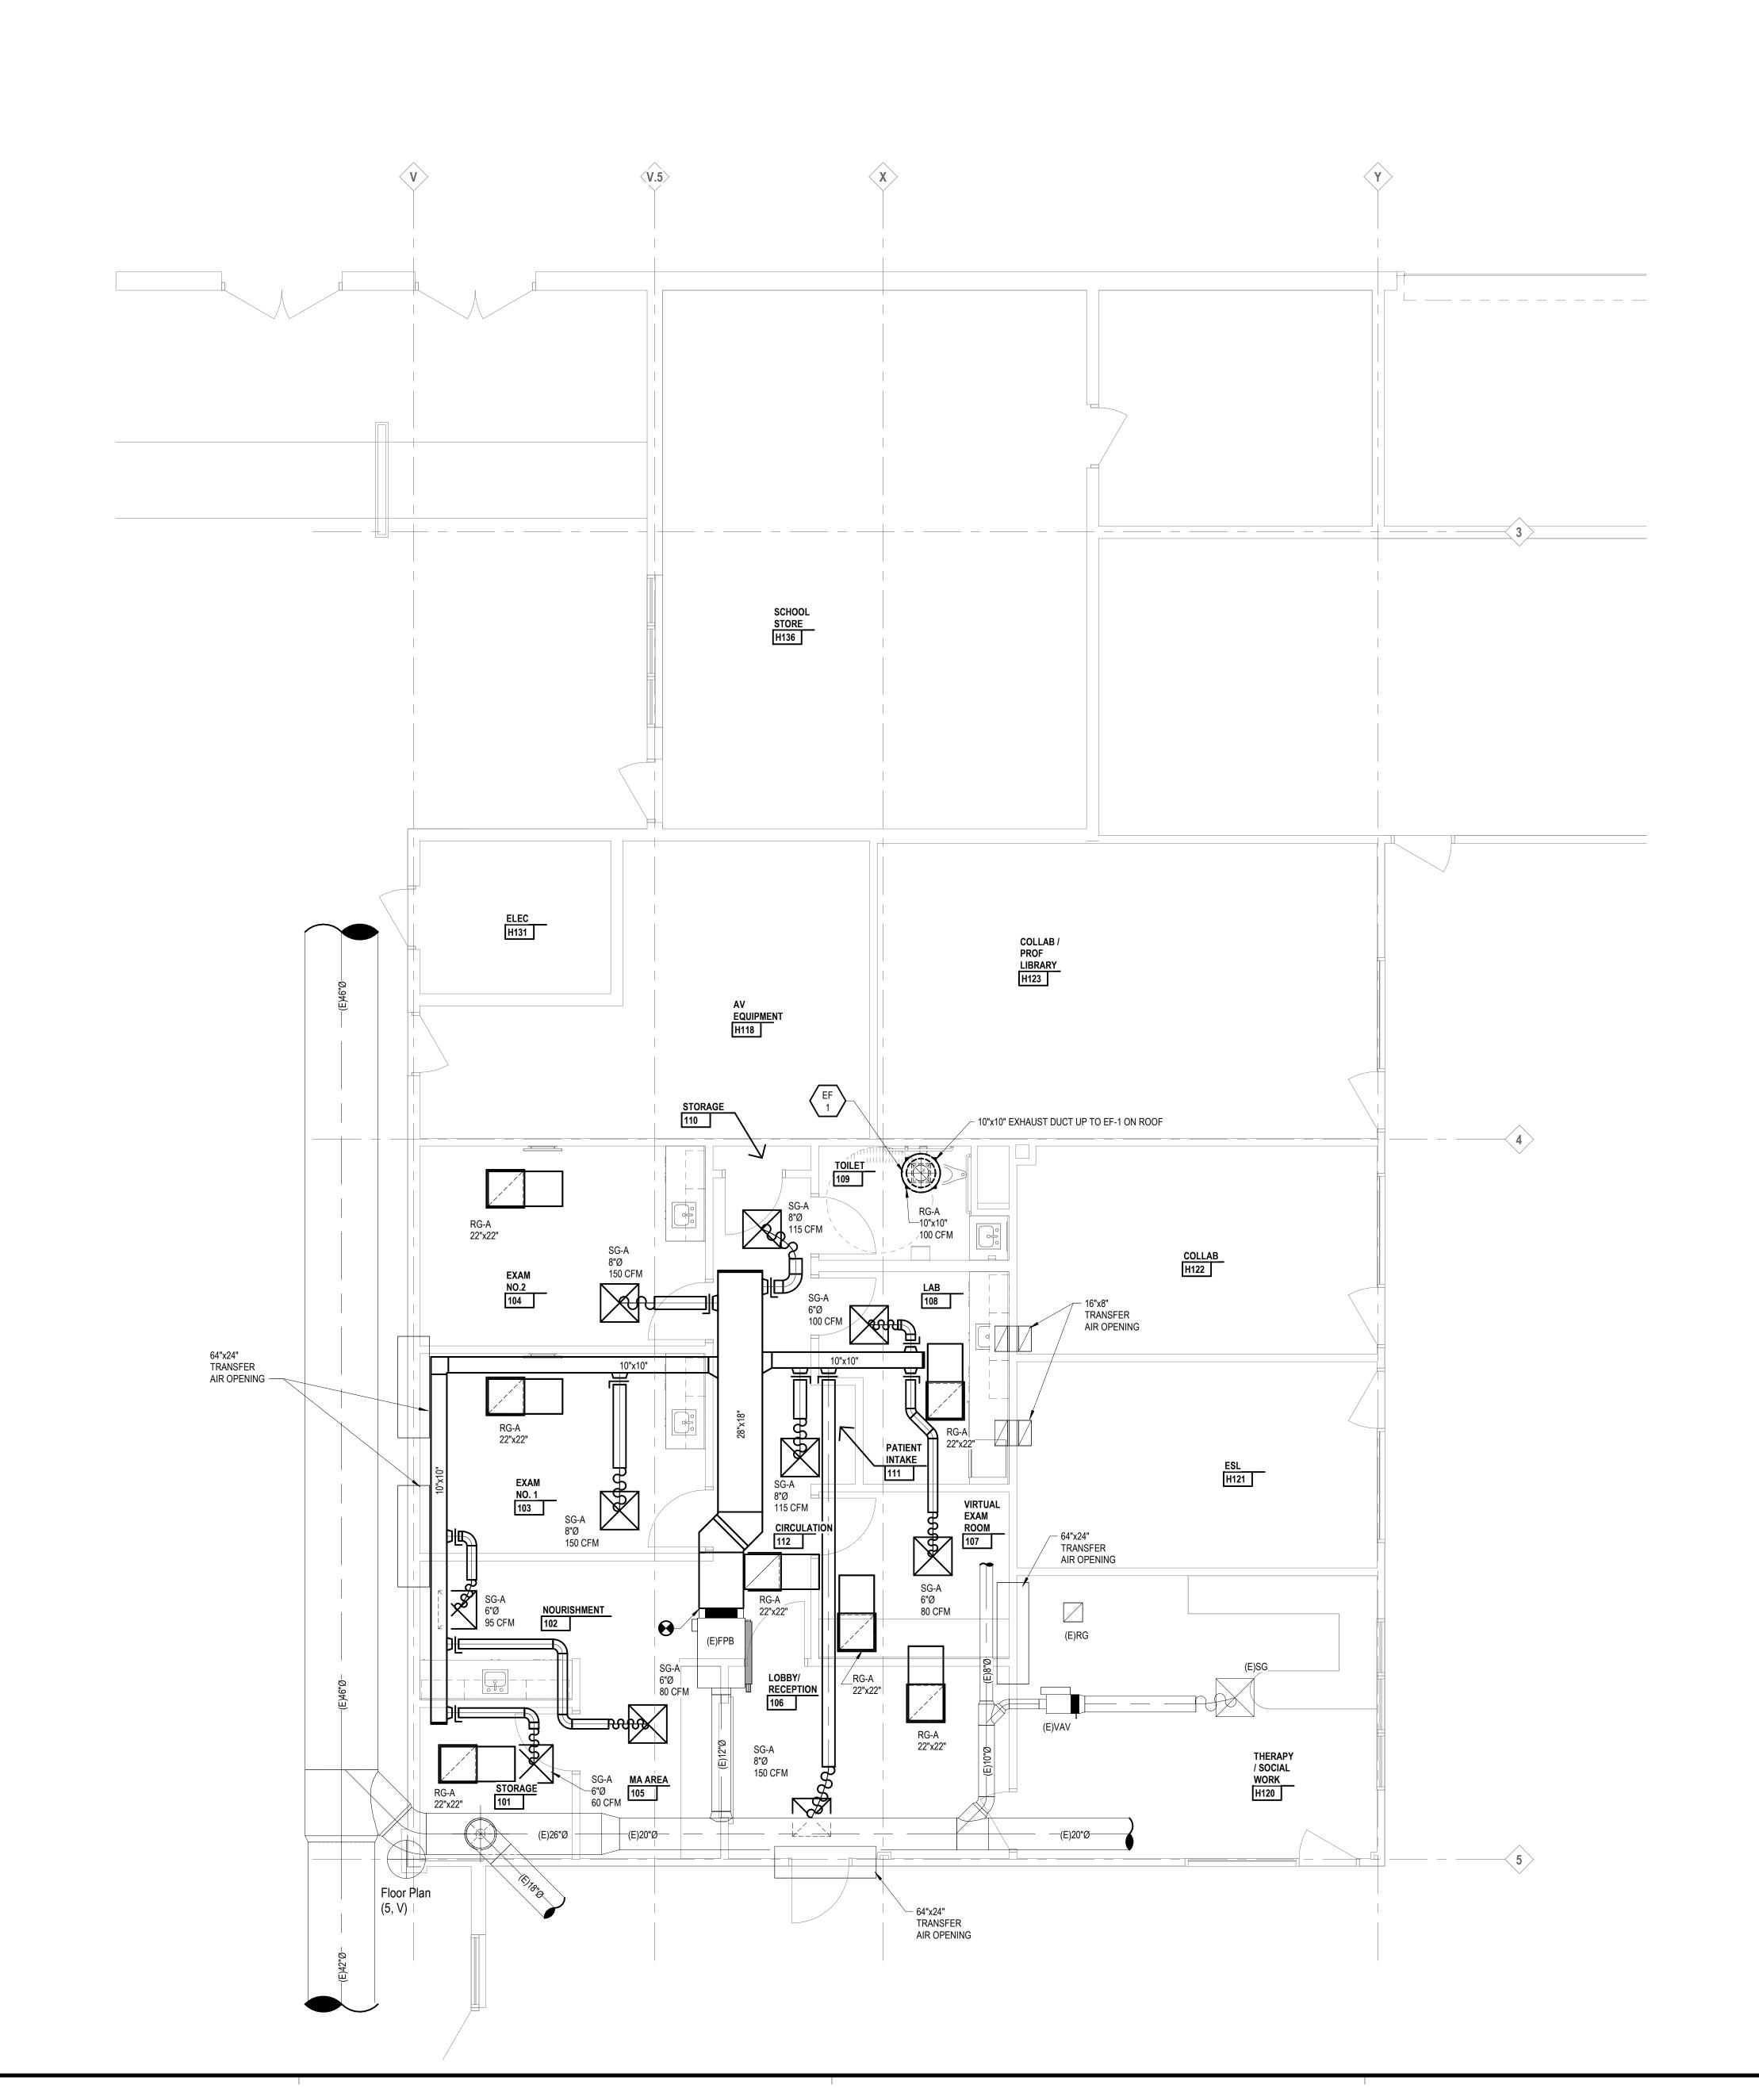
 \circ 2024 Integrated $ext{design}$ solutions, LLC

First Floor Sheet Metal Plan

ī**D**§ Project Number Drawing Number

24167-1000


M2.1



1441 west long lake, suite 200 troy, michigan 48098


> 248.823.2100 www.ids-michigan.com

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Approved
J. Schwartz

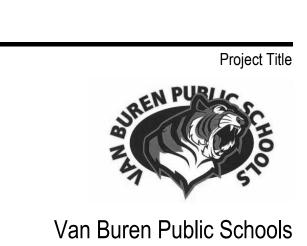Drawing Scale
1/4" = 1'-0"

Issued for Issue Date

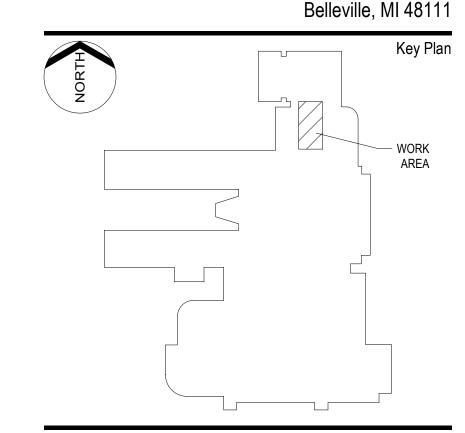Design Development 07-03-2024

Project Designer
N. Moeggenborg
Project Architect / Engineer
N. Moeggenborg

Drawn By
N. Moeggenborg

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First Floor Underground Plumbing Plan

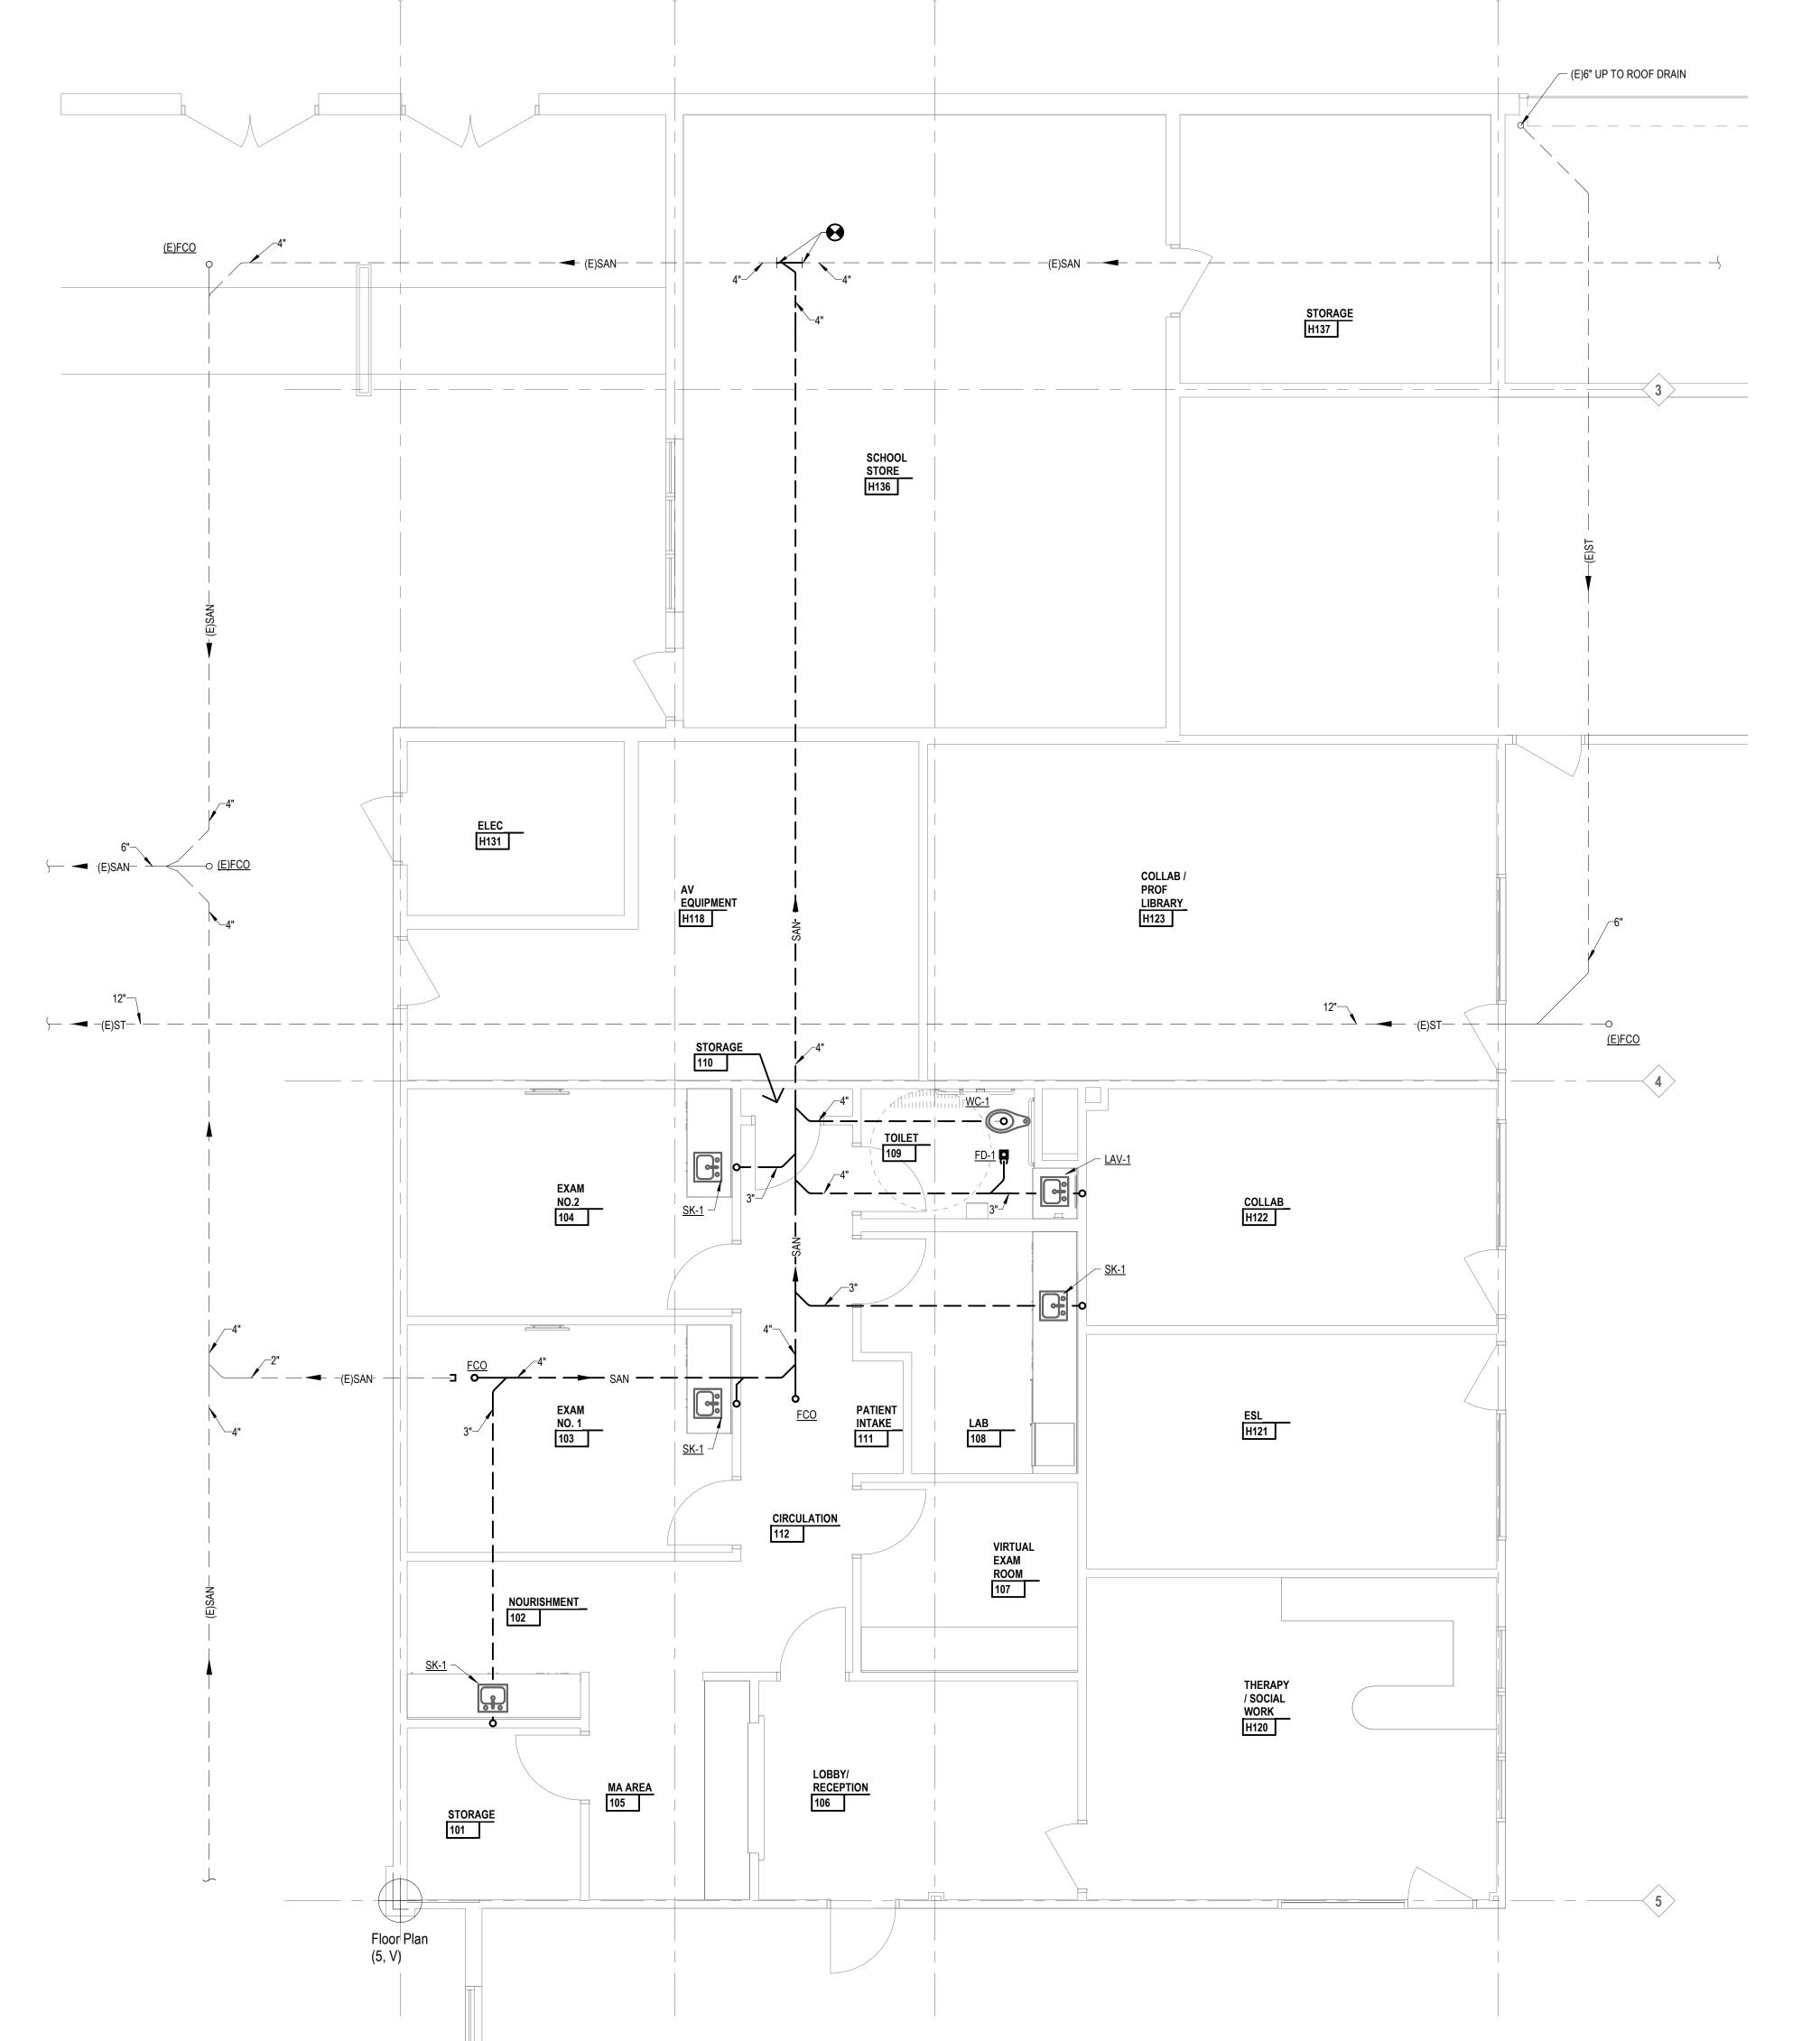
ī**D**§ Project Number

24167-1000

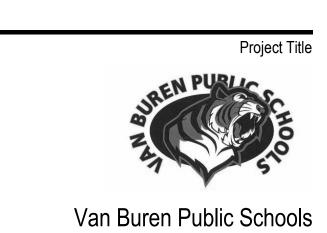
M4.1U

Drawing Number

(5, V)








RAHS Belleville High School

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Project Architect / Engineer
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Drawn By
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Approved
J. Schwartz
Drawing Scale
1/4" = 1'-0"

Issued for Issue Date
Design Development 07-03-2024


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First Floor Plumbing and HVAC Piping Plan

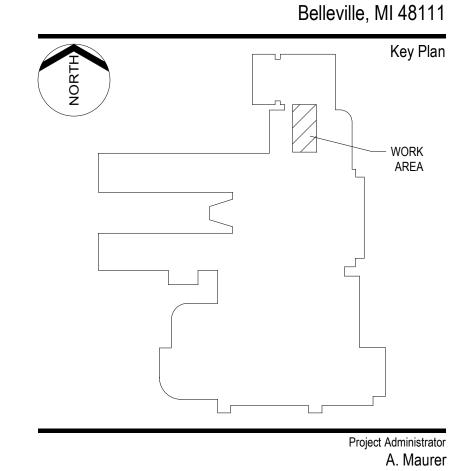ī**D**§ Project Number

24167-1000

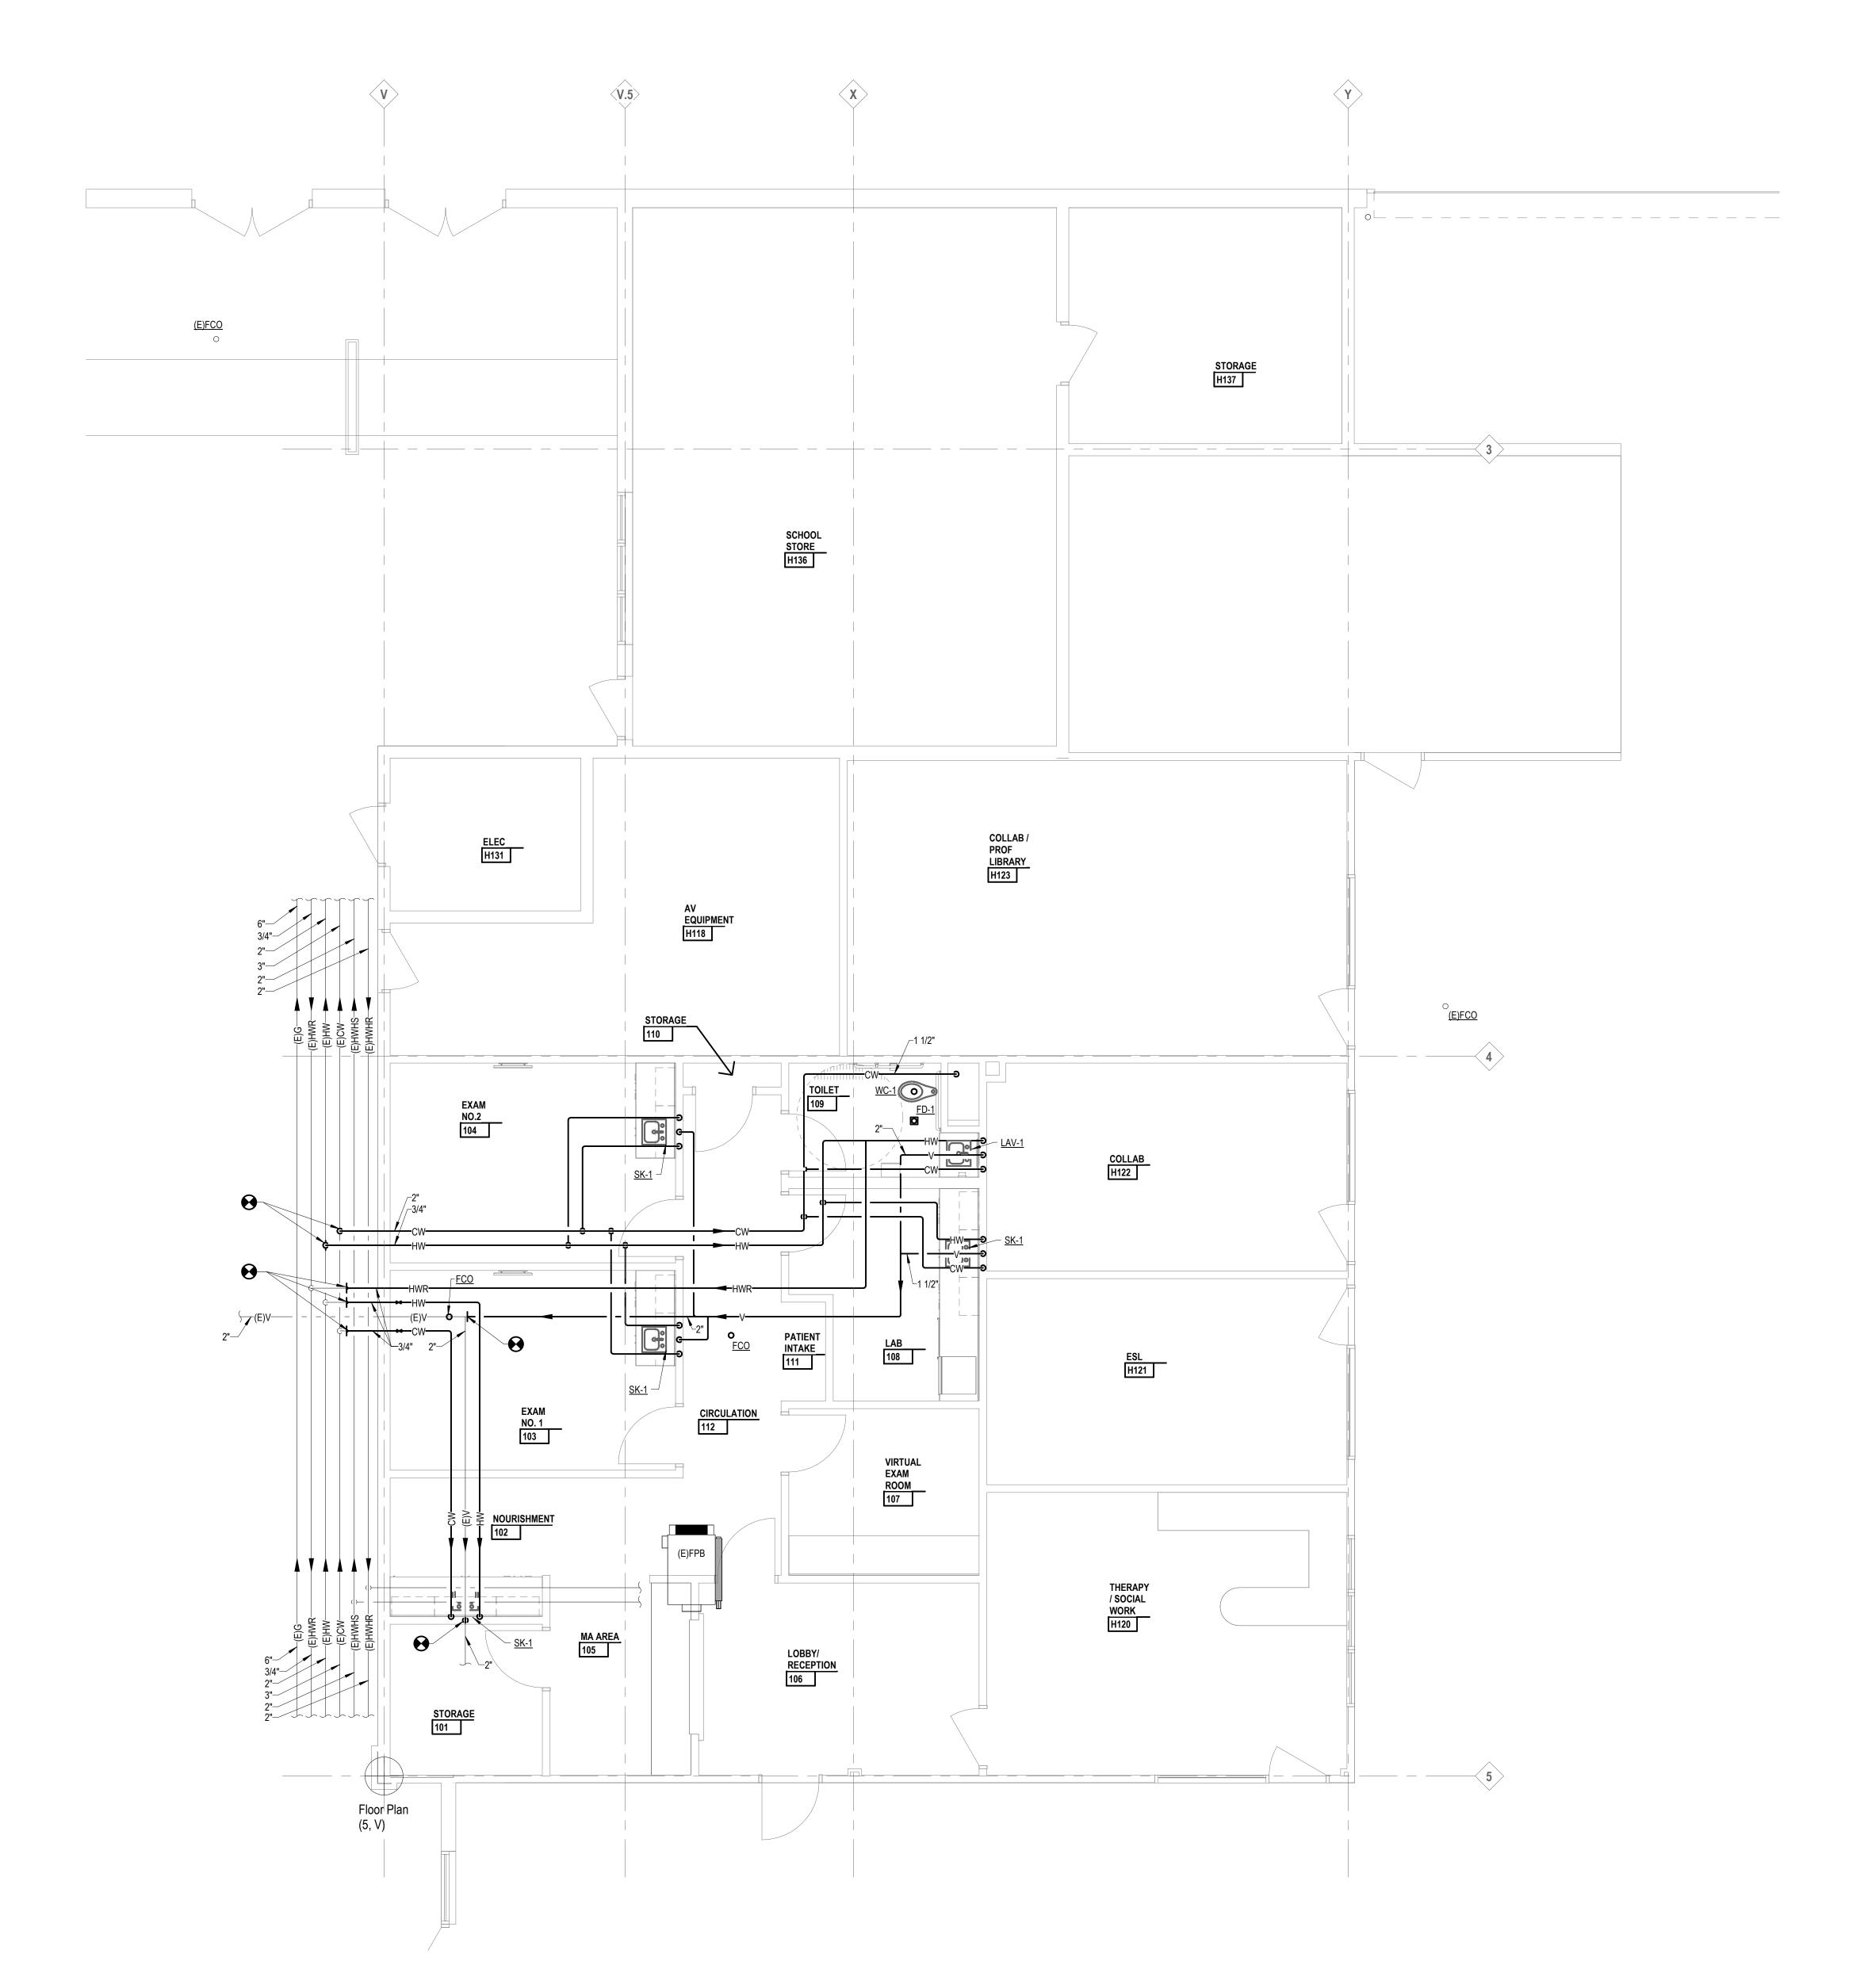M4.1



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GRILLE, REGISTER AND DIFFUSER SCHEDULE										
MARK	CORE STYLE	BORDER FRAME TYPE	MODULE SIZE	FINISH	ACCESSORY	CONSTRUCTION	"PRICE" MODEL No.	REMARKS		
SD-A	PANEL	NOTE 1	24"x24"	WHITE	NONE	STEEL	SPD			
RG-A	PERFORATED	NOTE 1	24"x24"	WHITE	NONE	STEEL	PDDR			
EG-A	PERFORATED	NOTE 1	24"x24"	WHITE	NONE	STEEL	PDDR			

MINERAL WALL INSULATION

1. COORDINATE MOUNTING FRAMES WITH REFLECTED CEILING PLANS.

2. ALL WALL AND DUCT MOUNTED GRILLES SHALL HAVE COUNTER-SUNK SCREWS.

- CALCIUM SILICATE

INSULATION. SAME

LENGTH AS SADDLE

SINGLE PIPE SUPPORT (LESS THAN 4")

GAUGE:

TYPICAL DUCT TRANSITION

1. PROVIDE GALVANIZED SHEET METAL INSULATION JACKET AS FOLLOWS:

PROVIDE MINIMUM 1'-0" STRAIGHT DUCT LENGTH

ASSEMBLY BOTH

COIL/ FILTER TO BE

EQUIVALENT. -

SPIN-IN FITTING

FLANGED TYPE WITH

NEOPRENE GASKET OR

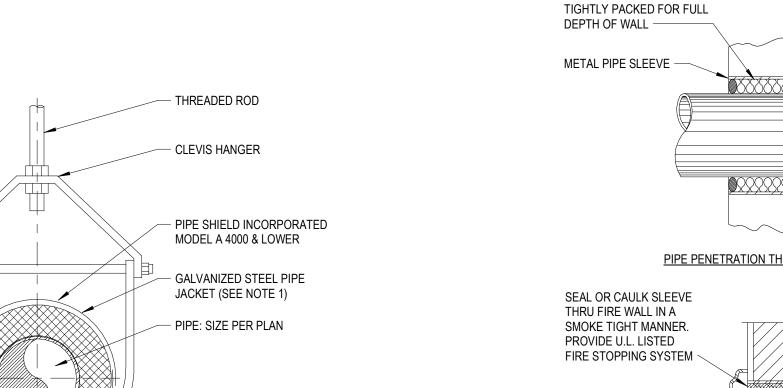
UPSTREAM AND DOWNSTREAM.

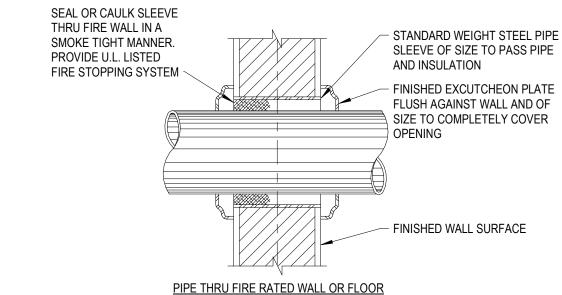
SAME SIZE AS COIL/ FILTER

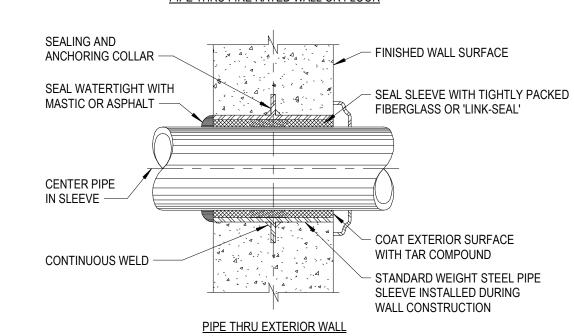
NOTES:

2" TO 4"

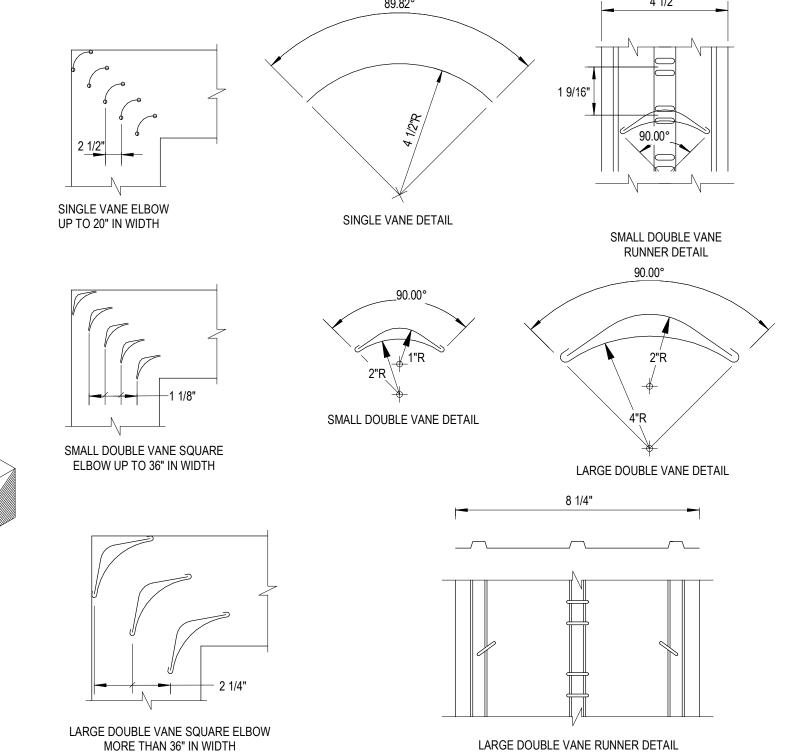
3. SG-B & SG-C FRONT BLADES PARALLEL TO SHORT DIMENSION. 4. COORDINATE LENGTH OF ALL LINEAR SUPPLIES AND RETURNS WITH ARCHITECTURAL FLOOR PLANS AND REFLECTED CEILING PLANS.











SQUARE AND RECTANGULAR ELBOWS - LOW **VELOCITY**

PROOF CAULK PIPE PENETRATION THRU NON-FIRE RATED WALL

SEAL BOTH SIDES WITH

NON-HARDENING WATER

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Van Buren Public Schools

Project Administrator A. Maurer Project Designer N. Moeggenborg Project Architect / Engineer N. Moeggenborg N. Moeggenborg Q.M. Review J. Schwartz Drawing Scale No Scale Issue Date Issued for

Design Development 07-03-2024


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Details, Schedules, and Mechanical System

ī**D**§ Project Number

Drawing Number

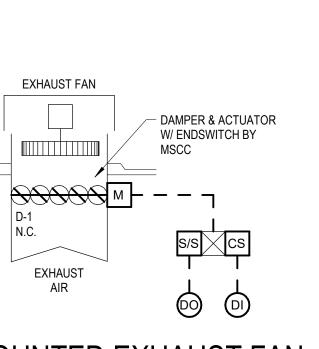
24167-1000




ROOF MOUNTED EXHAUST FAN **CONTROL DIAGRAM**

SEQUENCE OF OPERATION

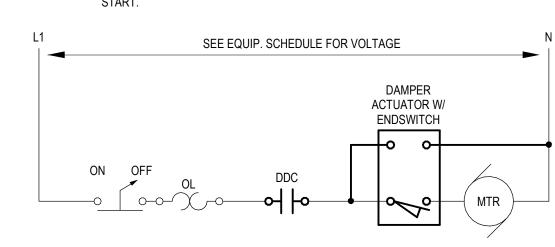1. THE EF SHALL BE SET TO ACTIVATE AND DEACTIVATE ACCORDING TO THE SET OPERATION TIME SCHEDULE FOR OCCUPIED AND UNOCCUPIED TIME 2. WHEN THE FAN IS ENABLED, THE ISOLATION DAMPER SHALL OPEN. ONCE THE DAMPER ENDSWITCH VERIFIES THE DAMPER HAS OPENED, THE FAN SHALL



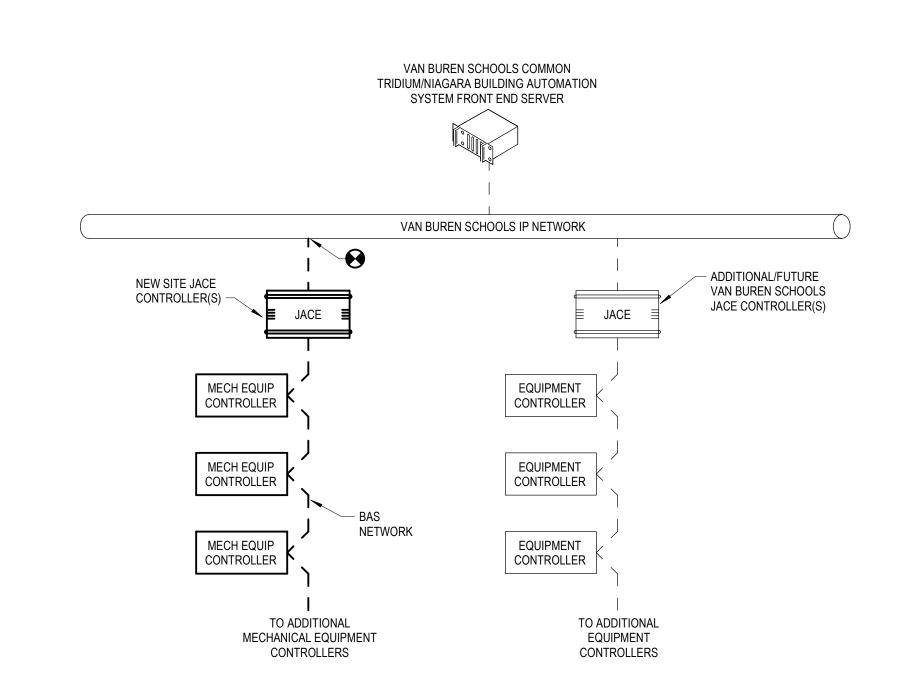
TYPICAL SINGLE PHASE EXHAUST FAN WIRING DETAIL




BUILDING AUTOMATION SYSTEM NETWORK RISER DIAGRAM

NOTES

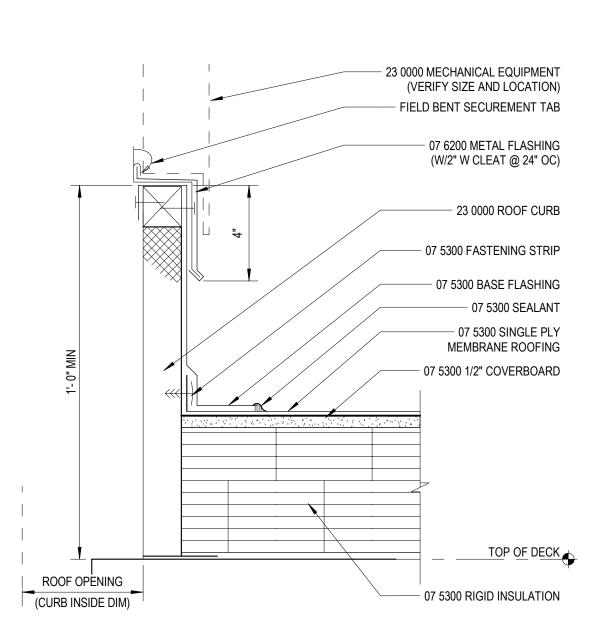
1. THE MECHANICAL SYSTEMS CONTROLS CONTRACTOR (MSCC) SHALL PROVIDE A NEW BUILDING AUTOMATION SYSTEM (BAS) JACE CONTROLLER AND/OR GATEWAY/INTEGRATION DEVICE OR DEVICES, POWER SUPPLIES, AND NEMA 1 ENCLOSURES AS NECESSARY TO INTEGRATE ALL FIELD DEVICES AND DEVICE NETWORKS TO THE COMMON VAN BUREN SCHOOLS TRIDIUM BUILDING AUTOMATION SYSTEM (BAS) FRONT END SERVER. PROVIDE ETHERNET IP DATA CONNECTION(S) AND LOCATE DEVICE(S) AS NECESSARY IN COORDINATION WITH THE ELECTRICAL/TECHNOLOGY CONTRACTOR AND



ROOF CURB SINGLE PLY MEMBRANE ROOFING

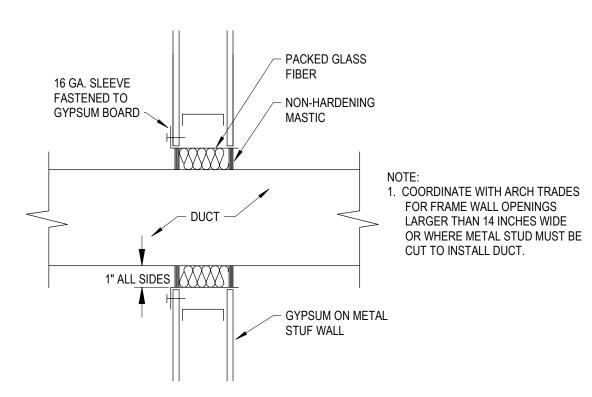

DUCT SEAL AT NON-RATED WALLS

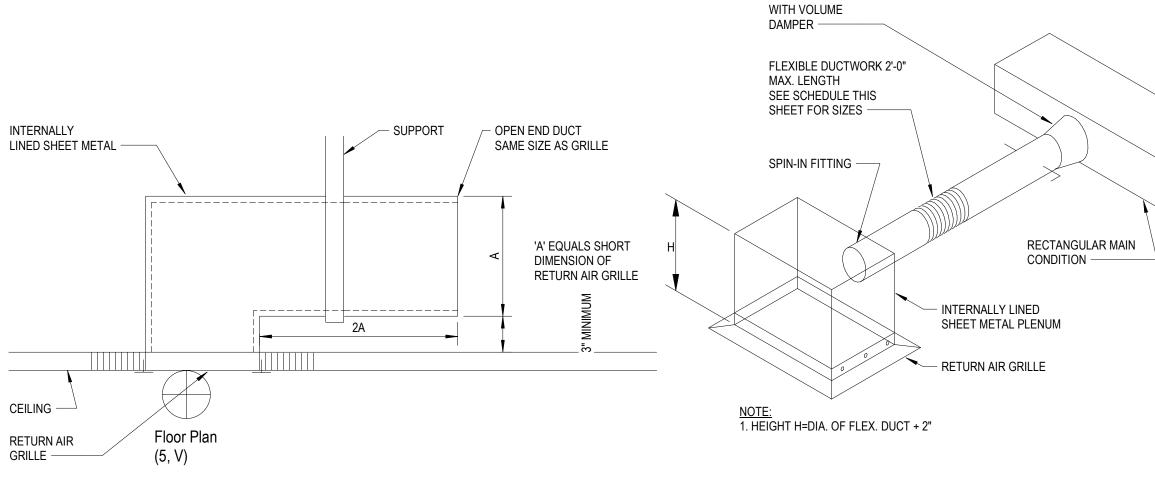


TYPICAL CEILING RETURN AIR GRILLE SOUND TRAP

RETURN & EXHAUST AIR GRILLE

BRANCH CONNECTION DETAIL

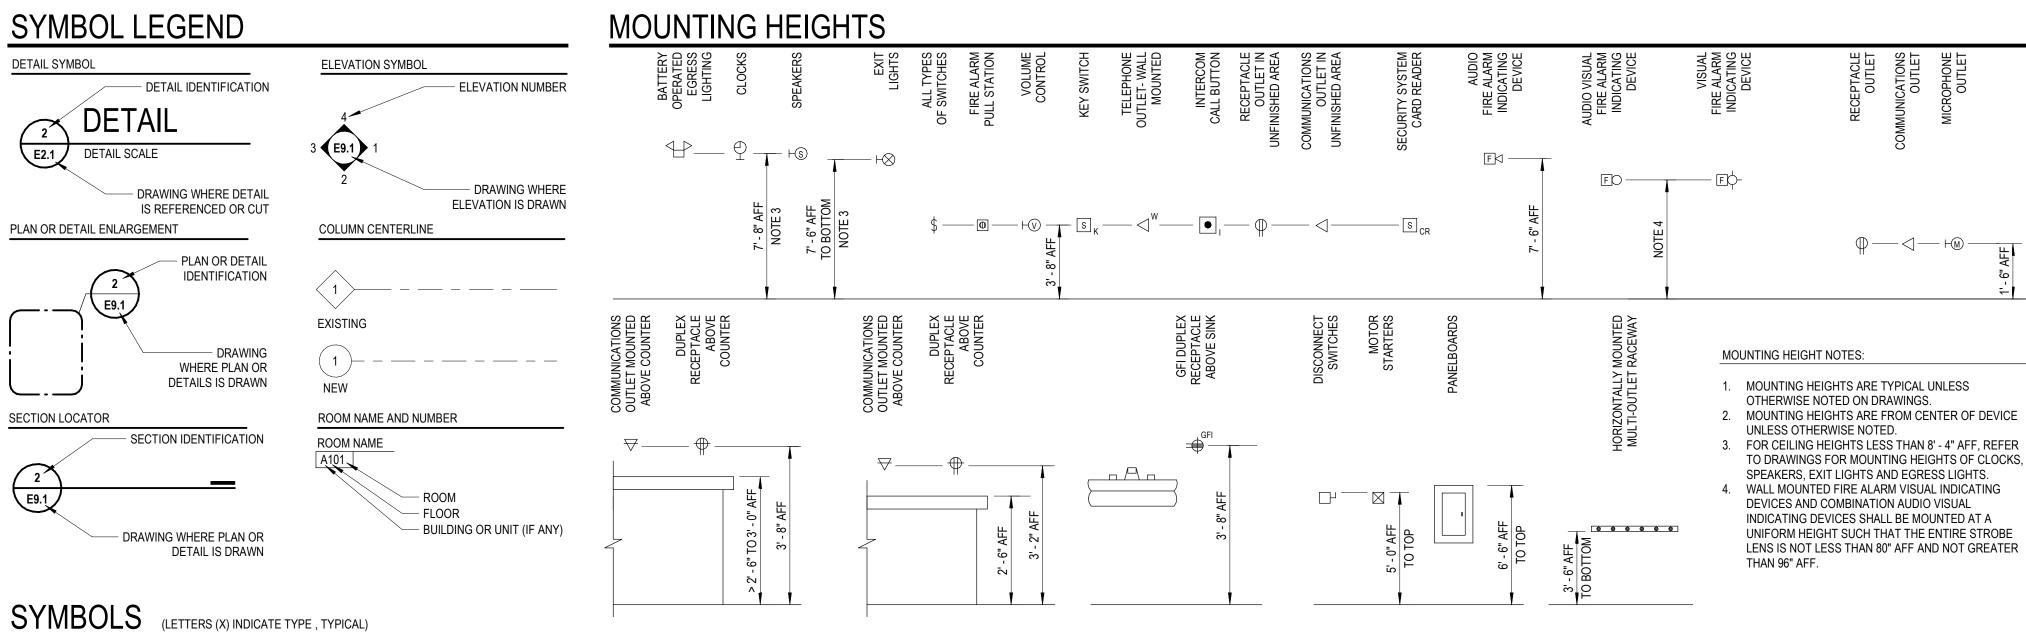M6.1



		^		
MBOLS (LETTERS (X) INDICATE TYPE , TYPICAL)				
<u>LIGHTING</u>				
LIGHTING FIXTURE; RECESSED OR SURFACE MOUNTED	\$ LINE VOLTAGE SINGLE POLE SWITCH	сн 😝 х	POWER FLOOR BOX	□ 130A
xx LIGHTING FIXTURE; RECESSED OR SURFACE MOUNTED	\$2 LINE VOLTAGE DOUBLE POLE SWITCH		DUPLEX RECEPTACLE OUTLET MOUNTED	
ON NIGHT LIGHT OR EMERGENCY CIRCUIT	\$3 LINE VOLTAGE THREE WAY SWITCH	CH	ABOVE COUNTER	2 1 _{30/30A}
LIGHTING FIXTURE; PENDANT MOUNTED	\$4 LINE VOLTAGE FOUR WAY SWITCH	-X	DUPLEX RECEPTACLE OUTLET WITH INTEGRAL GROUND FAULT CIRCUIT INTERRUPTER PROTECTION	CB 30A
LIGHTING FIXTURE; PENDANT MOUNTED ON NIGHT	\$ _K LINE VOLTAGE KEY OPERATED SWITC		DUPLEX RECEPTACLE OUTLET CONNECTED TO	_
LIGHT OR EMERGENCY CIRCUIT	\$ _D LINE VOLTAGE 'WALL BOX' DIMMER SWITC	CH SEL	UPSTREAM GROUND FAULT CIRCUIT INTERRUPTER PROTECTION DEVICE	VSD
STRIP LIGHTING FIXTURE	\$L LINE VOLTAGE WALL SWITCH OCCUPANCY SENSO WITH ON/OFF PUSHBUTTON		DUPLEX RECEPTACLE OUTLET WITH INTEGRAL SURGE	\$ _M
XX STRIP LIGHTING FIXTURE ON NIGHT LIGHT OR EMERGENCY CIRCUIT	♣ LINE VOLTAGE WALL SWITCH OCCUPANCY SENSO	OR	SUPPRESSION DUPLEX RECEPTACLE OUTLET CONNECTED TO	\$ _H
LIGHTING FIXTURE; RECESSED AIMABLE OR WALL WASH	WITH ON/OFF & BINNING FOOTIBOT FOR	_	UPSTREAM SURGE SUPPRESSION DEVICE DUPLEX RECEPTACLE OUTLET SPLIT WIRED	M
LIGHTING FIXTURE; RECESSED OR PENDANT MTD	\$LINE VOLTAGE WALL SWITCH OCCUPANCY SENSO WITH 2 ZONE ON/OFF PUSHBUTTON	NS ••••••••••••••••••••••••••••••••••••	DUPLEX RECEPTACLE OUTLET WITH ISOLATED GROUND	
	\$ _P LINE VOLTAGE SWITCH WITH PILOT LIGH	=	QUAD RECEPTACLE OUTLET	*
NL LIGHTING FIXTURE; RECESSED OR PENDANT MTD XX ON NIGHT LIGHT OR EMERGENCY CIRCUIT	\$ _T LINE VOLTAGE SWITCH WITH TIME	ER -♣	QUAD RECEPTACLE OUTLET MOUNTED ABOVE COUNTER	Т
LIGHTING FIXTURE; SURFACE MOUNTED	\$a\$b LINE VOLTAGE SINGLE POLE SWITCHE FOR DUAL LEVEL LIGHTING CONTRO	ES	QUAD RECEPTACLE OUTLET WITH ONE (1) INTEGRAL	©
LIGHTING FIXTURE; SURFACE MOUNTED	\$ 3a \$ 3b LINE VOLTAGE THREE WAY SWITCHE FOR DUAL LEVEL LIGHTING CONTROL		SURGE SUPPRESSION TYPE RECEPTACLE AND ONE (1) SURGE SUPPRESSION PROTECTED RECEPTACLE	X ⊢G→
ON NIGHT LIGHT OR EMERGENCY CIRCUIT	\$ _{LVX} LOW VOLTAGE PUSHBUTTON STATIC	-⊘ _X	SPECIAL RECEPTACLE AS INDICATED	
TRACK LIGHTING	LV - 1 ZONE ON/OF LVD - 1 ZONE ON/OFF & DIMMIN	FF \square_{χ}	POWER/COMMUNICATIONS POLE	
LIGHTING FIXTURE; WALL MOUNTED	LV2 - 2 ZONE ON/OF LV2D - 2 ZONE ON/OFF & DIMMIN	FF OR	SPECIAL POWER CONNECTION CORD DROP	Φ.
XX LIGHTING FIXTURE; WALL MOUNTED	W - LOW VOLTAGE WIRELES	SS OCR	CORD REEL	Ф ФФ
ON NIGHT LIGHT OR EMERGENCY CIRCUIT	© _X CEILING MOUNTED OCCUPANCY SENSO		POKE THROUGH ASSEMBLY	
LIGHTING FIXTURE; UNDERCABINET MOUNTED	WALL MOUNTED OCCUPANCY SENSO	JIX		φρ
LIGHTING FIXTURE; COVE MOUNTED	©LVX CEILING MOUNTED LINE VOLTAGE OCCUPANCY SENSO	_	JUNCTION BOX - CEILING MOUNTED	©
EXIT SIGN LIGHTING FIXTURE; FACES INDICATED BY SHADING, DIRECTIONAL ARROWS AS INDICATED	WALL MOUNTED LINE VOLTAGE OCCUPANCY SENSO	_	JUNCTION BOX - WALL MOUNTED	©
- CEILING OR PENDANT MOUNTED	LIGHTING CONTACTO TS TIME SWITCH	• -	PUSHBUTTON STATION - EMERGENCY POWER SHUTDOWN	DIG
EXIT SIGN LIGHTING FIXTURE; FACES INDICATED BY SHADING, DIRECTIONAL ARROWS AS INDICATED	LIGHTING CONTROL PAN		HORIZONTALLY MOUNTED MULTI-OUTLET RACEWAY	©
- WALL MOUNTED, END OR BACK	PHOTOELECTRIC SWITCH \ PHOTOCELL - CEILING MOUNTE	_	VERTICALLY MOUNTED MULTI-OUTLET RACEWAY	⊳ ©⊲
COMBO EXIT SIGN LIGHTING FIXTURE AND EMERGENCY	PHOTOELECTRIC SWITCH \ PHOTOCELL - WALL MOUNTE		BUS DUCT	Ю
LIGHTING UNIT; FACES INDICATED BY SHADING,	PRANCH CIRCUIT EMERCENCY LICHTING TRANSFER SWITCH		FOUIPMENT MOUNTING BACKBOARD	(

DOWNSTREAM CONNECTED DEVICES)

LIGHTING UNIT; FACES INDICATED BY SHADING,

CEILING MOUNTED SELF-CONTAINED EMERGENCY

WALL MOUNTED SELF-CONTAINED EMERGENCY

POLE MOUNTED AREA LIGHTING FIXTURE; QUANTITY

POST TOP POLE MOUNTED AREA LIGHTING FIXTURE

SITE LIGHTING FIXTURE; ADJUSTABLE FLOOD

COMBO EXIT SIGN LIGHTING FIXTURE AND EMERGENCY

PACKAGED EQUIPMEN MOUNTED PREWIRI	M	DUPLEX RECEPTACLE OUTLET SPLIT WIRED	=	LINE VOLTAGE WALL SWITCH OCCUPANCY SENSOR	\$ _{L2}	G FIXTURE; RECESSED AIMABLE OR WALL WASH
FURNISHED AS	*	DUPLEX RECEPTACLE OUTLET WITH ISOLATED GROUND	= €IG	WITH 2 ZONE ON/OFF PUSHBUTTONS LINE VOLTAGE SWITCH WITH PILOT LIGHT		G FIXTURE: RECESSED OR PENDANT MTD
EQUIPMEN		QUAD RECEPTACLE OUTLET	-	LINE VOLTAGE SWITCH WITH TIMER	\$ _₽	G FIXTURE; RECESSED OR PENDANT MTD
	Ţ	QUAD RECEPTACLE OUTLET MOUNTED ABOVE COUNTER	- ◆◆	LINE VOLTAGE SWITCH WITH TIMER LINE VOLTAGE SINGLE POLE SWITCHES	Ψ ⊺	N NIGHT LIGHT OR EMERGENCY CIRCUIT
LIQUENINO PROTEC	⊚	QUAD RECEPTACLE OUTLET WITH ONE (1) INTEGRAL	-00	FOR DUAL LEVEL LIGHTING CONTROL	\$ a \$ b	LIGHTING FIXTURE; SURFACE MOUNTED
LIGHTNING PROTEC	×	SURGE SUPPRESSION TYPE RECEPTACLE AND ONE (1) SURGE SUPPRESSION PROTECTED RECEPTACLE	SS SS	LINE VOLTAGE THREE WAY SWITCHES	\$ ^{3a} \$ ^{3b}	LIGHTING FIXTURE; SURFACE MOUNTED
GROUND BUS	⊢ G ⊣	-O _X SPECIAL RECEPTACLE AS INDICATED	-⊙ x	FOR DUAL LEVEL LIGHTING CONTROL	.	ON NIGHT LIGHT OR EMERGENCY CIRCUIT
ALIVILIADV CVCTEMO		■x POWER/COMMUNICATIONS POLE	\square_{X}	LOW VOLTAGE PUSHBUTTON STATION LV - 1 ZONE ON/OFF	\$ LVX	TRACK LIGHTING
AUXILIARY SYSTEMS		SPECIAL POWER CONNECTION	•	LVD - 1 ZONE ON/OFF & DIMMING LV2 - 2 ZONE ON/OFF		
CEILING MOUNTED SII	Ф	● CD CORD DROP	● CD	LV2D - 2 ZONE ON/OFF & DIMMING		LIGHTING FIXTURE; WALL MOUNTED
CEILING MOUNTED DO	99	● CR CORD REEL	● CR	W - LOW VOLTAGE WIRELESS	_	LIGHTING FIXTURE; WALL MOUNTED
WALL MOUNTED SII	Ф	• POKE THROUGH ASSEMBLY	$oldsymbol{\Theta}_{\mathrm{PT}}^{\mathrm{X}}$	CEILING MOUNTED OCCUPANCY SENSOR	⊚ _x	ON NIGHT LIGHT OR EMERGENCY CIRCUIT
WALL MOUNTED DO	ф			WALL MOUNTED OCCUPANCY SENSOR	⊢ ⊚ _x	TING FIXTURE; UNDERCABINET MOUNTED
COMBINATION WALL MOUNTI	ဇှာ်	JUNCTION BOX - CEILING MOUNTED		CEILING MOUNTED LINE VOLTAGE OCCUPANCY SENSOR	⊚ _{LVX}	LIGHTING FIXTURE; COVE MOUNTED
CEILING MOUNTED COMBINATION	œ	JUNCTION BOX - WALL MOUNTED	J	WALL MOUNTED LINE VOLTAGE OCCUPANCY SENSOR	H _⊙ _{LVX}	LIGHTING FIXTURE; FACES INDICATED BY
WALL MOUN	DIG	PUSHBUTTON STATION - EMERGENCY POWER SHUTDOWN	● _E	LIGHTING CONTACTOR TIME SWITCH	LC	NG, DIRECTIONAL ARROWS AS INDICATED - CEILING OR PENDANT MOUNTED
CEILING	<u> </u>	HORIZONTALLY MOUNTED MULTI-OUTLET RACEWAY			TS	LIGHTING FIXTURE; FACES INDICATED BY
CEILING MOUNTED	D	VERTICALLY MOUNTED MULTI-OUTLET RACEWAY			LCP	NG, DIRECTIONAL ARROWS AS INDICATED - WALL MOUNTED, END OR BACK
WALL	Ю	BUS DUCT		HOTOELECTRIC SWITCH \ PHOTOCELL - CEILING MOUNTED	_	SIGN LIGHTING FIXTURE AND EMERGENCY
CEILING MOUNTED MI	(EQUIPMENT MOUNTING BACKBOARD		PHOTOELECTRIC SWITCH \ PHOTOCELL - WALL MOUNTED	Ю -	ING UNIT; FACES INDICATED BY SHADING,
WALL MOUNTED MI	Ю	PANELBOARD (250V AND LESS)		RANCH CIRCUIT EMERGENCY LIGHTING TRANSFER SWITCH		DIRECTIONAL ARROWS AS INDICATED - CEILING OR PENDANT MOUNTED
WALL MOUNTED	Ю	PANELBOARD (GREATER THAN 250V)		LIGHTING CONTROL PRESET STATION OR TOUCHSCREEN	TS-X	SIGN LIGHTING FIXTURE AND EMERGENCY
WALL MOUNTED	Ю	DISTRIBUTION OR POWER PANELBOARD		POWER		ING UNIT; FACES INDICATED BY SHADING, DIRECTIONAL ARROWS AS INDICATED
W		SINGLE PHASE MOTOR		SINGLE RECEPTACLE OUTLET	Ф	- WALL MOUNTED, END OR BACK
WA		THREE PHASE MOTOR	_	DUPLEX RECEPTACLE OUTLET	⊕ _x	MOUNTED SELF-CONTAINED EMERGENCY
WALL MOUN	⊞⊲	MAGNETIC MOTOR STARTER			= ×	LIGHTING UNIT
				DUPLEX RECEPTACLE OUTLET FLUSH MOUNTED IN CEILING	⊖ c	MOUNTED SELF-CONTAINED EMERGENCY LIGHTING UNIT
		COMBINATION MAGNETIC MOTOR STARTER & FUSED DISCONNECT SWITCH - SWITCH SIZE / FUSE SIZE	⊠ P _{30/30A}	DEAD-FRONT GROUND FAULT CIRCUIT INTERRUPTER (PROTECTION OF DOWNSTREAM CONNECTED DEVICES)	-□ GFI	NTED AREA LIGHTING FIXTURE; QUANTITY OF LUMINARIES AS INDICATED
				DEAD-FRONT GROUND FAULT CIRCUIT INTERRUPTER MOUNTED ABOVE COUNTER (PROTECTION OF	-ф ^{GFI}	SITE LIGHTING; BOLLARD

NON-FUSED DISCONNECT SWITCH	⊕⊲	CEILING MOUNTED HORN SPEAKER	N _{BB}
-SWITCH SIZE FUSED DISCONNECT SWITCH	s _{CR}	SECURITY SYSTEM CARD READER	N BC
-SWITCH SIZE/FUSE SIZE	sc	SECURITY SYSTEM DOOR CONTACT	● CB
ENCLOSED CIRCUIT BREAKER -CB RATING	s _{ES}	SECURITY SYSTEM ELECTRIC STRIKE	N _{DS}
	s _{EH}	SECURITY SYSTEM ELECTRIFIED HARDWARE	NE
VARIABLE SPEED DRIVE	s _{LD}	SECURITY SYSTEM LOCKDOWN READER\BUTTON	N MS
MAGNETIC CONTACTOR	sK	SECURITY SYSTEM KEY SWITCH	N _{PS}
MANUAL MOTOR STARTER	s _{MD}	SECURITY SYSTEM MOTION DETECTOR	N _{SS}
HORSEPOWER RATED SWITCH	©	CEILING MOUNTED SECURITY CAMERA	H⊳
PACKAGED EQUIPMENT WITH INTEGRALLY	Ю	WALL MOUNTED SECURITY CAMERA	₹c
MOUNTED PREWIRED CONTROL PANEL FURNISHED AS INTEGRAL PART OF	F	FIRE ALARM PULL STATION	₩ NUF
EQUIPMENT, OR AS INDICATED	FD	WALL MOUNTED A/V FIRE ALARM INDICATING DEVICE	▼ c
TRANSFORMER	\mathbf{E}_{AV}	CEILING MOUNTED A/V FIRE ALARM INDICATING DEVICE	
GROUND ROD	Εφ-	WALL MOUNTED VISUAL FIRE ALARM INDICATING DEVICE	✓x
LIGHTNING PROTECTION AIR TERMINAL	$lackbox{f E}_{ee}$	CEILING MOUNTED VISUAL FIRE ALARM INDICATING DEVICE	₄ x
GROUND BUS BAR AS INDICATED	F 4	WALL MOUNTED AUDIO FIRE ALARM INDICATING DEVICE	$\triangleleft_{\text{C/X}}$
A L IV/II LA TIV/ OV/OTTI LO	\bullet A	CEILING MOUNTED AUDIO FIRE ALARM INDICATING DEVICE	$\mathbf{\nabla}_{x}$
AUXILIARY SYSTEMS	Еф-	WALL MOUNTED VISUAL EMERGENCY MASS NOTIFICATION INDICATING DEVICE	₽ ∇ _x
CEILING MOUNTED SINGLE FACED CLOCK	©, '	CEILING MOUNTED VISUAL EMERGENCY MASS NOTIFICATION	
CEILING MOUNTED DOUBLE FACED CLOCK		INDICATING DEVICE	● _{IP}
WALL MOUNTED SINGLE FACED CLOCK	F _{SD}	WALL MOUNTED AREA SMOKE DETECTOR	
WALL MOUNTED DOUBLE FACED CLOCK	$oldsymbol{\mathbb{G}}_{ ext{SD}}$	CEILING MOUNTED AREA SMOKE DETECTOR	\triangle \lor
COMBINATION WALL MOUNTED SPEAKER/CLOCK	\mathbf{e}^{cd}	CEILING MOUNTED COMBINATION AREA SMOKE & CARBON MONOXIDE DETECTOR	M
CEILING MOUNTED COMBINATION SPEAKER/CLOCK	F _{TD}	WALL MOUNTED TEMPERATURE DETECTOR	MM
WALL MOUNTED DIGITAL CLOCK	© _{TD}	CEILING MOUNTED TEMPERATURE DETECTOR	К
CEILING MOUNTED SPEAKER	E DD	DUCT SMOKE DETECTOR	$\widehat{}$
CEILING MOUNTED SPEAKER CLUSTER	E DR	WALL MOUNTED MAGNETIC DOOR HOLDER/RELEASE	• •
WALL MOUNTED SPEAKER	F WF	WATER FLOW SWITCH	
CEILING MOUNTED MICROPHONE OUTLET	E TS	TAMPER SWITCH	<u>~~</u>
WALL MOUNTED MICROPHONE OUTLET	E _{MM}	MONITOR MODULE	7
WALL MOUNTED AUXILIARY OUTLET	E _{CM}	CONTROL MODULE	•~~ols
WALL MOUNTED VOLUME CONTROL	V	FIRE FIGHTER TELEPHONE JACK	⊣ ⊢
WALL MOUNTED BELL	FACP	FIRE ALARM CONTROL PANEL	XXXNG
WALL MOUNTED CHIME	FSCP	FIRE SUPPRESSION SYSTEM CONTROL PANEL	‹←⑥→›
WALL MOUNTED HORN SPEAKER	FAAP	FIRE ALARM REMOTE ANNUNCIATOR PANEL	<←□→> 52
	N	SINGLE BED STATION - NURSE CALL	
	N _{2B}	DOUBLE BED STATION - NURSE CALL	
	ZB		

BATHROOM STATION - NURSE CALL __ BATHROOM STATION PULL CORD - NURSE CALL CODE BLUE PUSHBUTTON - NURSE CALL NURSE CALL DUTY STATION NURSE CALL EMERGENCY STATION NURSE CALL MASTER STATION ______ NURSE CALL POWER SUPPLY NURSE CALL STAFF STATION NURSE CALL WALL MOUNTED DOME LIGHT NURSE CALL CEILING MOUNTED DOME LIGHT NURSE CALL WALL MOUNTED DOME LIGHT WITH CODE NURSE CALL CEILING MOUNTED DOME LIGHT WITH CODE BLUE WALL MOUNTED COMMUNICATIONS OUTLET —HP— WALL MOUNTED COMMUNICATIONS OUTLET — C— MOUNTED ABOVE COUNTER —HC— CEILING MOUNTED COMMUNICATIONS OUTLET COMMUNICATIONS FLOOR BOX POWER & COMMUNICATIONS FLOOR BOX INTERCOM CALL BUTTON HH INTERCOM CALL BUTTON WITH PRIVACY —— E— ANALOG AMPERE\VOLT METER ANALOG ENERGY USAGE METER —_ L — DIGITAL MULTI-FUNCTION METER KIRK KEY INTERLOCK CIRCUIT BREAKER SWITCH FUSE TRANSFORMER TRANSFER SWITCH THERMAL OVERLOAD CONTACTS

INDICATES WIRE SIZE AND CONDUIT SIZE

AIR-MAG / VACUUM CIRCUIT BREAKER

DRAWOUT CIRCUIT BREAKER

ENGINE GENERATOR

SYSTEM OR EQUIPMENT GROUND <u>MISC</u> EXOTHERMIC WELD OR BRAZED

> CONNECTION CONDUIT IN OR BELOW FLOOR SLAB OR BELOW GRADE RACEWAY TURNED UP RACEWAY TURNED DOWN HAZARDOUS LOCATION CONDUIT SEALING FITTING CABLE TRAY

> > UNDERFLOOR DUCT - POWER UNDERFLOOR HEADER DUCT - POWER UNDERFLOOR DUCT - COMM

UNDERFLOOR HEADER DUCT - COMM

FLUSH IN-GRADE HAND HOLE UNDERGROUND ELECTRICAL UNDERGROUND COMMUNICATIONS UNDERGROUND FIBER OPTIC COMMUNICATIONS UNDERGROUND LIGHTING

EMERGENCY "CODE BLUE" BOLLARD

PROJECT GENERAL NOTES

1. ALL ITEMS SHOWN HATCHED SHALL BE DISCONNECTED AND REMOVED. LIGHT LINE WEIGHT INDICATES EXISTING ITEMS TO REMAIN. HEAVY LINE WEIGHT INDICATES NEW ITEMS.

ELECTRICAL DRAWING INDEX

Electrical Reference Information

Enlarged Plan

Enlarged Plans

Diagrams and Details

E4.2

- 2. ITEMS DENOTED BY THE LETTER "R" INDICATE EXISTING ITEMS TO BE RELOCATED. THESE ITEMS SHALL BE DISCONNECTED, REMOVED AND STORED FOR REINSTALLATION IN NEW LOCATIONS AS INDICATED ON NEW WORK PLANS.
- 3. WHERE APPLICABLE AND NOT SPECIFICALLY INDICATED OTHERWISE, EXISTING IN PLACE CONDUITS, JUNCTION BOXES, PULL BOXES AND HANGERS MAY BE REUSED FOR NEW WORK PROVIDING THAT THE INSTALLATION IS IN ACCORDANCE WITH THE PROJECT SPECIFICATIONS AND THE EXISTING ITEMS DO NOT INTERFERE WITH DEMOLITION OR NEW WORK OF ANY TRADES.
- 4. WHERE CONDUITS ARE ROUTED CONCEALED IN WALL CAVITIES FOR ELECTRICAL ITEMS INDICATED TO BE REMOVED, ABANDON THE CONDUIT CONCEALED IN THE WALL CAVITY. REMOVE THE CONDUIT EXITING THE WALL CAVITY INTO THE CEILING SPACE BEYOND THE FIRST FITTING OR JUNCTION BOX. REMOVE ALL SURFACE MOUNTED OUTLET BOXES ASSOCIATED WITH THE CONDUIT SYSTEM. ABANDON ALL FLUSH MOUNTED OUTLET BOXES ASSOCIATED WITH THE CONDUIT SYSTEM IN PLACE AND PROVIDE NEW BLANK COVER PLATES.
- 5. DISCONNECT AND REMOVE ALL ELECTRICAL EQUIPMENT AS INDICATED INCLUDING HANGERS, PULL BOXES, JUNCTION BOXES, CONDUIT AND WIRING FROM THE POWER SOURCE TO THE UTILIZATION EQUIPMENT.
- 6. WHERE REMOVAL OF CONDUIT AND WIRING AFFECTS THE OPERATION OF "UPSTREAM" AND/OR "DOWNSTREAM" UTILIZATION EQUIPMENT WHICH WAS NOT INDICATED TO BE REMOVED, PROVIDE ADDITIONAL CONDUIT AND WIRING TO RESTORE THE "UPSTREAM" AND "DOWNSTREAM" UTILIZATION EQUIPMENT TO ITS NORMAL OPERATION.
- 7. FURNISH ALL LABOR, MATERIALS, EQUIPMENT, AND SUPERVISION REQUIRED TO COMPLETE ALL DEMOLITION OF EXISTING ELECTRICAL EQUIPMENT AS SPECIFIED OR INDICATED. DISCONNECT, REMOVE AND RELOCATE ALL ITEMS AS REQUIRED TO FACILITATE THE NEW CONSTRUCTION. COORDINATE THE DEMOLITION REQUIREMENTS WITH ALL OTHER TRADES AND THE NEW WORK
- 8. NEW FIRE ALARM DEVICES SHALL BE COMPATIBLE WITH EXISTING FIRE ALARM SYSTEM. EXISTING FIRE ALARM SYSTEM IS MANUFACTURED BY NATIONAL TIME & SIGNAL. COORDINATE ALL SYSTEM REQUIREMENTS WITH MANUFACTURER.
- 9. PROVIDE A DEDICATED NEUTRAL CONDUCTOR WITHIN THE RACEWAY ALONG WITH THE PHASE CONDUCTORS FOR ALL FEEDERS AND BRANCH CIRCUITS.
- 10. PROVIDE AN EQUIPMENT GROUNDING CONDUCTOR WITHIN THE RACEWAY ALONG WITH THE PHASE CONDUCTORS FOR ALL FEEDERS AND BRANCH
- 11. ALL 120 VOLT, 20 AMPERE BRANCH CIRCUITS EXCEEDING 100'-0" IN LENGTH SHALL BE INSTALLED USING #10 AWG CONDUCTORS UNLESS OTHERWISE 12. ALL ELECTRICAL DEVICES AND ASSOCIATED OUTLET BOXES SHALL BE FLUSH
- MOUNTED UNLESS NOTED OTHERWISE. ALL CONDUIT AND WIRING SHALL BE CONCEALED. SURFACE METAL RACEWAY SHALL BE PERMITTED ONLY WHERE
- 13. MOUNTING HEIGHT OF RECESSED JUNCTION OR OUTLET BOXES IN BLOCK OR BRICK MAY BE ADJUSTED TO THE NEAREST HORIZONTAL COURSING AS LONG AS THE SPECIFIED MOUNTING HEIGHT IS NOT EXCEEDED. COVER PLATE TO CONCEAL GROUT LINE.
- 14. FOR ALL ROOF MOUNTED MECHANICAL EQUIPMENT WHERE ASSOCIATED DISCONNECT SWITCHES OR RECEPTACLES ARE INSTALLED BY THE ELECTRICAL CONTRACTOR, FURNISH AND INSTALL ADDITIONAL HORIZONTAL AND VERTICAL UNISTRUT WITH LATERAL BRACING FROM THE ROOF CURB SUPPORTING THE MECHANICAL UNIT FOR MOUNTING OF THE DISCONNECT SWITCHES OR RECEPTACLES. DISCONNECT SWITCH SHALL BE MOUNTED 48" ABOVE THE FINISH ROOF. ALL UNISTRUT AND ASSOCIATED HARDWARE, FASTENERS, ETC., SHALL BE GALVANIZED.
- 15. ALL WORK AND EQUIPMENT SHALL COMPLY WITH THE NEC INCLUDING ANY MODIFICATIONS BY THE LOCAL JURISDICTION. THE MEANS AND METHODS USED BY THIS CONTRACTOR SHALL CONFORM TO NEC SECTION 110.3.
- 16. FIRE ALARM SHOP DRAWINGS SHALL BE SUBMITTED TO THE FIRE MARSHAL FOR APPROVAL PRIOR TO SUBMITTING FOR ENGINEER APPROVAL.

INTEGRATED design SOLUTIONS architecture engineering interiors & technology 1441 west long lake, suite 200 troy, michigan 48098 5211 cascade road SE, suite 300



Van Buren Public Schools

RAHS Belleville High School

501 W Columbia Ave Belleville, MI 48111

THIS PROJECT MAY NOT UTILIZE ALL THE SYMBOLS, MATERIALS, ABBREVIATIONS AND STANDARDS INFORMATION SHOWN ON THIS SHEET

> Project Administrator A. Maurer Project Designer T. Morgan Project Architect / Engineer T. Morgan Drawn By T. Morgan Q.M. Review Drawing Scale No Scale Issue Date Issued for Design Development 07-03-2024

> > **Electrical Reference Information**

 \circ 2024 Integrated $ext{design}$ solutions, LL

ī**D**§ Project Number

Drawing Number

24167-1000

ER.0

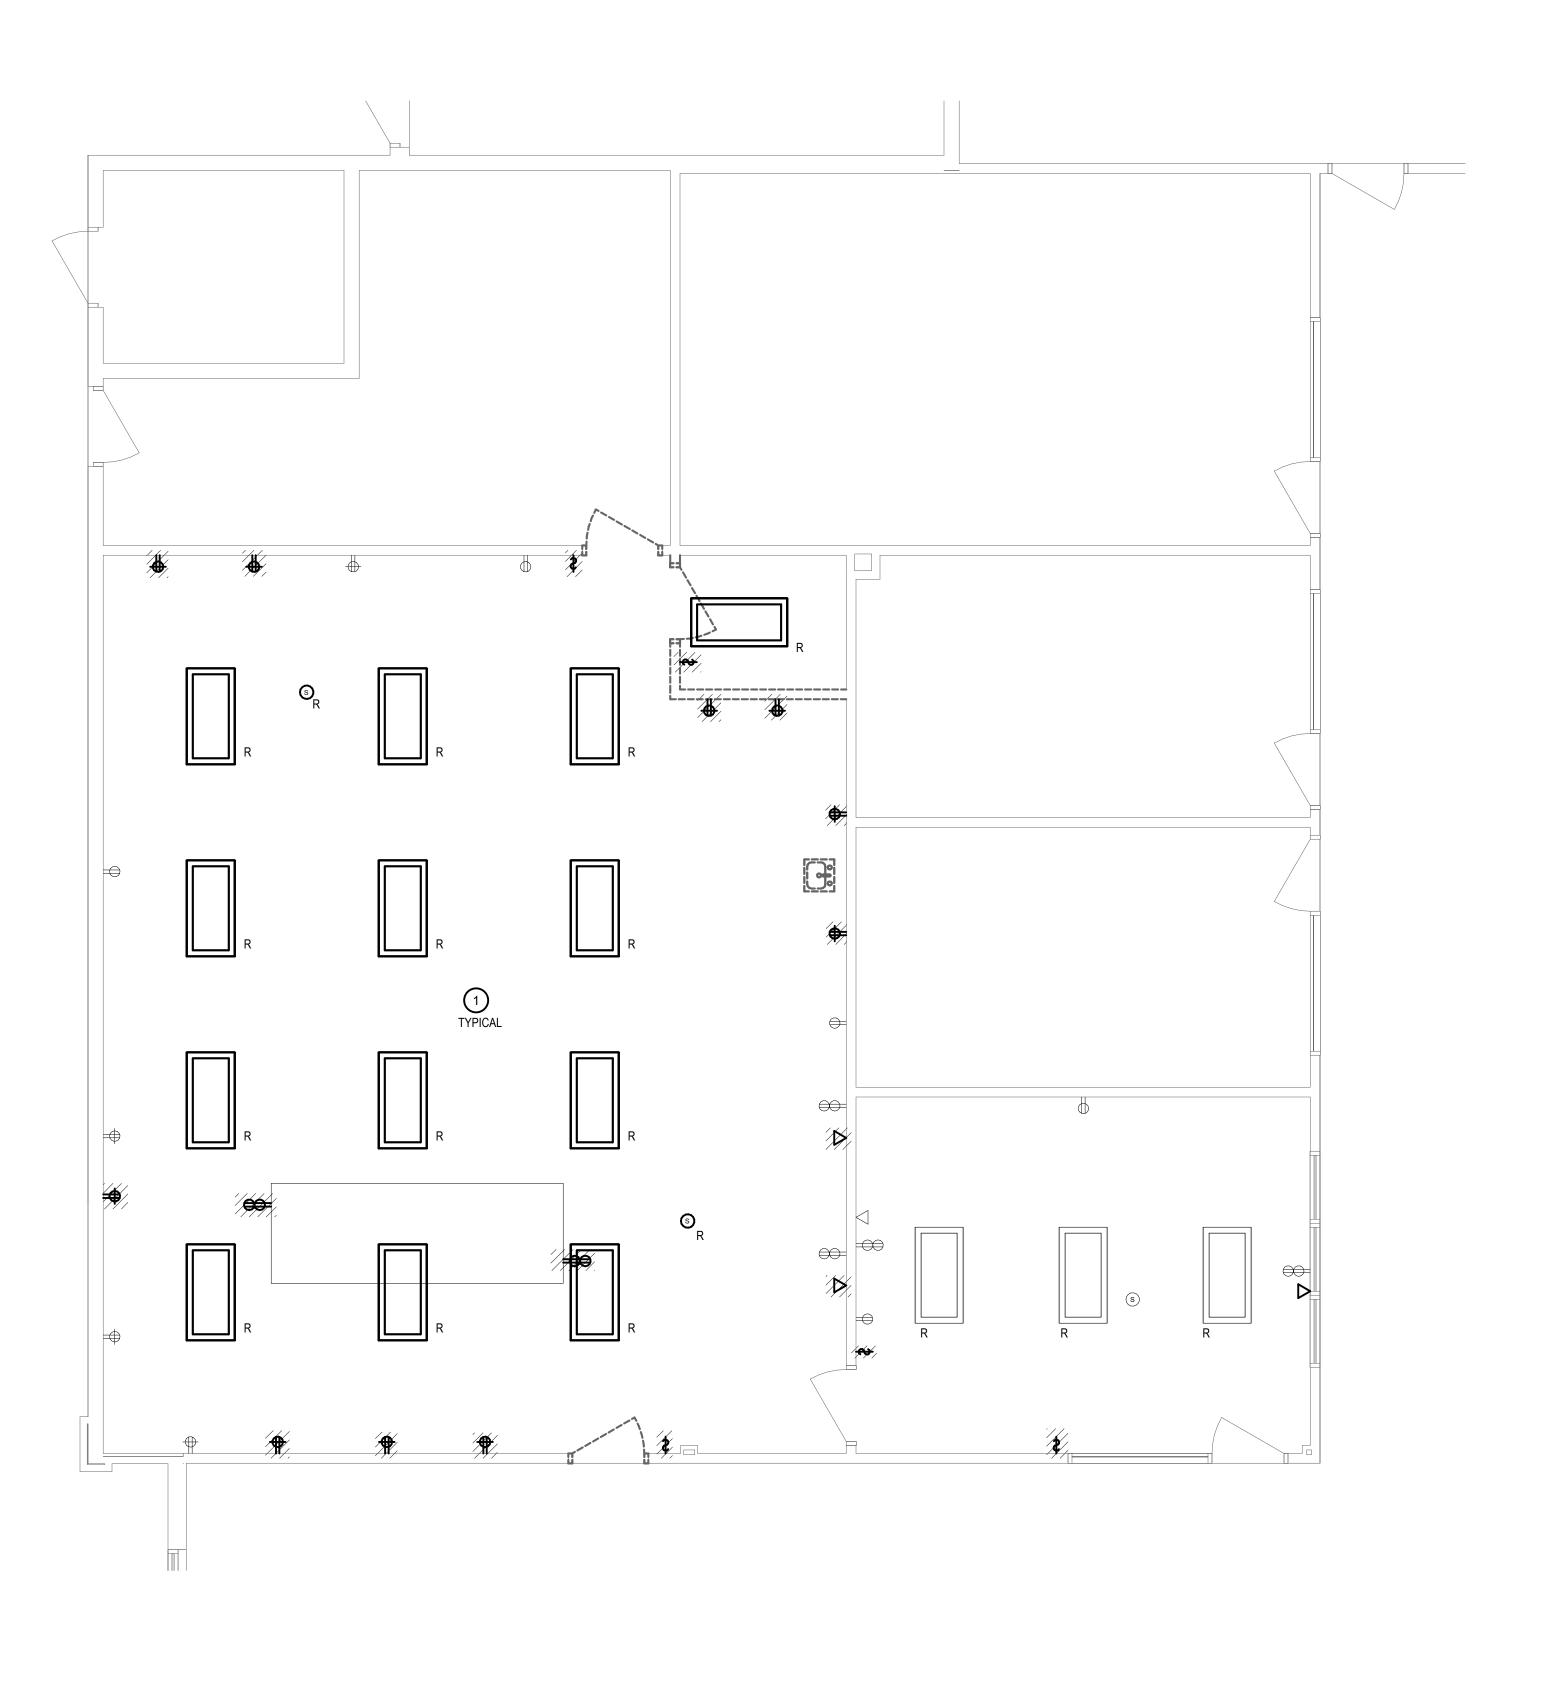
grand rapids, michigan 49546

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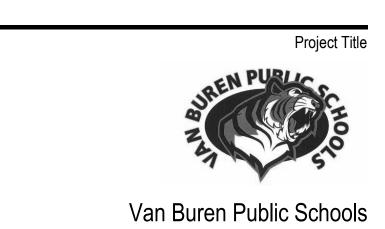
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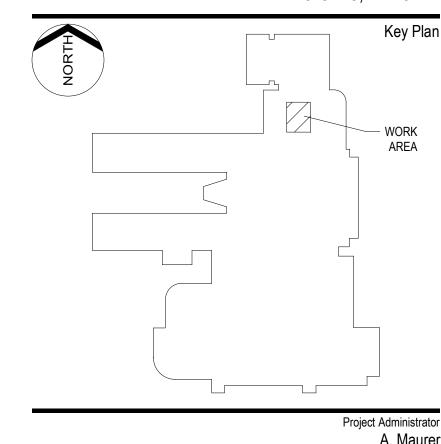


1 FIRST FLOOR ELECTRICAL DEMOLITION PLAN



RAHS Belleville High School

501 W Columbia Ave Belleville, MI 48111



i. Morga
Project Architect / Enginee
T. Morga
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T. Morga
Q.M. Review
Approve
Drawing Scal
As Indicate
Issued for Issue Date
Design Development 07-03-202

 \circ 2024 Integrated ${f design}$ solutions, LLC

Enlarged Plan

ī **D** S Project Number

E4.1

Drawing Number

Van Buren Public Schools

501 W Columbia Ave Belleville, MI 48111

A. Maurer

Project Designer Designer

T. Morgan

Issue Date

Issued for

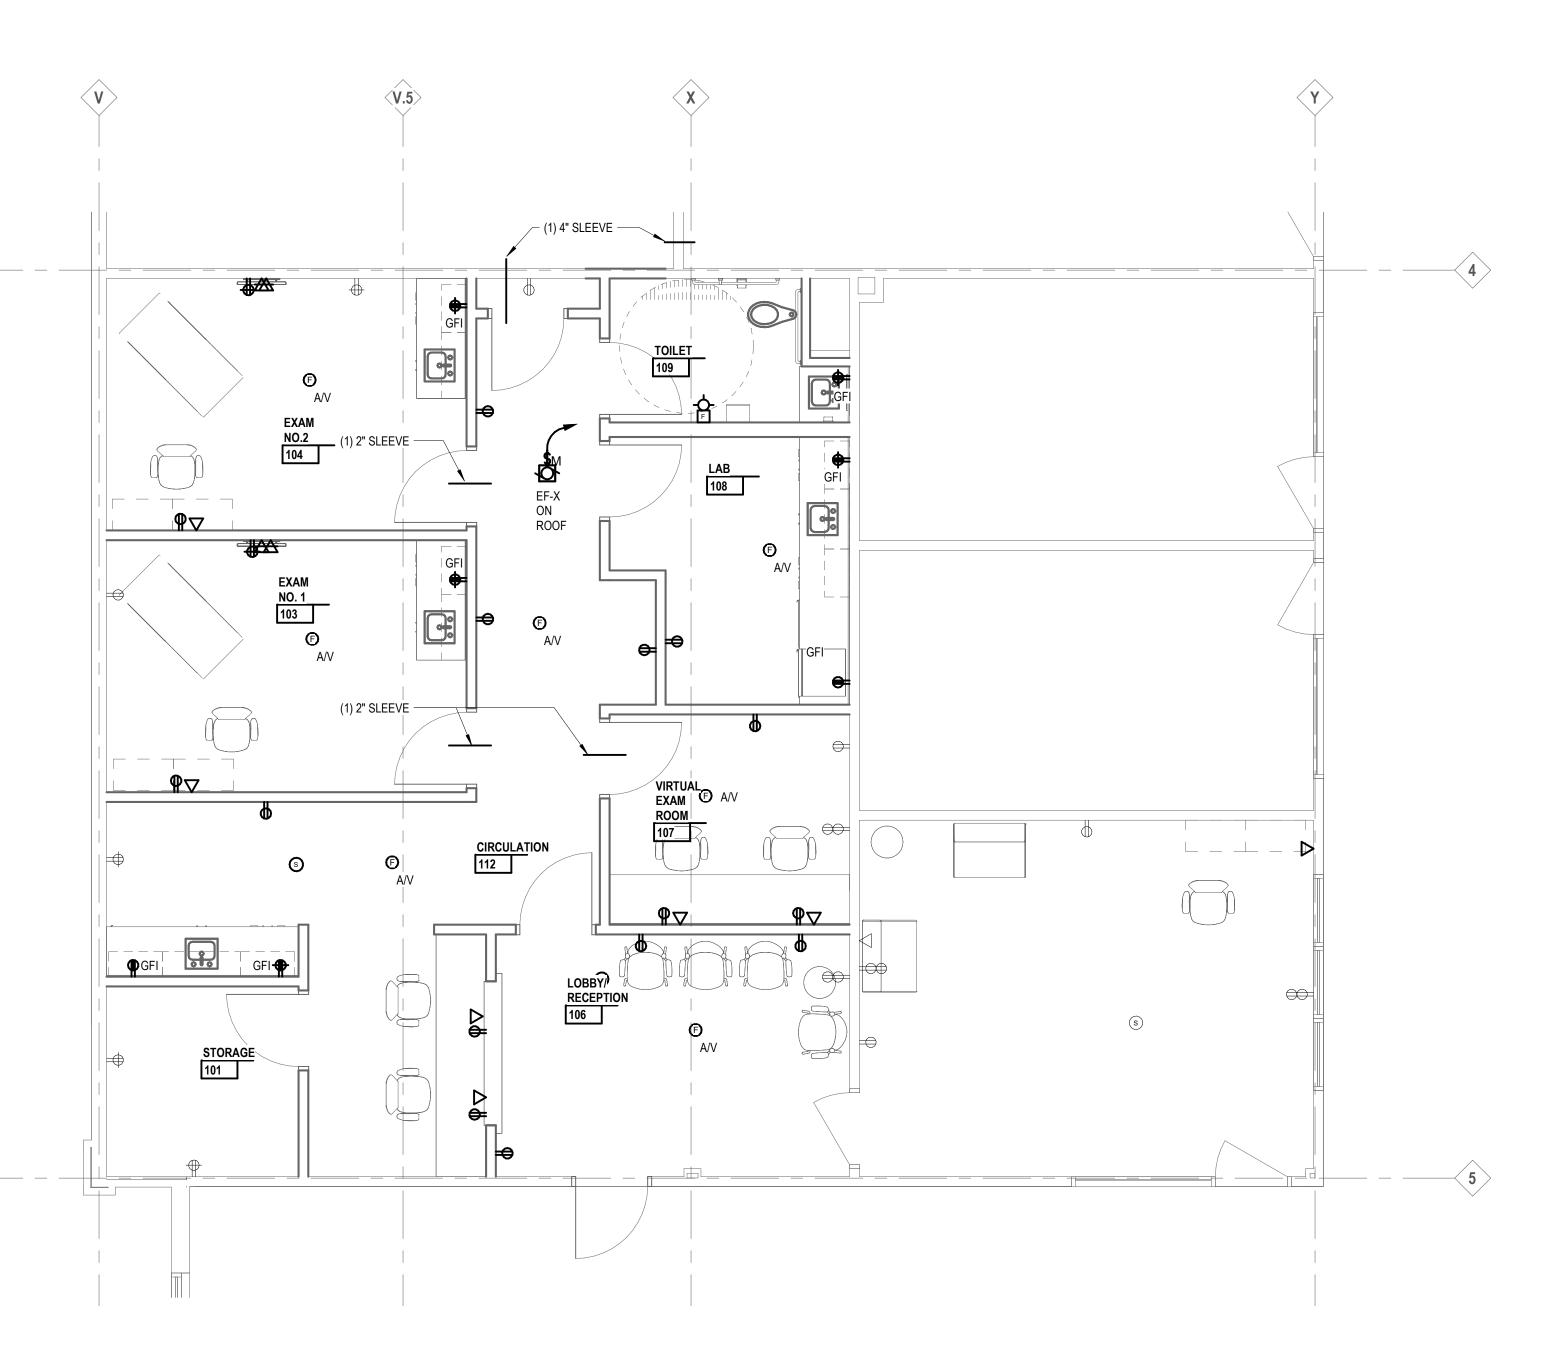
 \circ 2024 integrated $ext{design}$ solutions, LLC

IDS Drawing Title


Drawing Number

Author Q.M. Review

Project Architect / Engineer



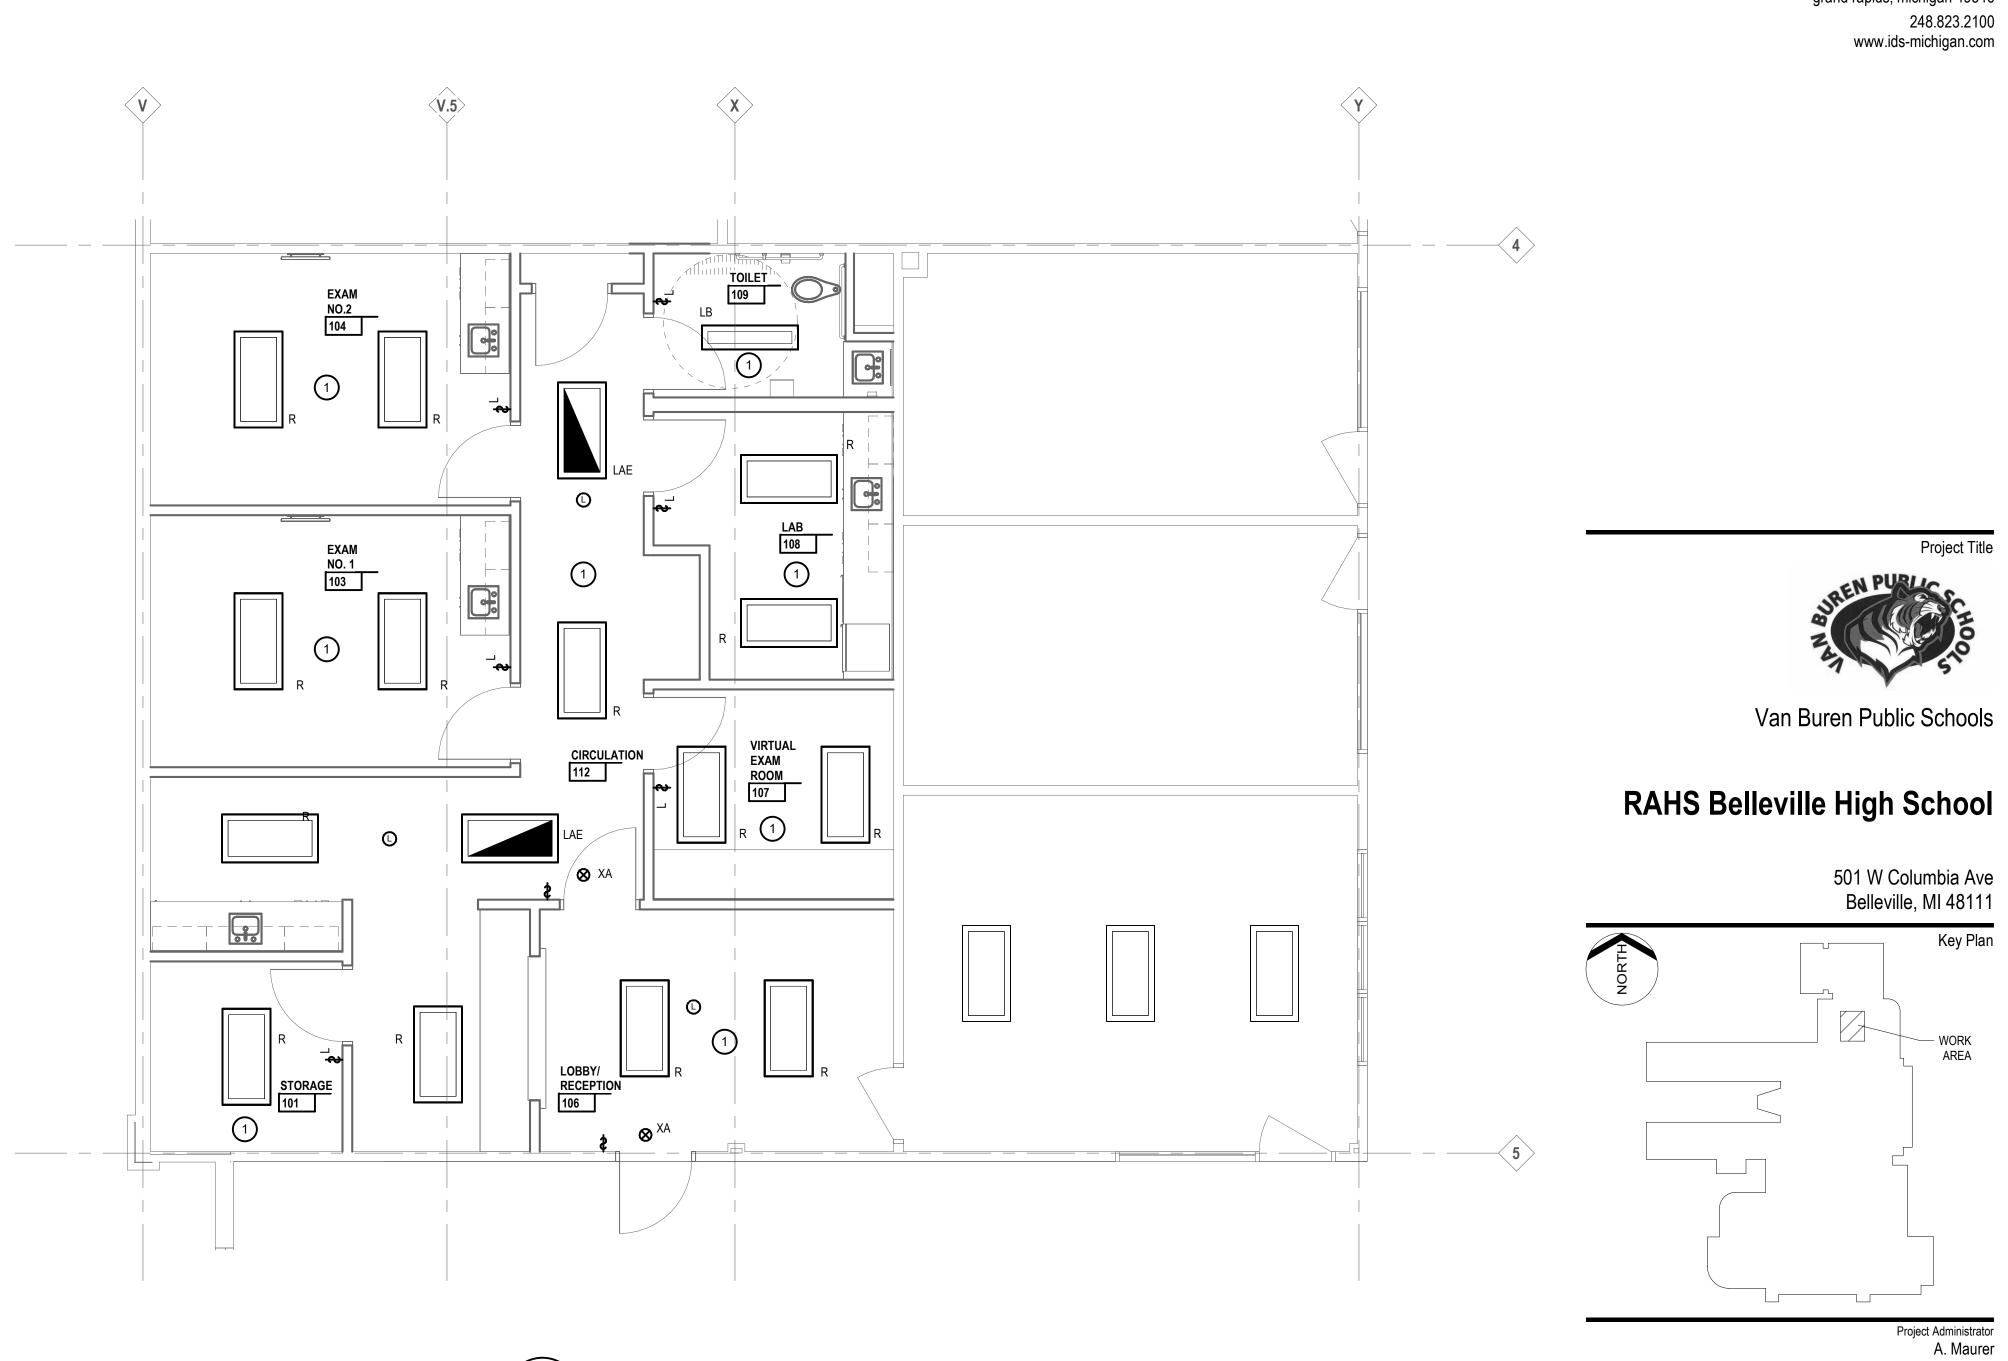FIRST FLOOR POWER & AUXILIARY SYSTEMS PLAN



1 FIRST FLOOR LIGHTING PLAN

LIGHTING FIXTURE SCHEDULE

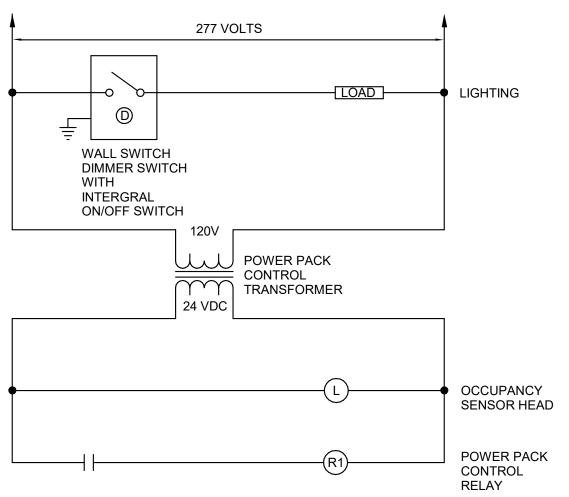
2' x 4' RECESSED LED BACK-LIT FLAT PANEL WITH: 4800 NOMINAL LUMEN PACKAGE, 3" MAXIMUM THICKNESS, POST-PAINTED GALVANIZED STEEL HOUSING, WHITE PAINTED ALUMINUM OR 20 GA. STEEL FRAME CONSTRUCTION, FACTORY INSTALLED DIE-FORMED DRIVER BOX ACCESSIBLE ABOVE, 0.125" THICK (MIN) PMMA OPAL FORSTED LENS, 100 LPW MIN EFFICACY, INTEGRAL SURGE PROTECTION, DRIVER DISCONNECT, L70 PROJECTED LIFE OF >90K HOURS AT 25 DEGREES CELCIUS AMBIENT TEMPERATURE, 120 VOLTAGE REPLACEABLE POWER SUPPLY WITH FLICKER FREE 10% MINIMUM DIMMING, T-BAR CLIPS FOR INSTALLATION IN A LAY-IN CEILING, DLC LISTED AND UL DAMP LOCATION LISTING. MANUFACTURER: ACUITY: SPX SERIES MINIMUM 80 CRI, 3500K CCT, 4800 LUMENS SOURCE: INPUT WATTS: SAME AS TYPE "LA", EXCEPT PROVIDE INTEGRAL EMERGENCY BATTERY RATED FOR 1541 LUMENS AT 10-14 W PROVIDING CONTINUOUS RATED LIGHT OUTPUT FOR 90 MINUTES. MANUFACTURER: ACUITY: SPX SERIES MINIMUM 80 CRI, 3500K CCT INPUT WATTS: 43 LB DESCRIPTION: SAME AS TYPE "LA" EXCEPT 1' X 4'; MOUNTED IN GYMSUM CEILING MANUFACTURER: ACUITY: SPX SERIES SOURCE: MINIMUM 80 CRI, 4800 DELIVERED LUMENS, 3500K CCT MAX INPUT WATTS: 39 WATTS MAXIMUM DESCRIPTION: SINGLE FACE, UNIVERSAL WALL MOUNT LED EMERGENCY EXIT LUMINAIRE WITH: DIE-CAST ALUMINUM FRAME, BACK PLATE AND MOUNTING CANOPY, WHITE DIE-CAST ALUMINUM (HOUSING), DIE-CAST ALUMINUM WHITE FACE; RED

STENCIL STYLE LETTERS; DIRECTIONAL ARROWS AS INDICATED ON PLAN; LED LAMPS WITH DIFFUSE POLYCARBONATE LENS; SEALED MAINTENANCE FREE NICKEL CADMIUM BATTERY; LOW VOLTAGE DISCONNECT; SOLID STATE/FULLY AUTOMATIC AND CURRENT LIMITED CHARTER; BOTTOM MOUNTED TEST-SWITCH/PILOT LIGHT; BROWNOUT PROTECTION, FILTERED POWER SUPPLY TO PROTECT LED'S FROM SURGES, AND FULL SELF-DIAGNOSTICS, DUAL 120/277 VOLT NORMAL OPERATION AND UL LISTED. PROVIDE WIRE GUARD WHERE INDICATED ON PLANS

MANUFACTURER: LITHONIA: LE SERIES SOURCE: FURNISHED WITH FIXTURE

INPUT WATTS: 1.2W (SINGLE)

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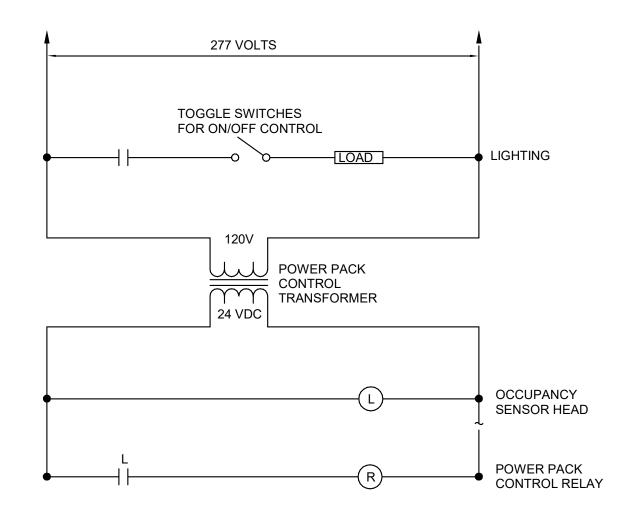


CEILING OCCUPANCY SENSOR WITH DIMMER LIGHTING CONTROL

NO SCALE

ALL LOW VOLTAGE WIRING SHALL BE #18 AWG MINIMUM.
 MULTIPLE SENSORS AND RELAY CONTROL PANEL OPERATING ONE LOAD.

CEILING OCCUPANCY SENSOR WITH DIMMER LIGHTING CONTROL

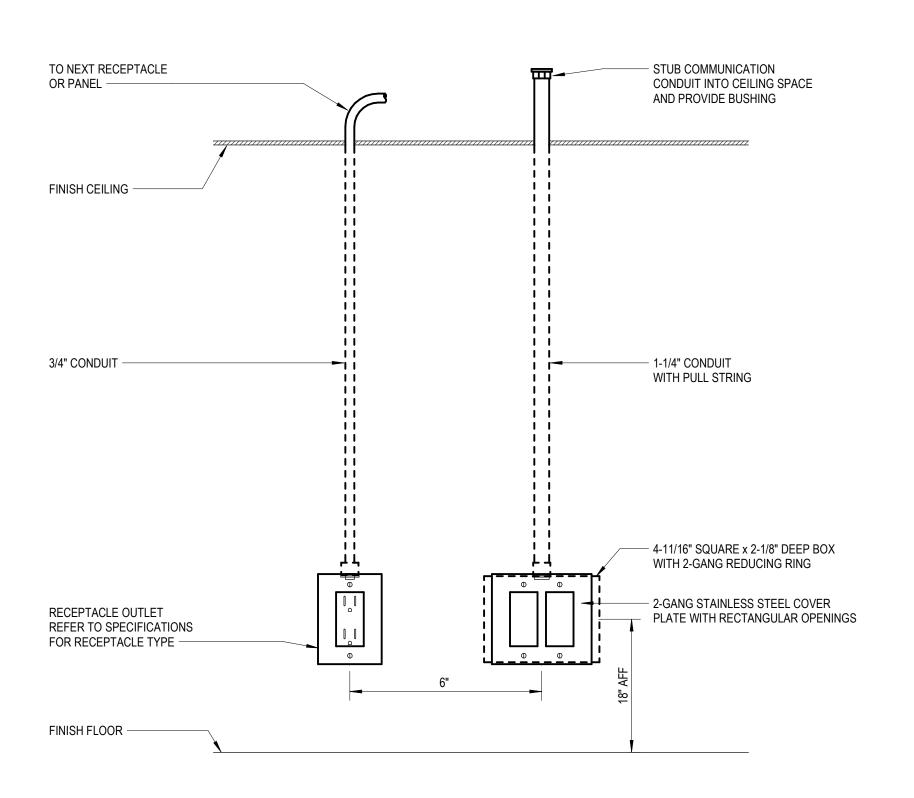


CEILING OCCUPANCY SENSOR SINGLE HEAD SINGLE LEVEL LIGHTING CONTROL

NO SCALE NOTES

ALL LOW VOLTAGE WIRING SHALL BE #18 AWG MINIMUM.
 SINGLE SENSOR AND RELAY CONTROL PANEL OPERATING ONE LOAD.

CEILING OCCUPANCY SENSOR SINGLE HEAD SINGLE LEVEL LIGHTING CONTROL




TYPICAL WALL MOUNTED POWER AND COMMUNICATION OUTLET DETAIL

CONDUIT AND WIRE SCHEDULE COPPER CONDUCTORS 3 PHASE, 3 WIRE WITH GROUND TAG TAG 20G 3#12, 1#12 GRD - 3/4"C 20NG 4#12, 1#12 GRD 30NG 4#10, 1#10 GRD 30G 3#10, 1#10 GRD - 3/4"C 40G 3#8, 1#10 GRD - 3/4"C 40NG 4#8, 1#10 GRD -55G 3#6, 1#10 GRD - 1"C 55NG 4#6, 1#10 GRD -70G 3#4, 1#8 GRD - 1 1/4"C 70NG 4#4, 1#8 GRD -85G 3#3, 1#8 GRD - 1 1/4"C 85NG 4#3, 1#8 GRD -95G 3#2, 1#8 GRD - 1 1/4"C 95NG 4#2, 1#8 GRD -110G 3#1, 1#6 GRD - 1 1/2"C 110NG 4#1, 1#6 GRD - 2 150G 3#1/0, 1#6 GRD - 1 1/2"C 150NG 4#1/0, 1#6 GRD 175G 3#2/0, 1#6 GRD - 2"C 175NG 4#2/0, 1#6 GRD 200G 3#3/0, 1#6 GRD - 2"C 200NG 4#3/0, 1#6 GRD 230NG 4#4/0, 1#4 GRD 230G 3#4/0, 1#4 GRD - 2"C 255G 3#250 KCMIL, 1#4 GRD - 2"C 255NG 4#250 KCMIL, 1# 285G 3#300 KCMIL, 1#4 GRD - 2 1/2"C 285NG 4#300 KCMIL, 1# 310G 3#350 KCMIL, 1#3 GRD - 2 1/2"C 310NG 4#350 KCMIL, 1#3 GRD - 3"C 380G 3#500 KCMIL, 1#3 GRD - 3"C 380NG 4#500 KCMIL, 1#3 GRD - 3 1/2"C 420G 3#600 KCMIL, 1#3 GRD - 3"C 420NG 4#600 KCMIL, 1#3 GRD - 3 1/2"C 510G 2@[3#250 KCMIL, 1#2 GRD - 2 1/2"C] 510NG 2@[4#250 KCMIL, 1#2 GRD - 2 1/2"C] 620G 2@[3#350 KCMIL, 1#1 GRD - 2 1/2"C] 620NG 2@[4#350 KCMIL, 1#1 GRD - 3"C] 760G 2@[3#500 KCMIL, 1#1/0 GRD - 3"C] 760NG 2@[4#500 KCMIL, 1#1/0 GRD - 3 1/2"C] 800G 2@[3#600 KCMIL, 1#1/0 GRD-3"C] 800NG 2@[4#600 KCMIL, 1#1/0 GRD-3 1/2"C] 1000G 3@[3#500 KCMIL, 1#2/0 GRD - 3"C] 1000NG 3@[4#500 KCMIL, 1#2/0 GRD - 3 1/2"C] 1200G 3@[3#600 KCMIL, 1#3/0 GRD - 3 1/2"C] 1200NG 3@[4#600 KCMIL, 1#3/0 GRD - 3 1/2"C] 1600NG 4@[4#600 KCMIL, 1#4/0 GRD - 3 1/2"C] 1600G 4@[3#600 KCMIL, 1#4/0 GRD - 3 1/2"C] 2000G 5@[3#600 KCMIL, 1#250 KCMIL GRD - 3 1/2"C] 2000NG 5@[4#600 KCMIL, 1#250 KCMIL GRD - 4"C]


.	TRA	ANSFORM	ER SEC	ONDARY WIRE SCHEDULE		
			СОРР	PER CONDUCTORS		
4 WIRE WITH GROUND	480-208/120V	3 PHASE, 4 WIRE WITH SUPPLY SIDE BONDING JUMPEI				
FILL	XMFR KVA	OCP	TAG	FILL		
4"C	15	60A	70NG	4#4, 1#8 GRD - 1 1/4"C		
I"C	30	100A OR 110A	110NG	4#1, 1#6 GRD - 2"C		
	45	175A	175NX	4#2/0, 1#4 GRD - 2"C		
."C	75	250A	255NX	4#250 KCMIL, 1#2 GRD - 2 1/2"C		
2	13	300A	310NX	4#350 KCMIL, 1#2 GRD - 3"C		
2	112.5	400A	420NX	4#600 KCMIL, 1#1/0 GRD - 3 1/2"C		
)	150	400A	420NX	4#600 KCMIL, 1#1/0 GRD - 3 1/2"C		
	130	500A	510NX	2@[4#250 KCMIL, 1#1/0 GRD - 2 1/2"C]		
	225	600A	620NX	2@[4#350 KCMIL, 1#2/0 GRD - 3"C]		
		800A	800NX	2@[4#600 KCMIL, 1#3/0 GRD - 3 1/2"C]		
2"C	300	800A	800NX	2@[4#600 KCMIL, 1#3/0 GRD - 3 1/2"C]		
9"C	300	1000A	1000NX	3@[4#500 KCMIL, 1#4/0 GRD - 3 1/2"C]		
D - 2 1/2"C						
RD - 3"C						
\$RD - 3"C						

1. GROUND WIRES SHOWN IN CONDUIT AND WIRE SCHEDULE ARE EQUIPMENT GROUNDING CONDUCTORS SIZED PER NEC 250.122.

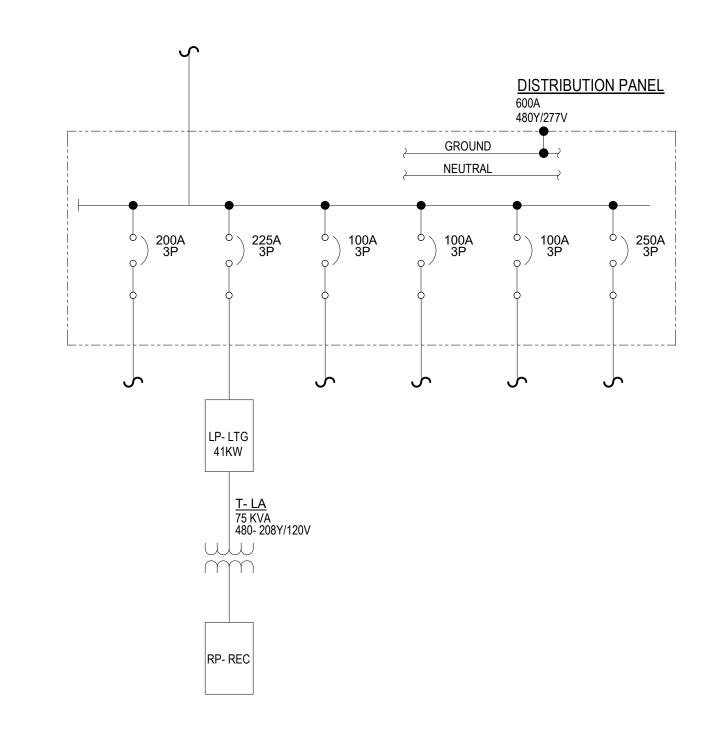- 2. GROUNDING ELECTRODE CONDUCTORS FOR SERVICE ENTRANCE AND FOR TRANSFORMER NEUTRALS SHALL BE SIZED PER NEC TABLE 250.66.
- 3. MAIN BONDING JUMPER AND SYSTEM BONDING JUMPER FOR MAIN SERVICE AND SEPARATELY DERIVED SYSTEMS SHALL BE SIZED PER NEC 250.28(D) AND TABLE 250.102(C)(1).
- 4. CONDUIT FILL BASED ON CONDUCTOR INSULATION TYPES AS INDICATED. CONDUIT FILL BASED ON EMT, IMC, RMC, FMC, LFMC, AND PVC SCHEDULE 40 CONDUIT TYPES. ALL OTHER CONDUIT TYPES, INCLUDING PVC SCHEDULE 80, SHALL BE SIZED PER NEC CHAPTER 9.
- 5. CONDUCTOR AMPACITY IS BASED ON TEMPERATURE RATING INDICATED AND NEC TABLE 310.15(B)(16).



PARTIAL ONE LINE DIAGRAM

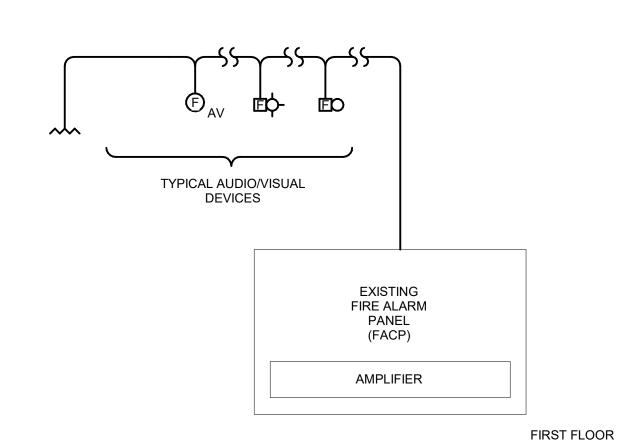

NOTES:

- 1. ELECTRICAL CONTRACTOR SHALL VERIFY ALL REQUIRED WIRE SIZES AND QUANTITIES WITH THE FIRE ALARM SYSTEM MANUFACTURER. ALL WIRING SHALL BE COLOR CODED AND CLEARLY
- 2. ALL WIRING INSULATION SHALL BE TYPE AS APPROVED PER THE FIRE ALARM CODE
- 2. ALL WIRING INSULATION SHALL BE TYPE AS APPROVED PER THE FIRE ALARM CODE REQUIREMENTS.

3. SCHEMATIC DIAGRAM INDICATES GENERAL LAYOUT & INTENT OF SYSTEM DESIGN. REFER TO

- POWER & AUXILLIARY SYSTEMS PLANS FOR EXACT QUANTITIES AND LOCATIONS OF DEVICES.

 4. NEW FIRE ALARM DEVICES CONNECTED TO EXISTING FIRE ALARM SYSTEM. EXISTING SYSTEM IS
- NATIONAL TIME AND SIGNAL.

 5. ALL SURFACE MOUNTED FIRE ALARM DEVICES SHALL BE INSTALLED IN WIREMOLD.

Fire Alarm Schematic Diagram



Project T

Van Buren Public Schools

RAHS Belleville High School

501 W Columbia Ave Belleville, MI 48111

Project Architect / Engineer
T. Morgan
Drawn By
T. Morgan
Q.M. Review
-Approved
-Drawing Scale

Issued for Issue Date
Design Development 07-03-2024

Diagrams and Details

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ī**D**§ Project Number

Drawing Number

24167-1000

E5.

OWNER FURNISHED EQUIPMENT

OCCUPANCY SENSOR

MOUNTING HEIGHT NOTES:

NOTED ON DRAWINGS.

LIGHTS MOUNTING HEIGHTS.

1. MOUNTING HEIGHTS ARE TYPICAL UNLESS OTHERWISE

2. FOR CEILING HEIGHTS BELOW 8'-4" REFER TO DRAWINGS

FOR CLOCKS, SPEAKERS, EXIT LIGHTS AND EGRESS

 $\bigcirc - \bigcirc - \bigcirc - \bigcirc -$

FLOOR

FOOT/FEET

ELEVATION NUMBER

- DRAWING WHERE

ELEVATION IS DRAWN

KVA

KVM

MOUNTING HEIGHTS

DISTRIBUTION OR POWER PANELBOARD

COMBINATION MAGNETIC MOTOR STARTER

SINGLE PHASE MOTOR

-SWITCH SIZE

-CB RATING

TRANSFORMER

GROUND ROD

DIG

N BC

THREE PHASE MOTOR

MAGNETIC MOTOR STARTER

- SWITCH SIZE / FUSE SIZE

NON-FUSED DISCONNECT SWITCH

FUSED DISCONNECT SWITCH

ENCLOSED CIRCUIT BREAKER

-SWITCH SIZE/FUSE SIZE

MAGNETIC CONTACTOR

MANUAL MOTOR STARTER

HORSEPOWER RATED SWITCH

PACKAGED EQUIPMENT WITH INTEGRALLY

FURNISHED AS INTEGRAL PART OF EQUIPMENT

MOUNTED PREWIRED CONTROL PANEL

LIGHTNING PROTECTION AIR TERMINAL

GROUND BUS BAR AS INDICATED

KILOVOLT AMPERE

KILOWATT

CATIONS OUNTED OUNTER DUPLEX EPTACLE ABOVE OUNTER

<u>AUXILIARY</u>

CEILING MOUNTED SINGLE FACED CLOCK

CEILING MOUNTED DOUBLE FACED CLOCK

WALL MOUNTED SINGLE FACED CLOCK

WALL MOUNTED DOUBLE FACED CLOCK

BIDIRECTIONAL WALL MOUNTED SPEAKER

CEILING MOUNTED SPEAKER CLUSTER

CEILING MOUNTED MICROPHONE OUTLET

WALL MOUNTED MICROPHONE OUTLET

WALL MOUNTED VOLUME CONTROL

WALL MOUNTED HORN SPEAKER

CEILING MOUNTED HORN SPEAKER

SECURITY SYSTEM ELECTRIC LATCH

SECURITY SYSTEM CARD READER

SECURITY SYSTEM DOOR CONTACT

SECURITY SYSTEM MOTION DETECTOR

CEILING MOUNTED SECURITY CAMERA

FIRE SUPRESSION SYSTEM CONTROL PANEL

FIRE ALARM REMOTE ANNUNCIATOR PANEL

BATHROOM STATION PULL CORD - NURSE CALL

SINGLE BED STATION - NURSE CALL

DOUBLE BED STATION - NURSE CALL

BATHROOM STATION - NURSE CALL

-ARROWS INDICATE FIELD OF VIEW

WALL MOUNTED SECURITY CAMERA

-ARROWS INDICATE FIELD OF VIEW

FIRE ALARM CONTROL PANEL

SECURITY SYSTEM KEY SWITCH

BIDIRECTIONAL CEILING MOUNTED SPEAKER

WALL MOUNTED DIGITAL CLOCK

CEILING MOUNTED SPEAKER

WALL MOUNTED SPEAKER

WALL MOUNTED BELL

0

WALL MOUNTED CHIME

COMBINATION WALL MOUNTED SPEAKER/CLOCK

CEILING MOUNTED COMBINATION SPEAKER/CLOCK

KEYBOARD / VIDEO / MOUSE

FLR

ELEVATION SYMBOL

COLUMN CENTERLINE

ROOM NAME AND NUMBER

NEW

SINGLE RECEPTACLE OUTLET

DUPLEX RECEPTACLE OUTLET

FAULT PROTECTION

SUPPRESSION

ROOM NAME

— – — – — – –

BUILDING OR UNIT (IF ANY)

SYMBOL LEGEND

DETAIL IDENTIFICATION

DRAWING WHERE DETAIL

IS REFERENCED OR CUT

- PLAN OR DETAIL IDENTIFICATION

WHERE PLAN OR

DETAILS IS DRAWN

SECTION IDENTIFICATION

- DRAWING WHERE PLAN OR

DETAIL IS DRAWN

SYMBOLS (LETTERS (X) INDICATE TYPE, TYPICAL. SEE ABBREVIATIONS ABOVE)

DUPLEX RECEPTACLE OUTLET FLUSH MOUNTED IN CEILING

DUPLEX RECEPTACLE OUTLET MOUNTED ABOVE COUNTER

DUPLEX RECEPTACLE OUTLET WITH INTEGRAL GROUND

FLUSH MOUNTED POWER ONLY FLOOR BOX

DUPLEX RECEPTACLE OUTLET CONNECTED TO

UPSTREAM GROUND FAULT PROTECTION DEVICE

DUPLEX RECEPTACLE OUTLET CONNECTED TO

UPSTREAM SURGE SUPPRESSION DEVICE

DUPLEX RECEPTACLE OUTLET SPLIT WIRED

QUAD RECEPTACLE OUTLET

SPECIAL RECEPTACLE AS INDICATED

POWER/COMMUNICATIONS POLE

POKE THROUGH ASSEMBLY

LETTERS INDICATE TYPE (TYP)

JUNCTION BOX - CEILING MOUNTED

INTERCOM CALL BUTTON WITH PRIVACY

EQUIPMENT MOUNTING BACKBOARD

JUNCTION BOX - WALL MOUNTED

INTERCOM CALL BUTTON

208/120V PANELBOARD

480/277V PANELBOARD

CORD DROP

BUS DUCT

DUPLEX RECEPTACLE OUTLET WITH INTEGRAL SURGE

DUPLEX RECEPTACLE OUTLET WITH ISOLATED GROUND

QUAD RECEPTACLE OUTLET MOUNTED ABOVE COUNTER

QUAD RECEPTACLE OUTLET WITH ONE (1) INTEGRAL

SURGE SUPPRESSION TYPE RECEPTACLE AND ONE (1)

PUSHBUTTON STATION - EMERGENCY POWER SHUTDOWN

HORIZONTALLY MOUNTED MULTI-OUTLET RACEWAY

VERTICALLY MOUNTED MULTI-OUTLET RACEWAY

SURGE SUPPRESSION PROTECTED RECEPTACLE

DETAIL SYMBOL

T2.1 DETAIL SCALE

PLAN OR DETAIL ENLARGEMENT

SECTION LOCATOR

T9.1

lacksquare

0 0 0 0

TECHNOLOGY DRAWING INDEX

TR.0 Technology Reference Information Enlarged Plans

T4.1 T7.1 Details INTEGRATED design SOLUTIONS architecture engineering interiors & technology 1441 west long lake, suite 200 troy, michigan 48098 5211 cascade road SE, suite 300 grand rapids, michigan 49546 248.823.2100

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GENERAL NOTES

WIRE GUARD

ONE-LINE

SYSTEM OR EQUIPMENT GROUND

RACEWAY TURNED UP

CABLE TRAY

RACEWAY TURNED DOWN

UNDERFLOOR DUCT - POWER

UNDERFLOOR DUCT - COMM

FLUSH IN-GRADE HAND HOLE

UNDERGROUND ELECTRICAL

UNDERGROUND FIBER OPTIC

UNDERGROUND LIGHTING

COMMUNICATIONS

UNDERGOUND COMMUNICATIONS

UNDERFLOOR HEADER DUCT - POWER

UNDERFLOOR HEADER DUCT - COMM

EXOTHERMIC WELD OR BRAZED CONNECTION

CONDUIT IN OR BELOW FLOOR SLAB OR BELOW GRADE

WEATHER PROOF

WIRELESS LOCAL AREA NETWORK

WLAN

CODE BLUE PUSHBUTTON - NURSE CALL

NURSE CALL WALL MOUNTED DOME LIGHT — P—

NURSE CALL CEILING MOUNTED DOME LIGHT —HP—

NURSE CALL WALL MOUNTED DOME LIGHT WITH CODE BLUE — C—

WALL MOUNTED COMMUNICATIONS OUTLET

ABOVE COUNTER COMMUNICATIONS OUTLET

CEILING MOUNTED COMMUNICATIONS OUTLET

-LETTER INDICATES FACEPLATE TYPE

WALL MOUNTED PROJETION SYSTEM

CEILING MOUNTED PROJETION SYSTEM

SHORT THROW PROJETION SYSTEM

COMMUNICATIONS FLOORBOX

MULTI-SYSTEM FLOORBOX

<u>—Е—</u>

—c—

NURSE CALL CEILING MOUNTED DOME LIGHT WITH CODE BLUE —HC—

NURSE CALL DUTY STATION ———

NURSE CALL EMERGENCY STATION ----

NURSE CALL MASTER STATION ———

NURSE CALL POWER SUPPLY ———

NURSE CALL STAFF STATION TITLE

- 1. LIGHT LINE WEIGHT INDICATES EXISTING EQUIPMENT TO REMAIN OR EQUIPMENT PROVIDED BY OTHERS. HEAVY LINE WEIGHT INDICATES
- NETWORK DEVICE PLATES AND THE CABLING FOR THESE AREAS SHALL BE PROVIDED BY THE TECHNOLOGY CONTRACTOR.
- LOCATIONS WITH THE ARCHITECTURAL AND CASEWORK DRAWINGS PRIOR TO ROUGH-IN. REPORT ANY CONFLICTS TO THE
- 4. TECHNOLOGY CONTRACTOR SHALL COORDINATE CLOSET ROOM
- 5. TECHNOLOGY CONTRACTOR SHALL NOT PLACE ANY DISTRIBUTION
- 6. ALL CABLES SHALL BE INSTALLED IN "J" HOOKS, CONDUITS, CABLE TRAY OR AN APPROVED RACEWAY SYSTEM. WHERE CABLE TRAY IS NOT AVAILABLE, SUPPORT HORIZONTAL CABLE EVERY FIVE FEET INCHES BETWEEN SUPPORTS, ADDITIONAL SUPPORTS SHALL BE INSTALLED TO TAKE UP SLACK AND RELIEVE CABLE STRESS. ALL STEEL. ALL COMMUNICATIONS CABLES SHALL BE LOCATED AND
- 7. INSTALL ALL CABLES MAINTAINING CABLE MANUFACTURES RADIUS OF CURVATURE AND PROTECT AT BENDS AND CORNERS. MAINTAIN MINIMUM BEND RADUIS AND TENSION LIMITATIONS AS SPECIFIED BY
- 8. LOOSELY BUNDLE CABLES WITH VELCRO TIES SUITABLE FOR PLENUM
- COMPLETION OF CABLE INSTALLATION. CABLES ARE FREE FROM TWISTS, KINKS, SHARP BENDS, CUTS, GOUGES OR ANY OTHER
- 10. THESE DRAWINGS ARE DIAGRAMMATIC AND INDICATE THE GENERAL ALL INCIDENTAL MATERIALS AND LABOR OR A COMPLETE, FULLY
- 13. SECURITY CAMERAS AND WIRELESS ACCESS POINT LOCATIONS
- 14. WIRELESS ACCESS POINTS ARE PROVIDED BY OWNER AND INSTALLED BY THIS CONTRACTOR. THIS CONTRACTOR IS TO PROVIDE 10' PATCH

- NEW EQUIPMENT.
- 3. TECHNOLOGY CONTRACTOR SHALL COORDINATE DEVICE OUTLET CONSTRUCTION MANAGER FOR RESOLUTION.
- EQUIPMENT/DEVICE LOCATIONS WITH THE GENERAL TRADES.
- CABLING ALONGSIDE POWERLINES, OR SHARE THE SAME CONDUIT, CHANNEL OR SLEEVE WITH ELECTRICAL APPARATUS.
- WITH "J" HOOKS SUFFICIENT IN SIZE TO HANDLE ALL BUNDLED CABLES WHILE MINIMIZING CRUSHING. IF CABLE SLACK EXCEEDS TWELVE (12 CABLES SHALL BE RUN PARALLEL AND PERPENDICULAR TO BUILDING FASTENED TO GUARANTEE THERE SHALL BE NO INTERFERENCE FROM MAGNETIC FIELDS GENERATED FROM FIXTURE BALLASTS, MOTORS OR SIMILAR ELECTRICAL LOADS.
- EIA/TIA FOR ALL COMMUNICATION CABLES.
- ENVIRONMENTS, EVERY TWENTY FEET.
- 9. THE TECHNOLOGY CONTRACTOR SHALL ASSURE THAT THE PHYSICAL DAMAGE.
- EXTENT OF WORK. THE TECHNOLOGY CONTRACTOR SHALL PROVIDE FUNCTIONAL SYSTEM AND VERIFING FIELD RACEWAYS.
- 11. NOTIFY CM OF ANY CONFLICTS BETWEEN EQUIPMENT SUBMITTALS AND TECHNOLOGY DRAWINGS.
- 12. ALL WORK AND EQUIPMENT SHALL CONFORM TO NEC. THE MEANS AND METHODS USED BY TECHNOLOGY CONTRACTOR SHALL CONFORM TO NEC SECTION 110-3.
- INDICATED ARE FOR NETWORK CABLING ONLY.
- CORDS FOR EACH WIRELESS ACCESS POINT.
- 15. SECURITY CAMERAS ARE BY OTHERS. THIS CONTRACTOR IS TO PROVIDE 10' PATCH CORDS FOR EACH SECURITY CAMERA.

Van Buren Public Schools

RAHS Belleville High School

501 W Columbia Ave Belleville, MI 48111

THIS PROJECT MAY NOT UTILIZE ALL THE SYMBOLS, MATERIALS, ABBREVIATIONS AND STANDARDS INFORMATION SHOWN ON THIS SHEET

Project Administrator A. Maurer Project Designer J. Brender, T. Horner Project Architect / Engineer T. Morgan Drawn By T. Horner Q.M. Review Drawing Scale No Scale Issue Date Issued for Design Development 07-03-2024

Technology Reference Information

 \circ 2024 Integrated $ext{design}$ solutions, LL

ī**D**§ Project Number

Drawing Number

TR.0

1. SEE SHEET T7.1 FOR TECHNOLOGY DETAILS AND DEVICE SCHEDULES.


ALL DATA CABLES SHALL BE TERMINATED ON NEW 48 PORT CAT 6 PATCH PANEL LOCATED IN MDF/DHE.




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FIRST FLOOR NEW TECHNOLOGY PLAN



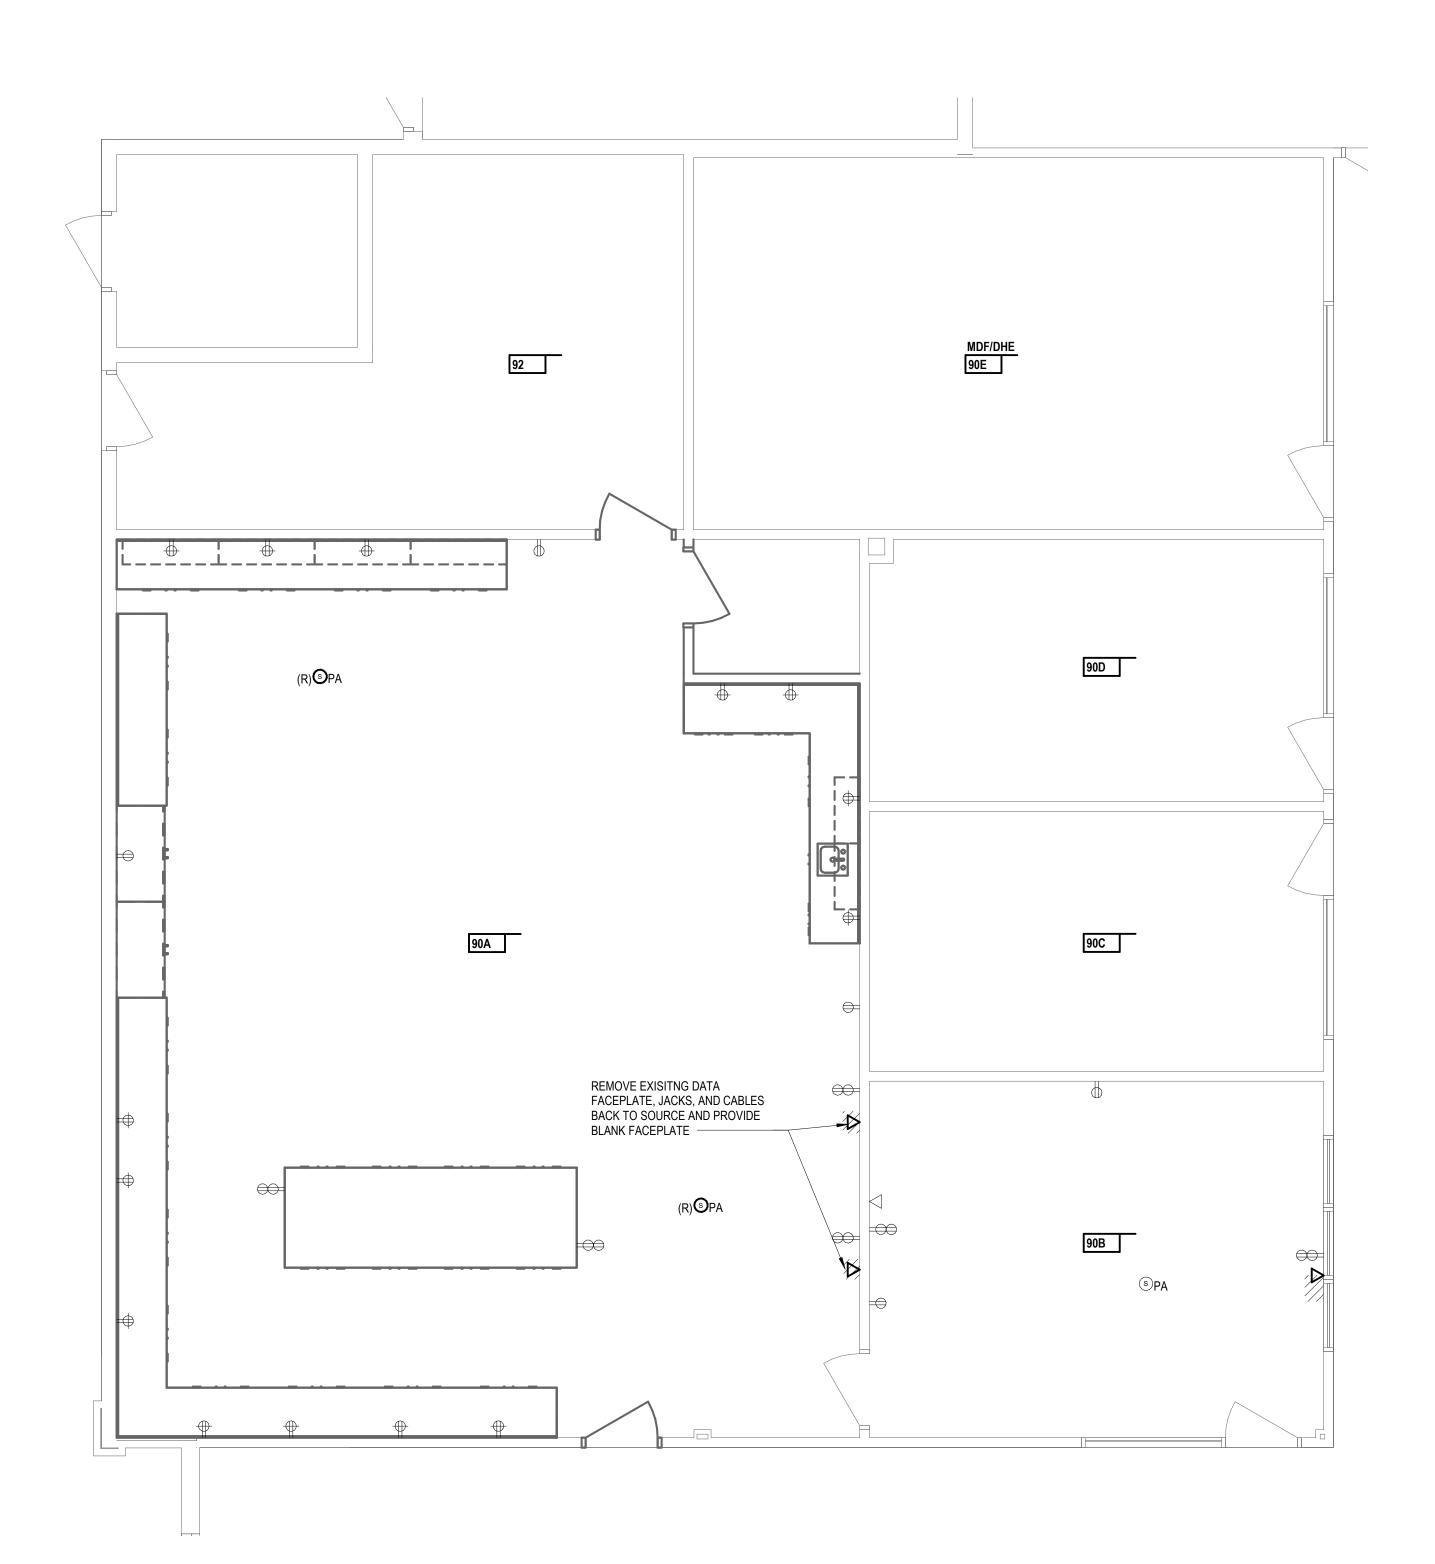
FIRST FLOOR TECHNOLOGY DEMOLITION PLAN



RAHS Belleville High School

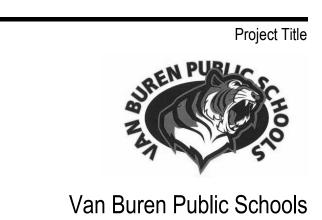501 W Columbia Ave Belleville, MI 48111

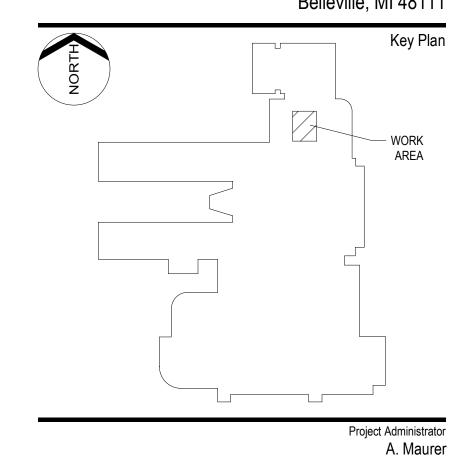Project Designer
J. Brender, T. Horner
Project Architect / Engineer
T. Morgan



	Diawii by
	T. Horne
	Q.M. Review
	Approved
	-
	Drawing Scale
	As Indicated
Issued for	Issue Date
Issued for Design Development	07-03-2024

 \circ 2024 Integrated ${f design}$ solutions, LLC


Enlarged Plans

ī**D**§ Project Number


	DATA DEVICE SCHEDULE1								
DROP ID	SOURCE TR	DESCRIPTION	DATA RACK ID	CATEGORY 6 CABLE COUNT	FACEPLATE TYPE				
90B-1	MDF/DHE	WALL DROP		2	Α				
103-1	MDF/DHE	WALL DROP		2	Α				
103-2	MDF/DHE	DISPLAY DROP		1	В				
104-1	MDF/DHE	WALL DROP		2	Α				
104-2	MDF/DHE	DISPLAY DROP		1	В				
107-1	MDF/DHE	WALL DROP		2	Α				
107-2	MDF/DHE	WALL DROP		2	Α				
112-1	MDF/DHE	WALL DROP		2	Α				
112-2	MDF/DHE	WALL DROP		2	Α				

WAP DEVICE SCHEDULE								
DROP ID	SOURCE TR	DESCRIPTION	DATA RACK ID	CATEGORY 6 CABLE COUNT	FACEPLATE TYP			
106-1	MDF/DHE	CEILING MOUNTEDE WAP		1				
112-3	MDF/DHE	CEILING MOUNTEDE WAP		1				


	SECURITY CAMERA SCHEDULE								
DDOD ID	OOLIDOE TD	OAMEDA DECODIDITION	CAMERA	CATEGORY 6	CAMERA MORE	EDAME DATE			
DROP ID	SOURCE IR	CAMERA DESCRIPTION	TYPE	CABLE	CAMERA MODEL	FRAME RATE			
CAM-01	MDF/DHE	INTERIOR CEILING MOUNTED CAMERA	Χ	1					

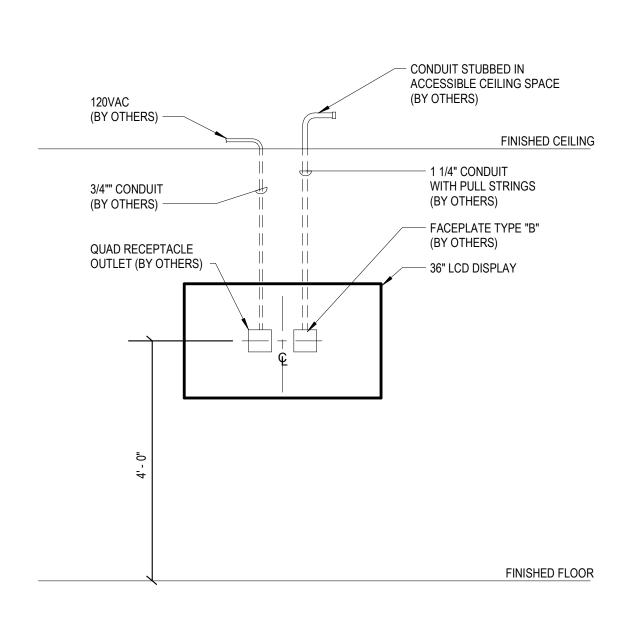




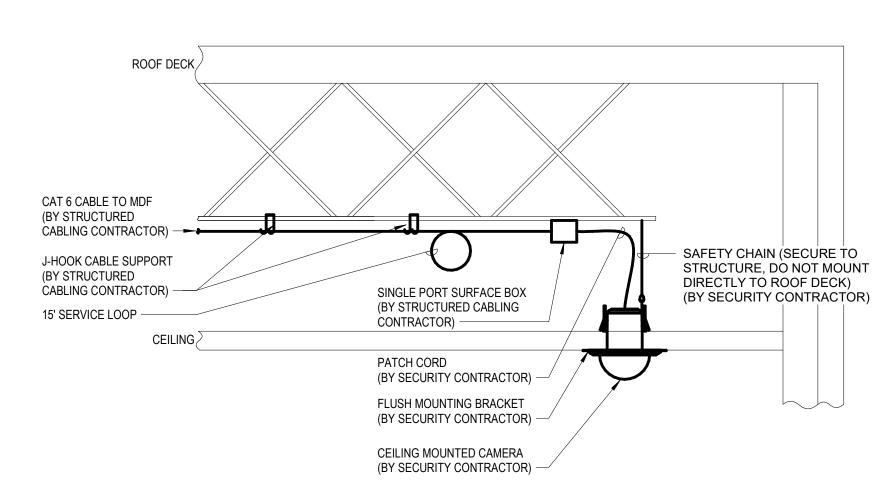


CEILING MOUNTED CAMERA DETAIL

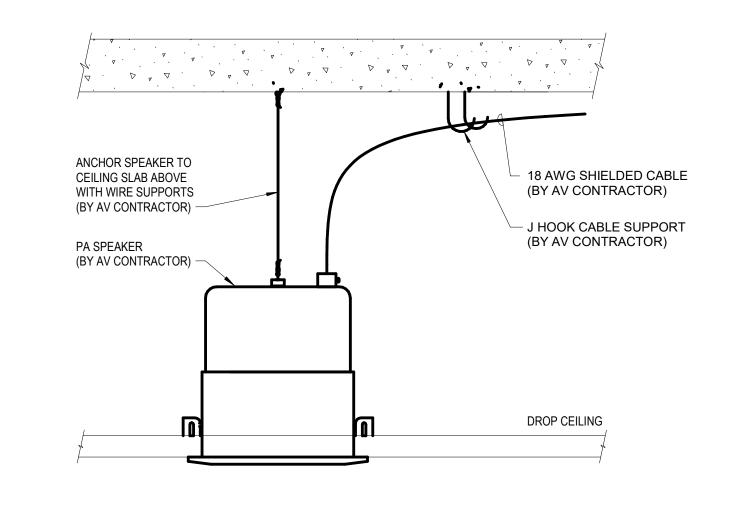




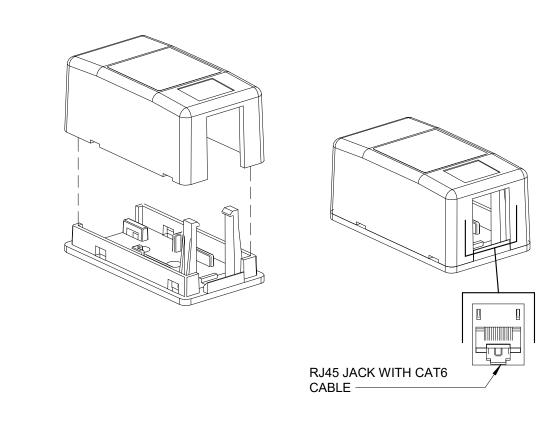




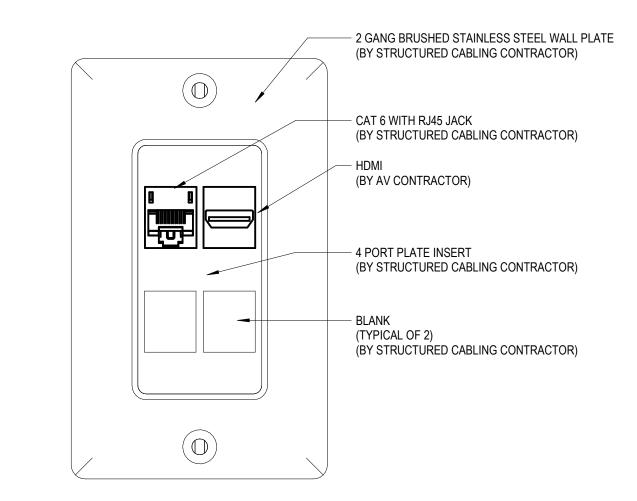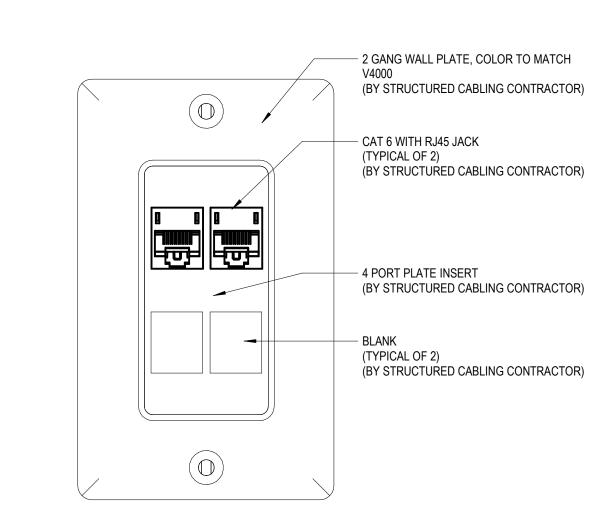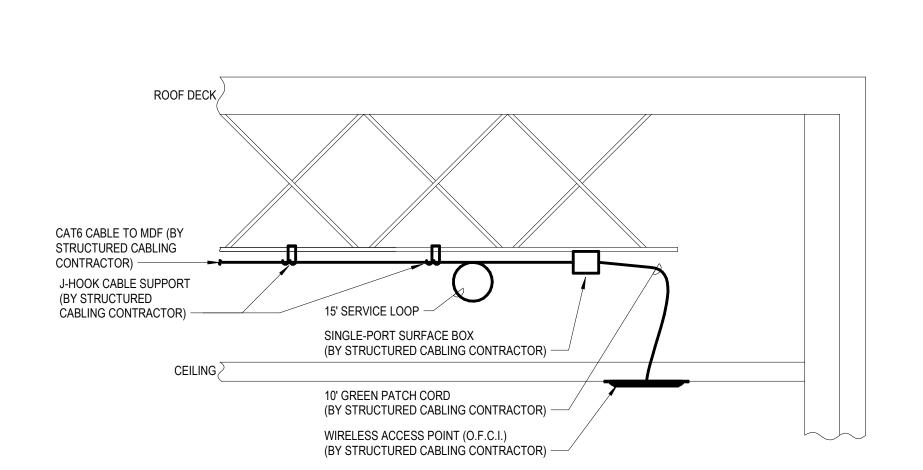










CEILING-MOUNTED WAP DETAIL
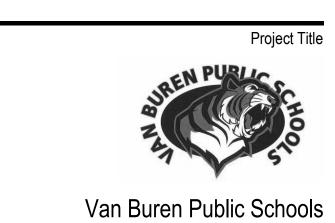
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