
GENERAL NOTES

- DO NOT SCALE DRAWINGS. USE DIMENSIONS GIVEN OR FIELD VERIFY IF NECESSARY.
- 2 ONLY DOCUMENTS INDICATED AS "BIDDING" OR "CONSTRUCTION" ARE TO BE USED FOR BIDDING OR CONSTRUCTION.
- THE REQUIREMENTS OF ICC/ANSI A117.1 AND THE AMERICANS WITH DISABILITIES ACT (ADA) ARE TO BE FULLY SATISFIED. ALL WORK SHALL MEET THE MOST STRINGENT REQUIREMENTS OF BOTH INCLUDING, BUT NOT LIMITED TO CLEARANCES, LIMITATIONS, ACCESSORIES, ETC. THESE DRAWINGS ARE PREPARED IN ACCORDANCE WITH THE LIMITED SERVICES FOR WHICH THE ARCHITECT WAS CONTRACTED. THE ARCHITECT MAKES NO REPRESENTATION THAT THE INTERPRETATION OF THESE DOCUMENTS WILL RESULT IN COMPLETE COMPLIANCE WITH THE ADA.
- 4 ALL GLASS SHALL CONFORM TO FS DD-G-451. SAFETY GLASS SHALL CONFORM TO U.S. CONSUMERS PRODUCT SAFETY COMMISSION STANDARD 16 CFR 1201.
- 5 ALL DOORS REQUIRED TO BE LABELED SHALL BE SET IN LABELED FRAMES AND IDENTIFIED WITH UL LABEL AND PROVIDED WITH APPROVED SELF—CLOSING DEVICES AND POSITIVE LATCHING HARDWARE.
- 6 CONTRACTOR TO VERIFY MECHANICAL EQUIPMENT UNIT LOADS AND LOCATIONS, IF NOT INDICATED ON PLAN, AND REPORT TO ARCHITECT PRIOR TO ERECTION.
- 7 ALL DESIGNATED EXIT DOORS SHALL BE EQUIPPED WITH NON-LOCKING AGAINST EGRESS HARDWARE.
- 8 PLASTIC PIPING, INSULATION AND OTHER COMBUSTIBLE MATERIALS SHALL BE RESTRICTED TO USE WHERE PERMITTED BY CODE AND IN NON-COMBUSTIBLE WALLS AND CEILING SPACES THAT DO NOT CONNECT DIRECTLY TO OCCUPIED ROOMS OR VENTILATING AIR DUCTS OR SPACES, IN ACCORDANCE WITH THE MICHIGAN STATE FIRE MARSHAL REGULATIONS. PROVIDE STEEL PIPING FOR ALL PLASTIC PIPING PASSING THROUGH FIREWALLS. RATED SHAFT WALLS SHALL BE DESIGNATED AS SUCH IN ACCORDANCE WITH 2015 MICHIGAN BUILDING CODE SECTION 703.7.
- 9 ALL SIGNAGE THAT PROVIDES EMERGENCY INFORMATION OR GENERAL CIRCULATION DIRECTIONS OR SPACE IDENTIFICATION SHALL COMPLY WITH THE MOST STRINGENT OF ANSI A117.1 AND THE AMERICANS WITH DISABILITIES
- 10 WHEN REQUIRED, PORTABLE FIRE EXTINGUISHERS SHALL BE FURNISHED BY THE OWNER AND INSTALLED IN ACCORDANCE WITH NFPA 10.
- 11 ALL FINISH LUMBER SHALL HAVE A MOISTURE CONTENT OF 9% OR LESS.
- 12 PROVIDE FIRE RETARDANT TREATED (FRT) WOOD BLOCKING WHERE REQUIRED TO SUPPORT ITEMS MOUNTED TO PARTITIONS AND AROUND ALL DOOR OPENINGS, ETC. ALL LUMBER REQUIRED TO BE FIRE TREATED SHALL BEAR THE UL FR-S LABEL.
- 13 ALL INTERIOR FINISHES SHALL MEET THE FLAME SPREAD AND SMOKE DEVELOPED REQUIREMENTS OF MBC 2015, CHAPTER 8 "INTERIOR FINISHES".
- 14 ALL INTERIOR METAL STUD PARTITIONS ARE TO BE DESIGNED TO WITHSTAND A UNIFORM LATERAL LOAD OF 5 P.S.F. BRACE WALLS TO THE STRUCTURE AS REQUIRED. SUBMIT SHOP DRAWINGS TO THE ARCHITECT FOR APPROVAL PRIOR TO CONSTRUCTION.
- 15 UNLESS NOTED OTHERWISE, PRODUCTS SHALL BE INSTALLED PER MANUFACTURERS SPECIFICATIONS. CONTRACTOR TO PROVIDE ALL PRODUCT WARRANTIES AND INFORMATION TO PROPERTY MANAGER UPON COMPLETION OF CONSTRUCTION.
- 16 ALL MECHANICAL/ELECTRICAL ENGINEERING SHALL
 BE PERFORMED ON A "DESIGN—BUILD" BASIS BY
 THE OWNER'S RESPECTIVE CONTRACTORS. ANY
 M/E ITEMS SHOWN HERE ARE FOR GENERAL
 REFERENCE ONLY.
- 17 EXISTING EXIT AND EMERGENCY LIGHTING SHALL REMAIN AS—IS.
- 18 ALL STUD WALLS ARE TO BE FIRE—STOPPED AT CEILINGS.

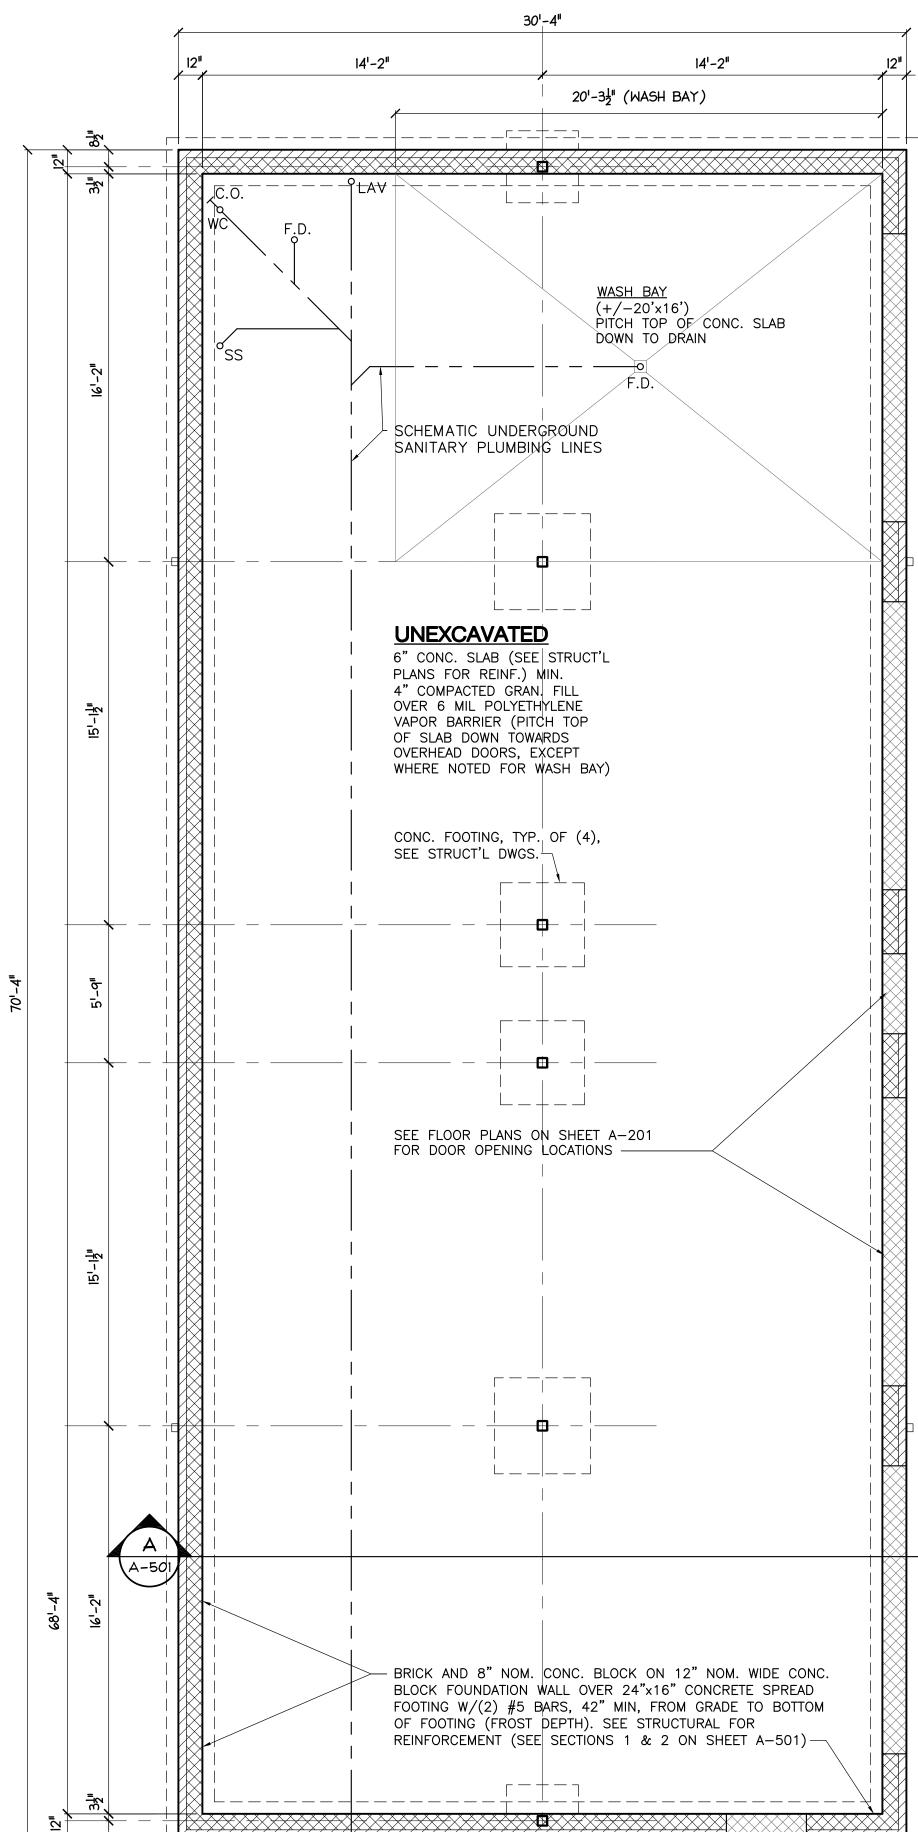

O 2' 4' 8' GRAPHIC SCALE



SHEET INDEX

A-101 FOUNDATION AND ROOF PLANS
A-201 FLOOR PLANS
A-301 REFLECTED CEILING PLANS

A-301 REFLECTED CEILING PLANS

A-401 BUILDING ELEVATIONS

A-501 BUILDING SECTIONS & DETAILS

S-01 STRUCTURAL (FOUNDATION & FLOOR FRAMING)

S-02 STRUCTURAL (ROOF FRAMING & SECTIONS)
S-03 STRUCTURAL (NOTES & SPECIFICATIONS)

BUILDING CODE COMPLIANCE: INTERPRETIVE CODES:

BUILDING = MICHIGAN BUILDING CODE (MBC) 2015

PLUMBING = MICHIGAN PLUMBING CODE 2021

MECHANICAL = MICHIGAN MECHANICAL CODE 2021

ELECTRICAL = MICHIGAN ELECTRICAL CODE 2023

BUILDING CODE ANALYSIS:

USE GROUP: B/S-1/U (NON-SEPARATED OCCUPANCIES PER 2015 MBC 508.3)

CONSTRUCTION TYPE: VA (COMBUSTIBLE, ONE—HOUR PROTECTED STRUCTURE), UNSPRINKLERED (NS)

STORIES: TWO (2) PROPOSED,
TWO ALLOWABLE PER 2015 MBC TABLE 504.4

HEIGHT: +/-30 FEET FROM CHASE ROAD GRADE, ALLOWABLE=50FT PER 2015 MBC 504.3

TOTAL AREA: 2,100 GROSS S.F. PER FLOOR (TOTAL 4,200 S.F.),
9,000 S.F. ALLOWABLE PER 2015 MBC TABLE 506.2

EGRESS DESIGN OCCUPANT LOAD

(per 2015 MBC Table 1004.1.2)


1st Floor


Garage Parking (U) = 1,642 S.F. / 200 S.F. = 9 OCCUPANTS Storage/Mech. (S-1) = 458 S.F./300 S.F. = 2 OCCUPANTS


2nd Floor
Office (B) = 2,034

ice (B) = 2,034 S.F./100 S.F. = 21 OCCUPANTS tals: 4,134 S.F. 32 OCCUPANTS

NOTE THAT MAX. OCCUPANCY DURING OPERATION WILL BE 15 OR FEWER PERSONS PER TENANT'S AFFADAVIT

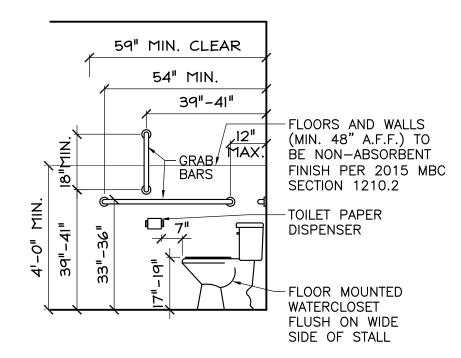

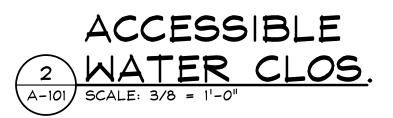

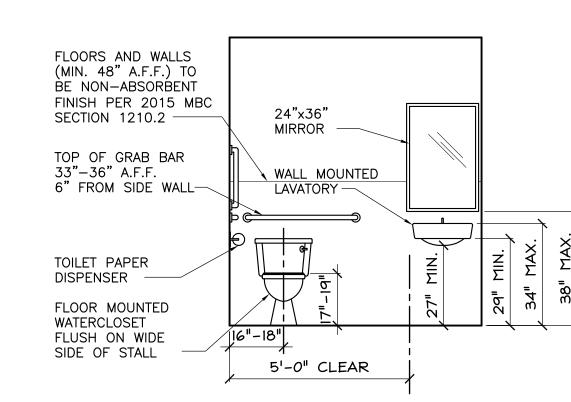

ACCESSIBLE

NATER CLOS.

SCALE: 3/8 = 1'-0"

associates, inc. interior designers

smith + schurman ass architects = planners = inter PO Box 1607, Southgate, MI 48195

Sr Out

ION AND ROOF PLAI BUILDING FOR:

4

NEW GARAGE/OFFICE BU SPECIAL TREE 39165 CHASE ROAD

ISSUE DATE

SCHEME May 19, 2023

REVISED May 23, 2023

REVISED June 20, 2023

REVISED July 18, 2023

PRELIM. Dec. 18, 2023

REVIEW Feb. 09, 2024

REVISED Jan. 14, 2025

This document and the subject matter contained herein are proprietary and are not to be used or reproduced without written consent of Smith + Schurman Associates, inc.

DRAWN BY:

JN

CHECKED BY:


JOB NO: 23-9271

SHEET NUMBER:

A-101





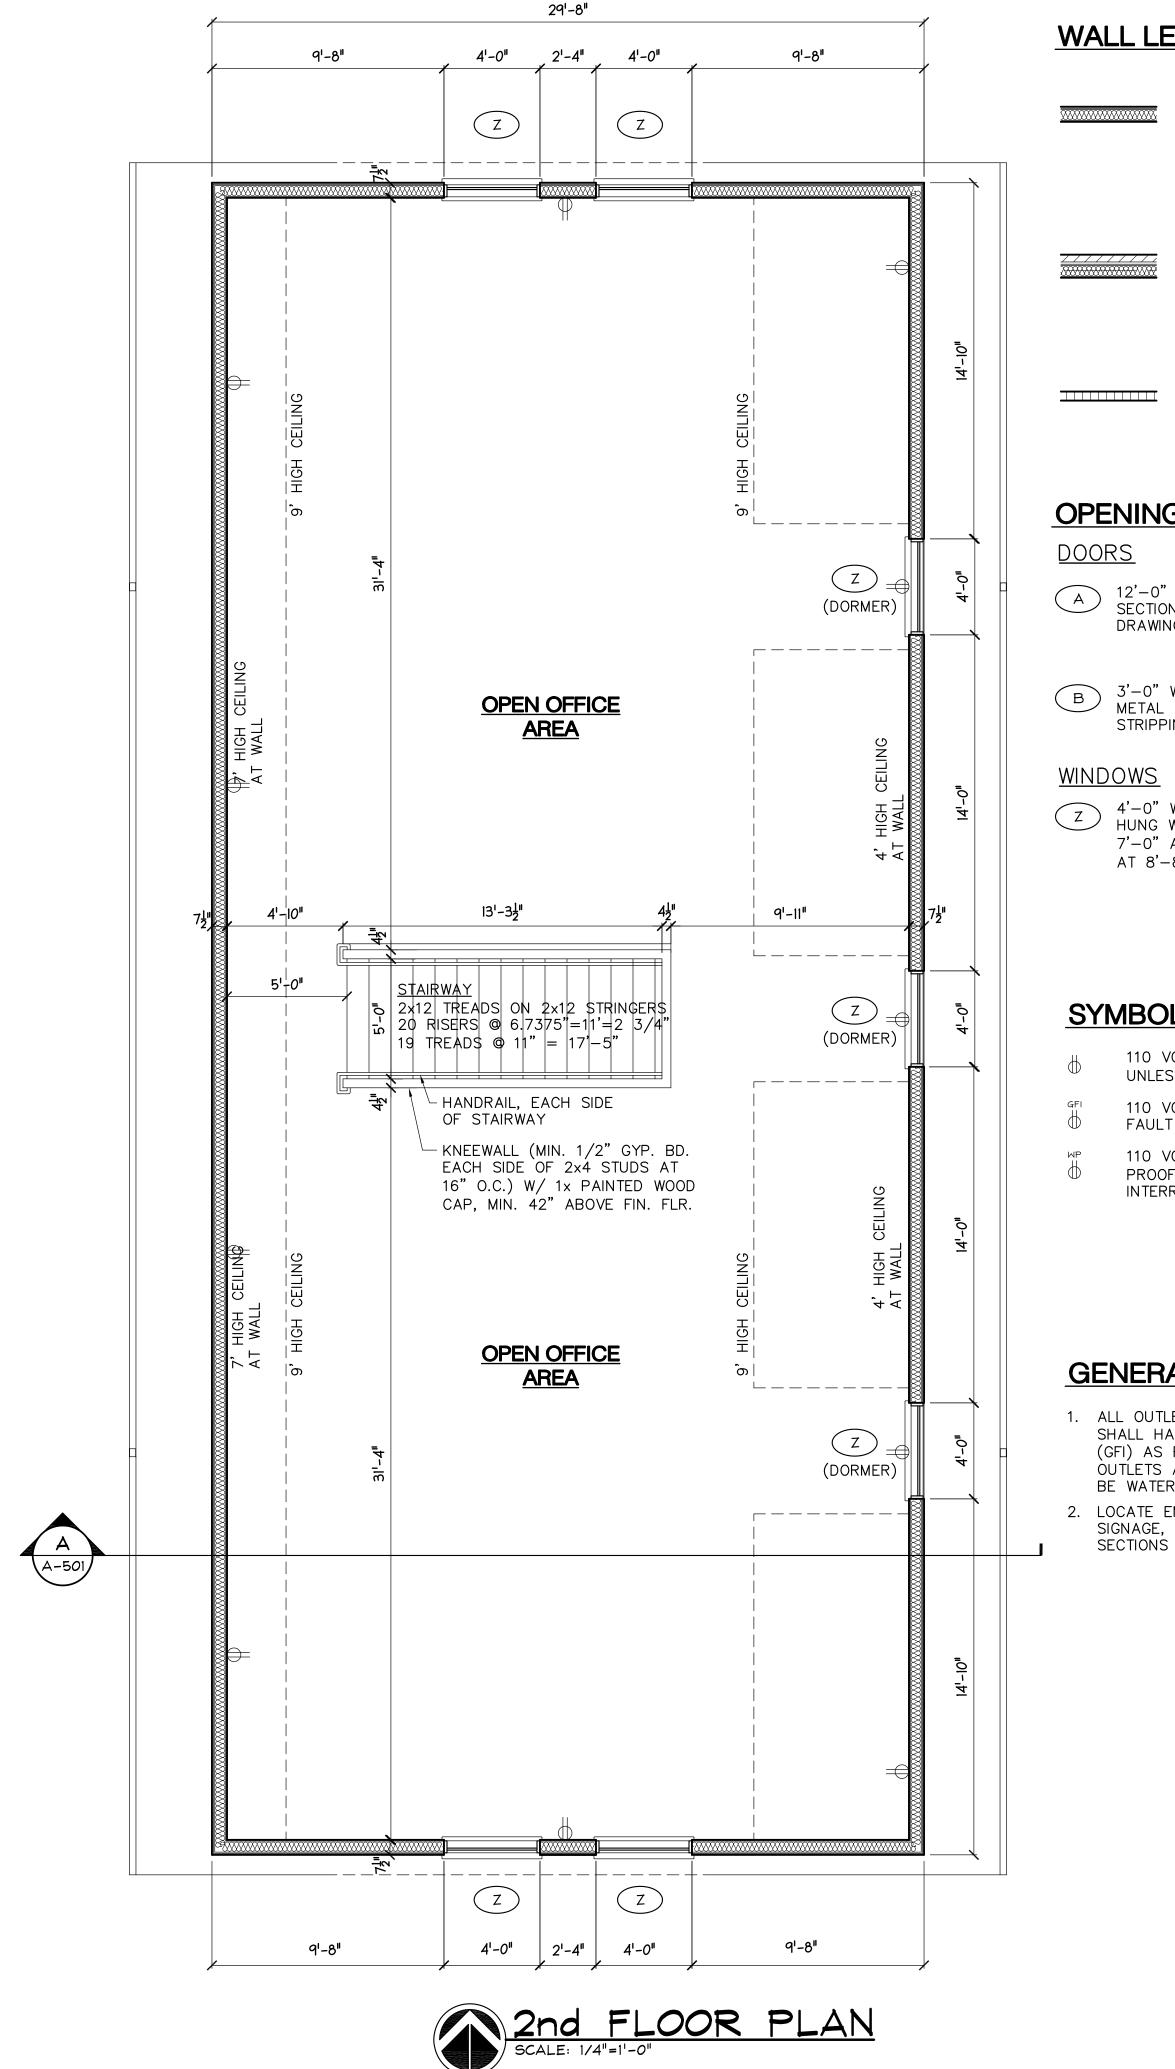

WALL LEGEND

+/- 7-1/2" NOM. WIDTH: VINYL LAP SIDING OVER MOISTURE BARRIER ON 5/8" WD. SHEATHING FASTENED TO 2x6 WOOD STUDS AT 16"O.C. W/ SOLID FILL INSUL. BETWEEN (R-21). INTERIOR TO BE 5/8" GYPSUM BD (PAINTED) UNLESS NOTED OTHERWISE. (SEE SECTIONS 1 & 2 SHEET A-501)

ON SHEET A-501)

+/- 11-1/2" NOM. WIDTH: BRICK (UP TO 48" A.F.F.), AIR SPACE, MOISTURE BARRIER ON 5/8" WD. SHEATHING FASTENED TO 2x6 WOOD STUDS AT 16" O.C. W/ SOLID FILL INSULATION BETWEEN (R-21). INTERIOR TO

(INTERIOR) 1/2" GYPSUM BOARD (PAINTED UNLESS NOTED OTHERWISE) EACH SIDE OF 2x4 WOOD STUDS AT 16" O.C.. 2nd FLOOR SHALL BE A KNEEWALL MIN. 42" A.F.F. WITH PAINTED 1x WOOD CAP

BE 5/8" GYPSUM BD (PAINTED) UNLESS

NOTED OTHERWISE. (SEE SECTIONS 1 & 2

OPENING SCHEDULE

- 12'-0" WIDE X 8'-0" HIGH INSULATED SECTIONAL OVERHEAD DOOR. SEE STRUCTURAL DRAWINGS FOR HEADER AND BEARING
- 3'-0" WIDE X 7'-0" HIGH INSULATED HOLLOW METAL DOOR WITH ALUM. THRESH AND WEATHER STRIPPING

4'-0" WIDE x 3'-0" WIDE OPERABLE DOUBLE HUNG WINDOW. TOP OF HEADER SHALL BE AT 7'-0" A.F.F. EXCEPT DORMER WINDOWS TO BE AT 8'-8" A.F.F.


SYMBOL LEGEND

- 110 VOLT DUPLEX RECEPTACLE (18" A.F.F. UNLESS NOTED OTHERWISE)
- 110 VOLT DUPLEX RECEPTACLE W/ GROUND FAULT INTERRUPTION
- 110 VOLT DUPLEX RECEPTACLE IN WEATHER-PROOF HOUSING W/ GROUND FAULT INTERRUPTION

GENERAL ELECTRICAL NOTES

- 1. ALL OUTLETS WITHIN 72" OF PLUMBING FIXTURES SHALL HAVE GROUND FAULT INTERRUPTOR CIRCUIT (GFI) AS REQUIRED BY NEC. ALL EXTERIOR OUTLETS AND OUTLETS IN WASH BAY AREA SHALL BE WATERPROOF WITH GFI.
- LOCATE EMERGENCY EGRESS LIGHTING AND EXIT SIGNAGE, IF REQURIED, TO MEET 2015 MBC SECTIONS 1008 AND 1013.


GRAPHIC SCALE

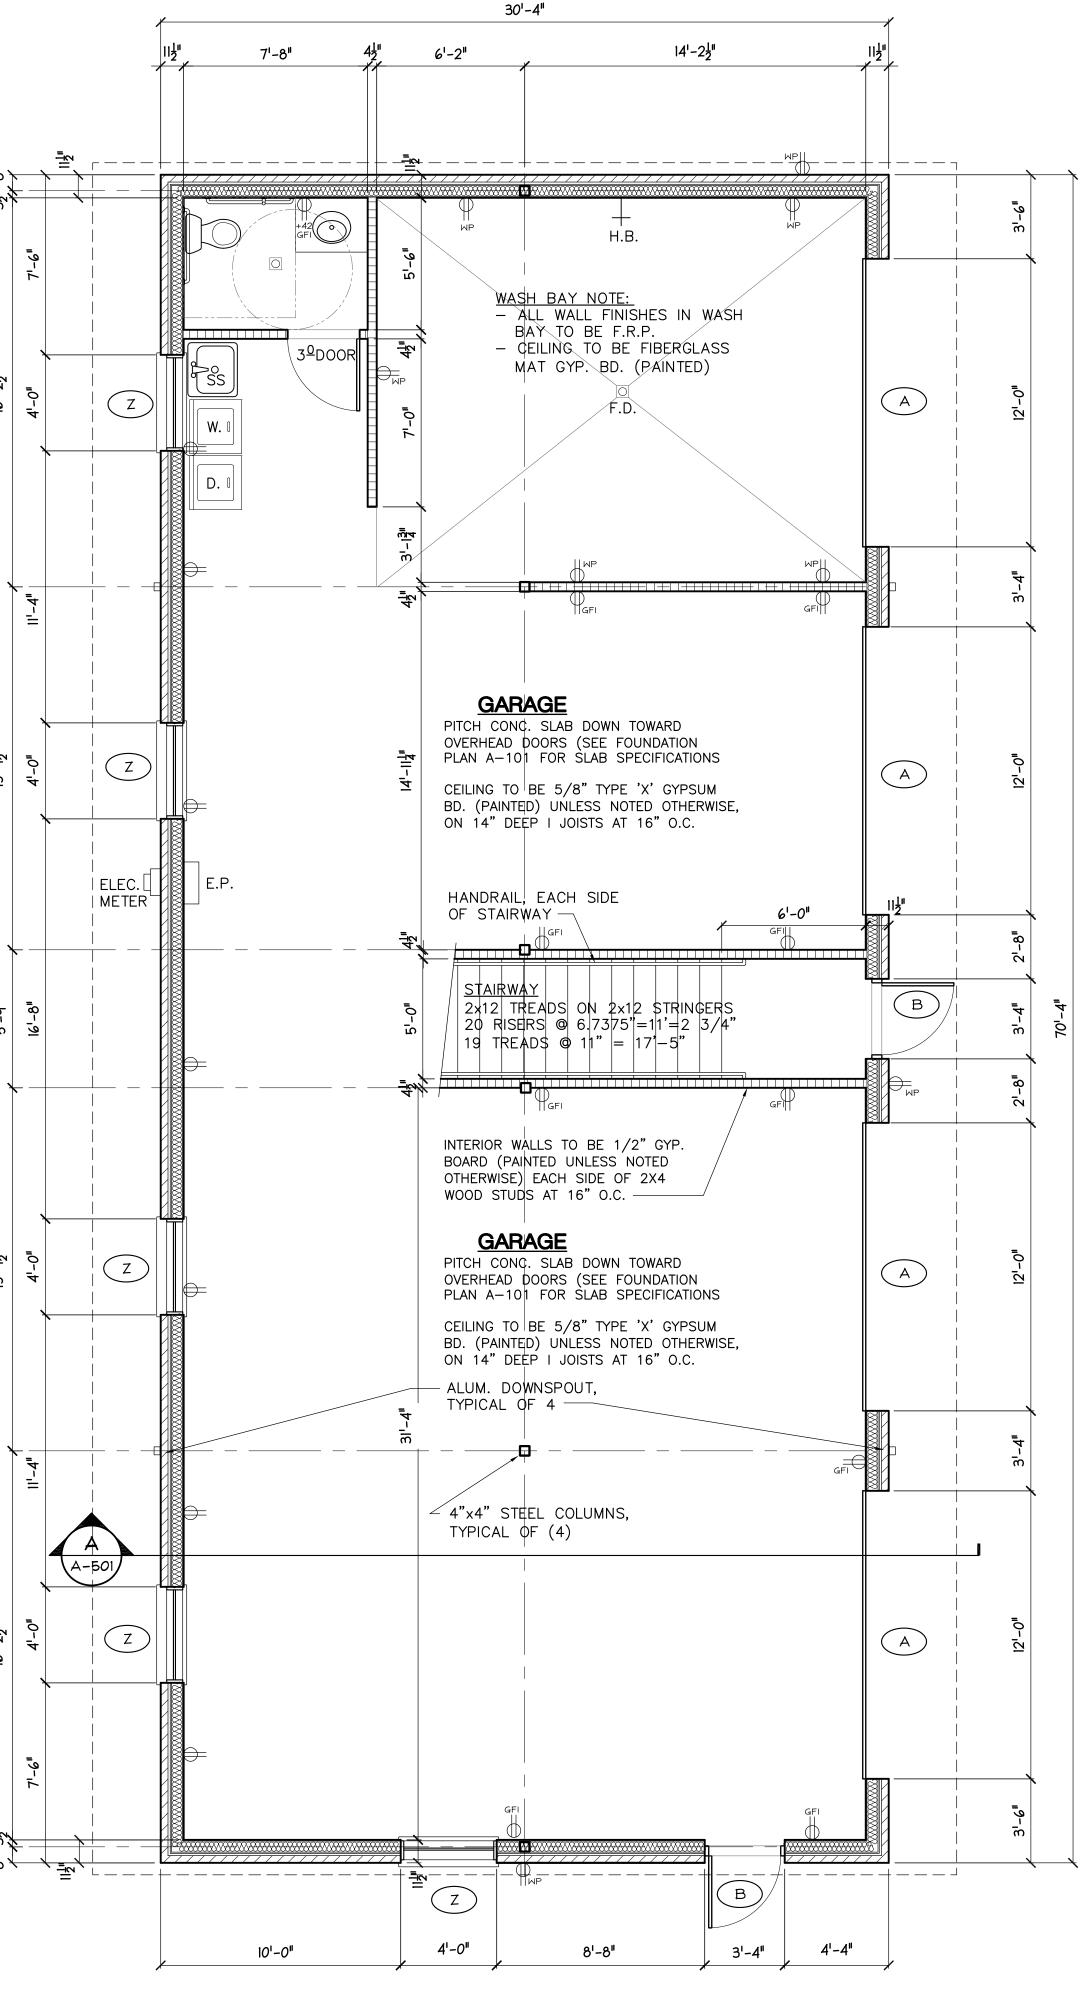



GROUND FLOOR PLAN

SCALE: 1/4"=1'-0"

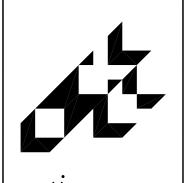

associates, terior designe ⊇. ס + schurmar


ANS BUILDING

SCHEME May 19, 2023 REVISED May 23, 2023 REVISED June 20, 2023 REVISED July 18, 2023 PRELIM. Dec. 18, 2023 REVIEW Feb. 09, 2024 REVISED Jan. 14, 2025


This document and the subject natter contained herein are proprietary and are not to b used or reproduced without written consent of Smith + DRAWN BY:

CHECKED BY: 23-9271 IOB NO:

HEET NUMBER: A-201

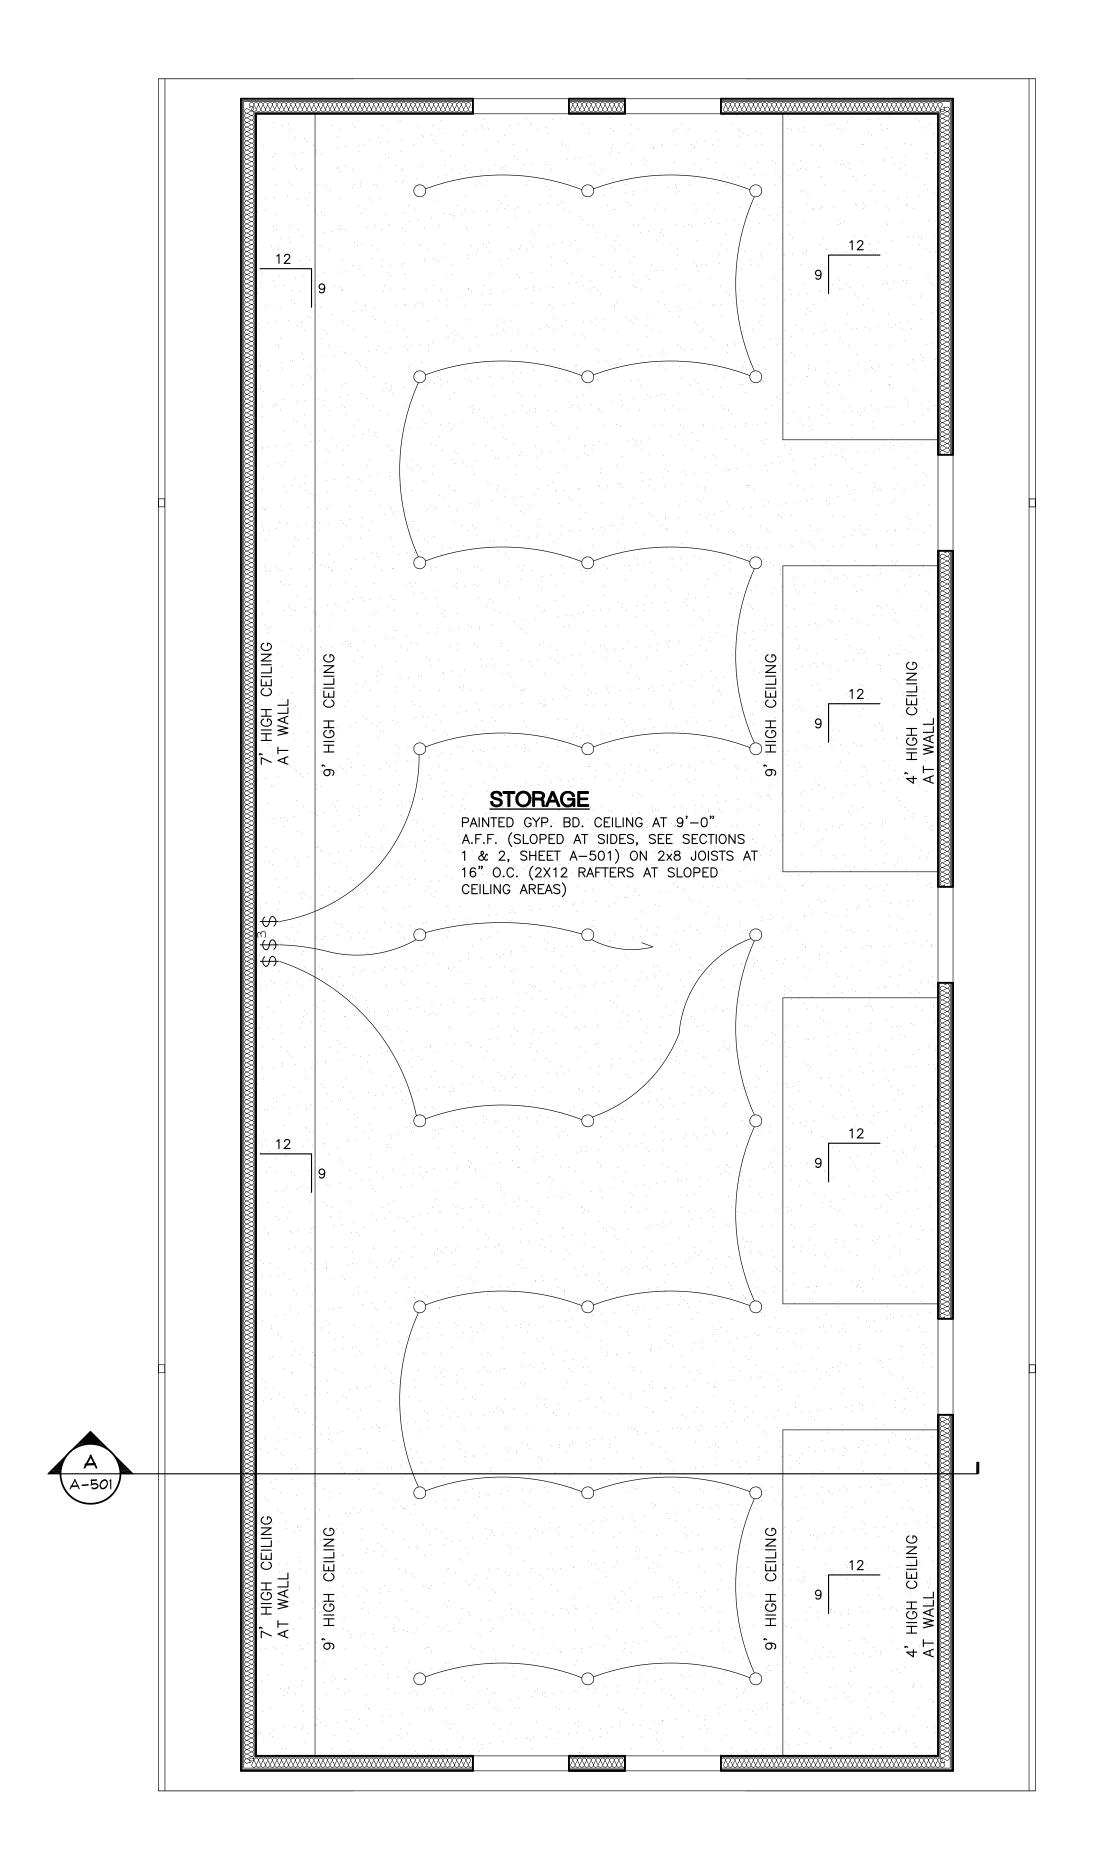



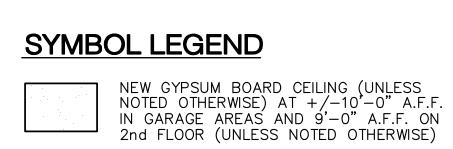


O 6" DIA. RECESSED 'CAN' LIGHT WITH LED LAMP. INSTALL WATERPROOF FIXTURES IN WASH BAY

₩ WALL MOUNTED SCONCE LUMINAIRE

MOTOR (CEILING MOUNTED GARAGE DOOR OPENER)

\$ SINGLE POLE SWITCH, LIGHT SWITCHES SHALL
BE 0-10V DIMMING CONTROLS AND HAVE
OCCUPANCY/VACANCY SENSOR SET TO
AUTOMATICALLY TURN ON AT 70% (WITH
MANUAL ADJUSTMENT CONTROLS)


\$3 DOUBLE POLE (3-WAY) LIGHT SWITCH AS NOTED FOR LIGHT SWITCHES ABOVE

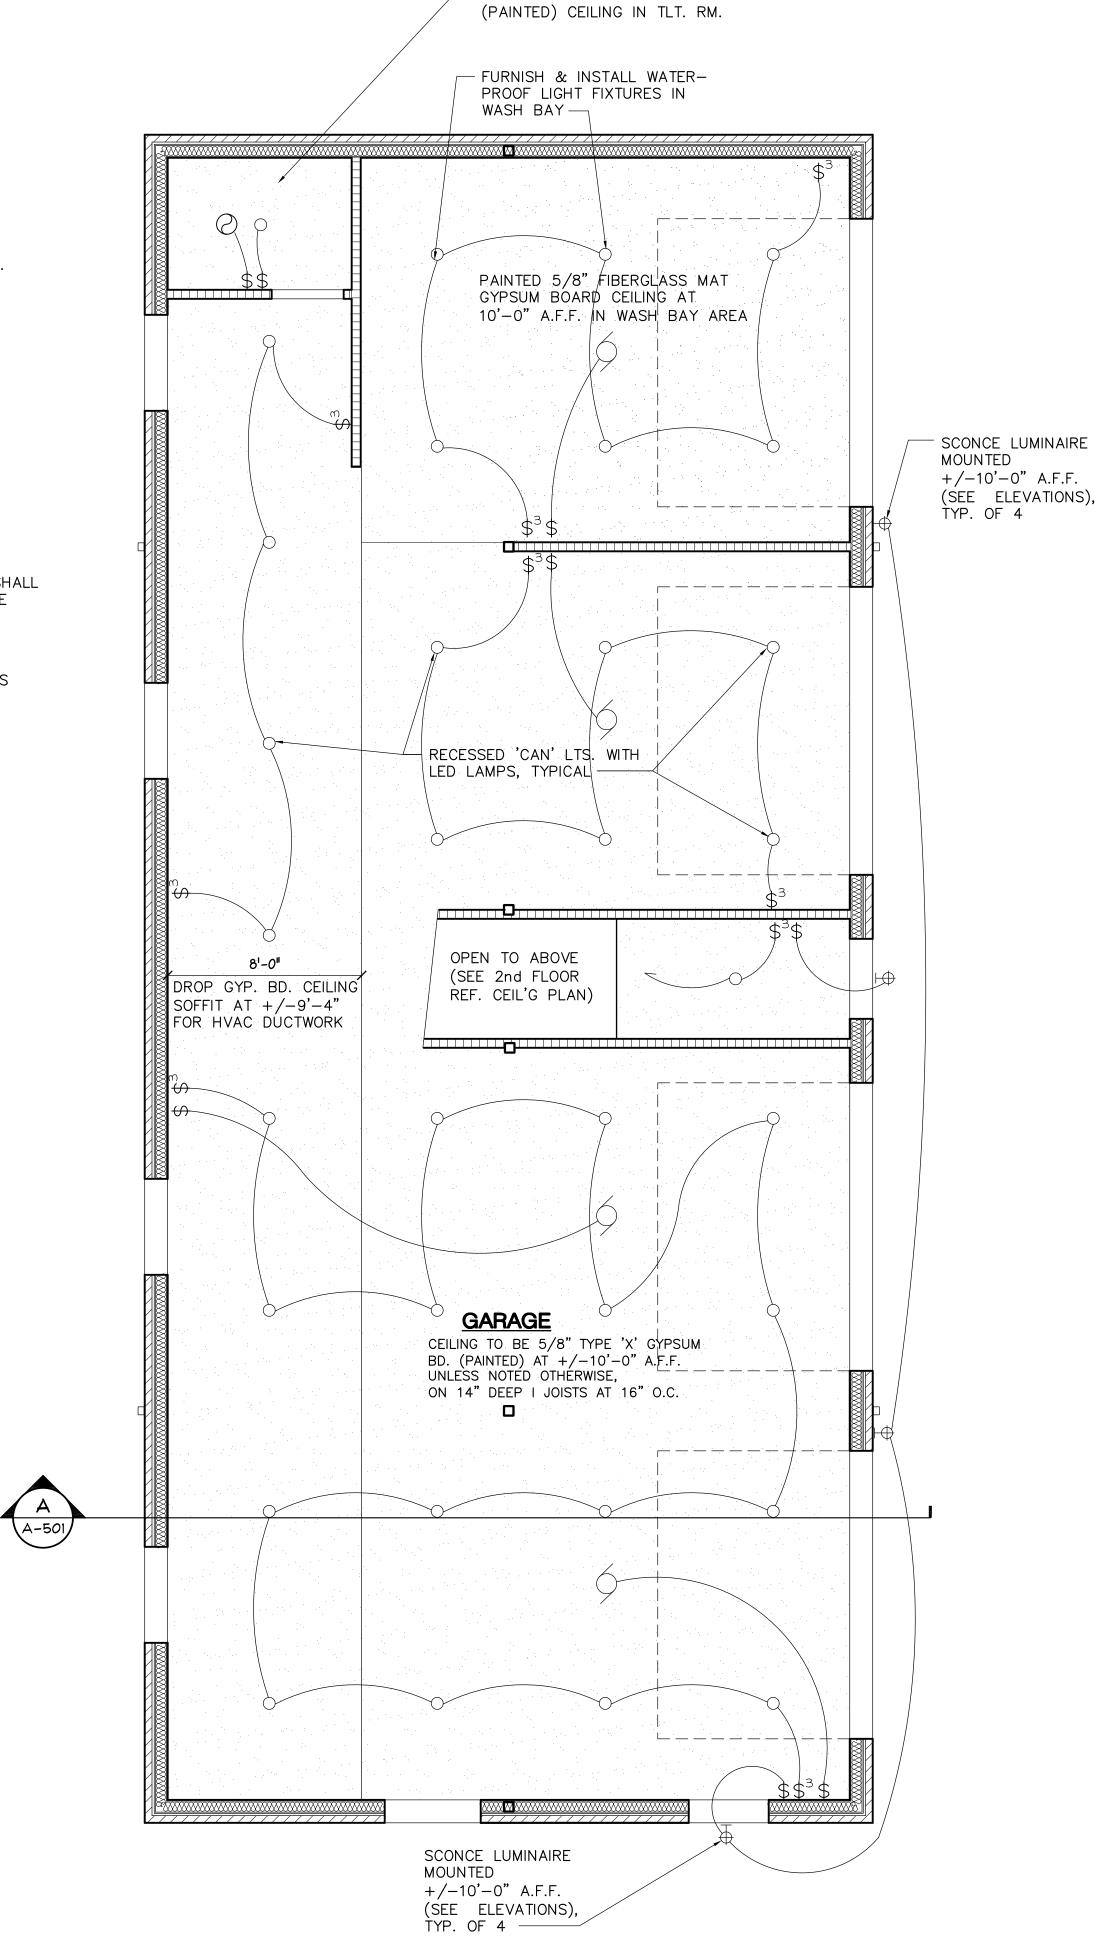

- 8'-0" A.F.F. GYP. BD.





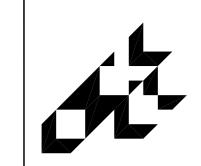

1+schurman associates, inc ects • planners • interior designers

architects = planners = interi

REFLECTED CEILING PONEW GARAGE/OFFICE BUILDING FOR:

ISSUE DATE

SCHEME May 19, 2023

REVISED May 23, 2023

REVISED June 20, 2023

REVISED July 18, 2023

PRELIM. Dec. 18, 2023

REVIEW Feb. 09, 2024


This document and the subject matter contained herein are proprietary and are not to be used or reproduced without written consent of Smith + Schurman Associates, inc.

DRAWN BY: JN

CHECKED BY:

JOB NO: 23-9271

SHEET NUMBER:
A-301

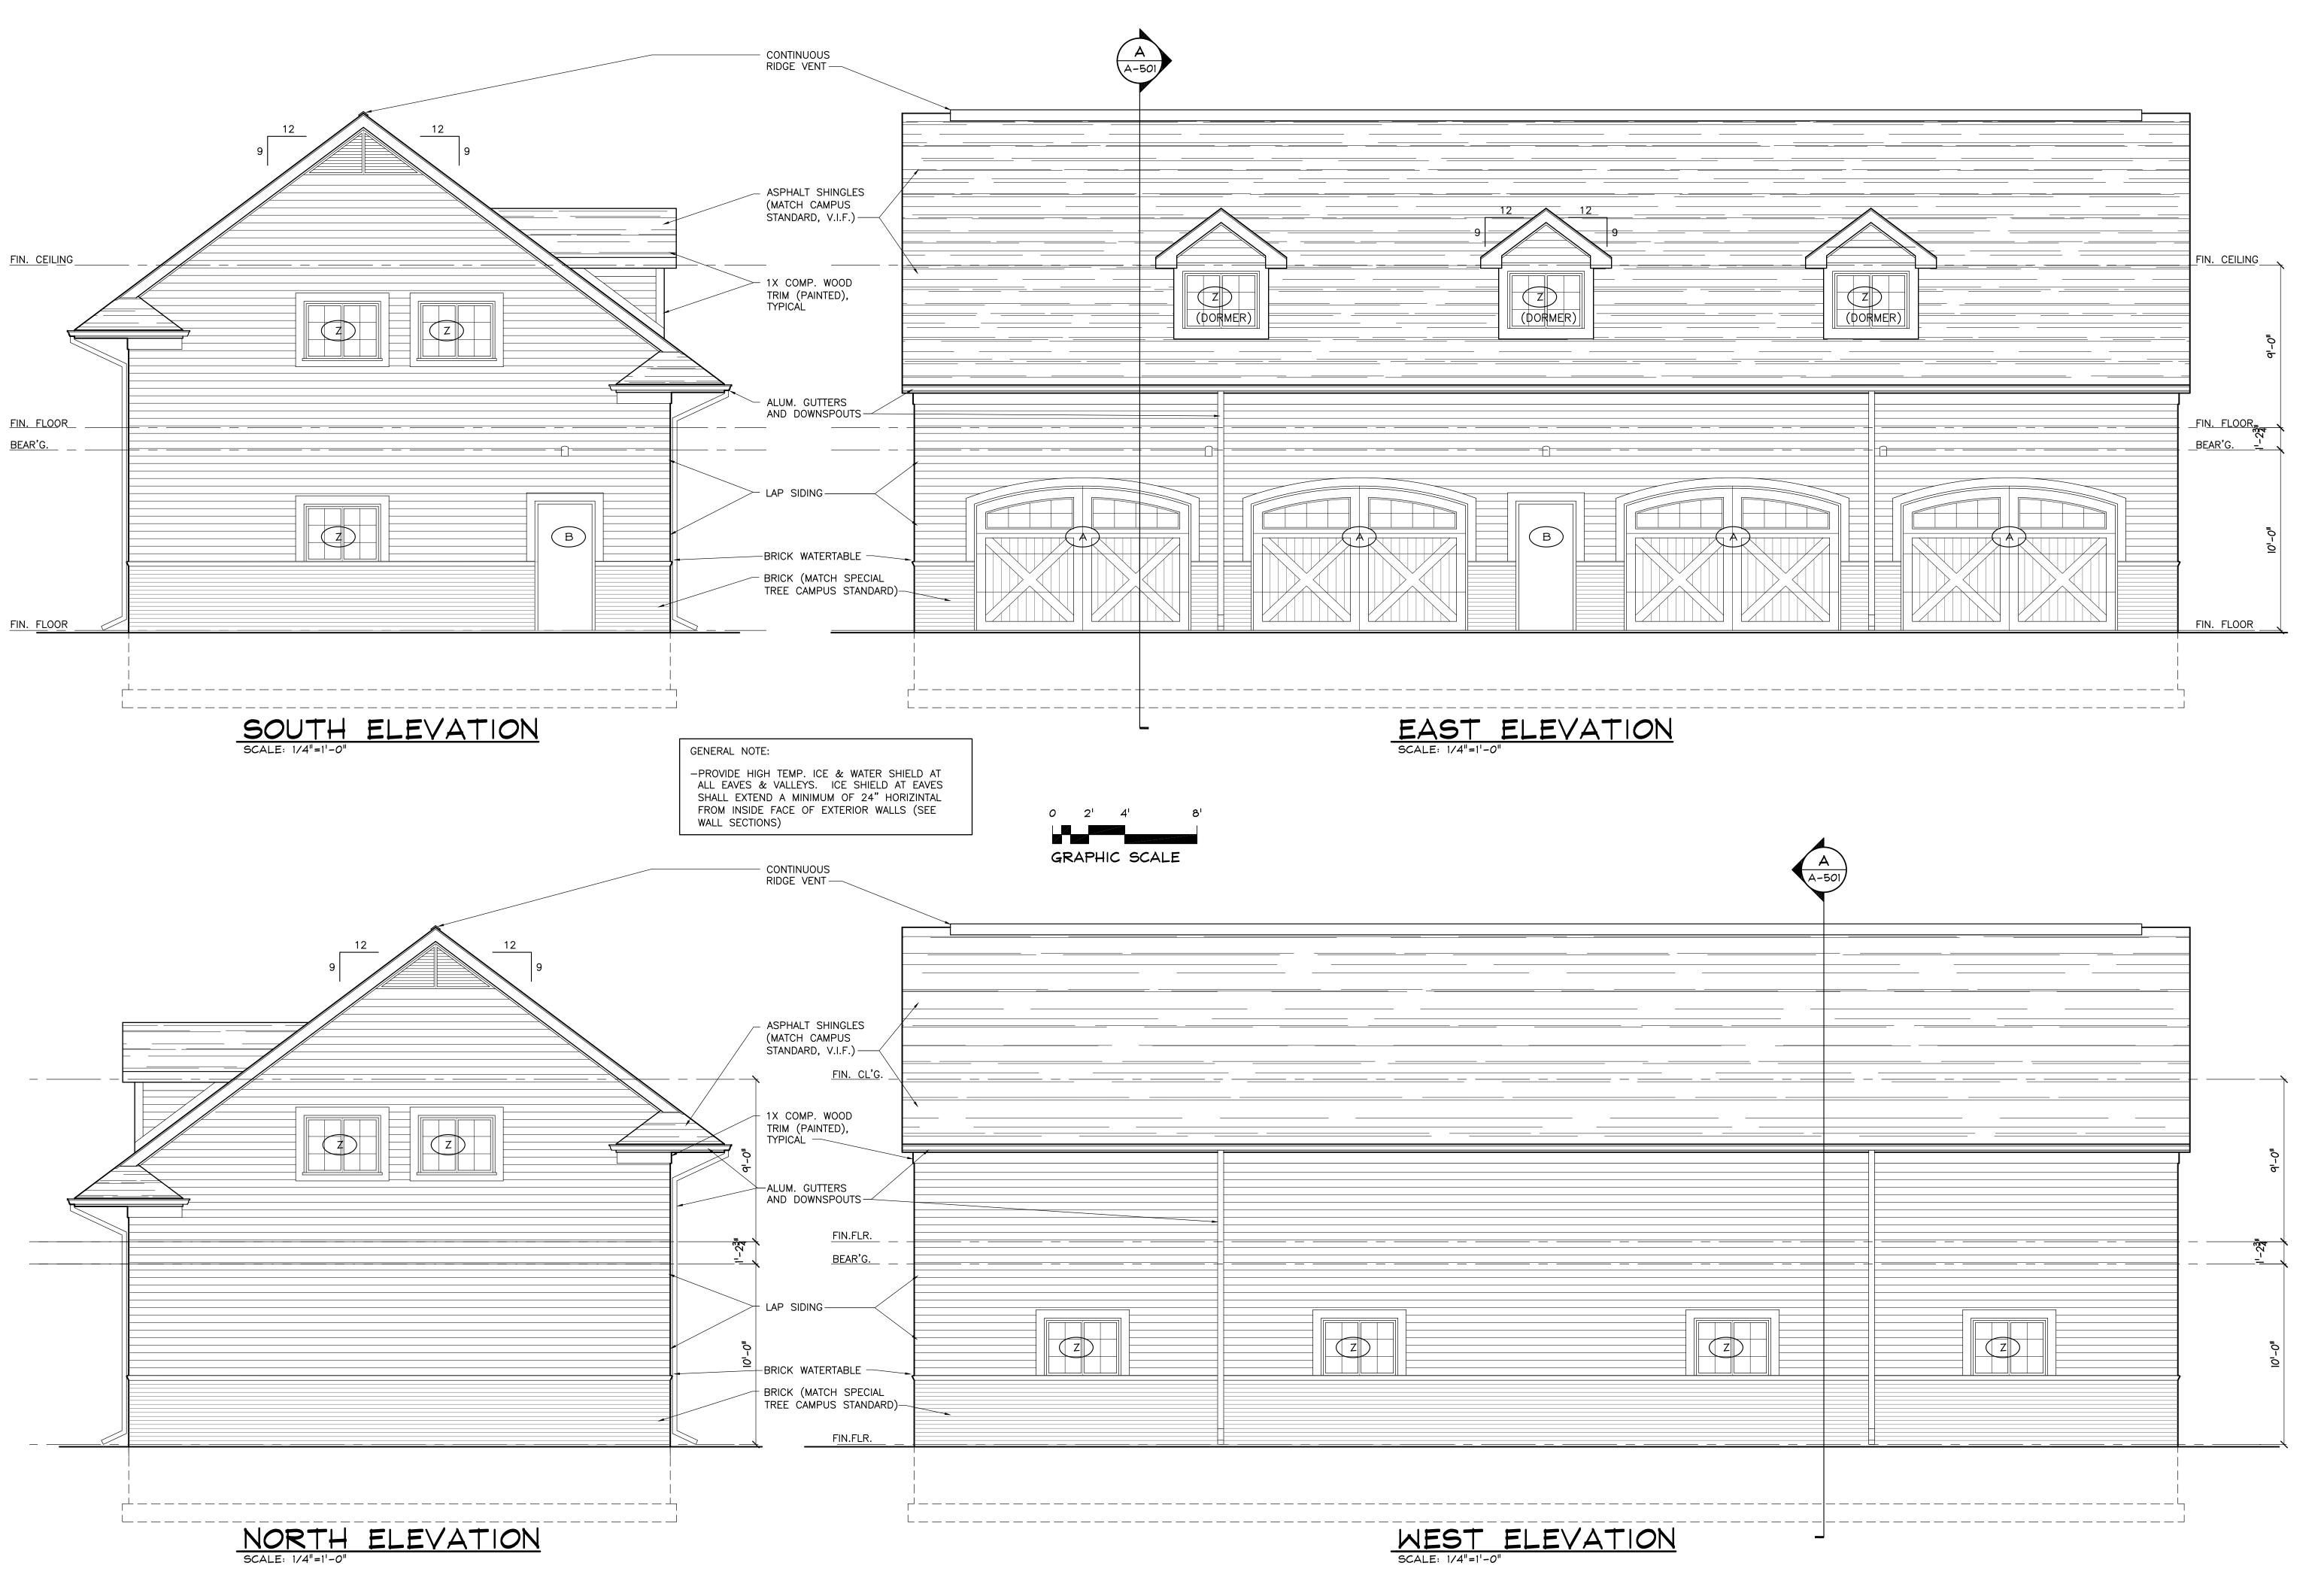

smith + schurman associates, architects • planners • interior designe

BUILDING ELEVATIONS
NEW GARAGE/OFFICE BUILDING FOR:

ISSUE DATE

SCHEME May 19, 2023

REVISED May 23, 2023

RENDER June 26, 2023

PRELIM. Dec. 18, 2023

REVIEW Feb. 09, 2024

REVISED Jan. 14, 2025


This document and the subject matter contained herein are proprietary and are not to be used or reproduced without written consent of Smith + Schurman Associates, inc.

DRAWN BY: JN

DRAWN BY: JN
CHECKED BY:

JOB NO: 23-9271

SHEET NUMBER:
A-401

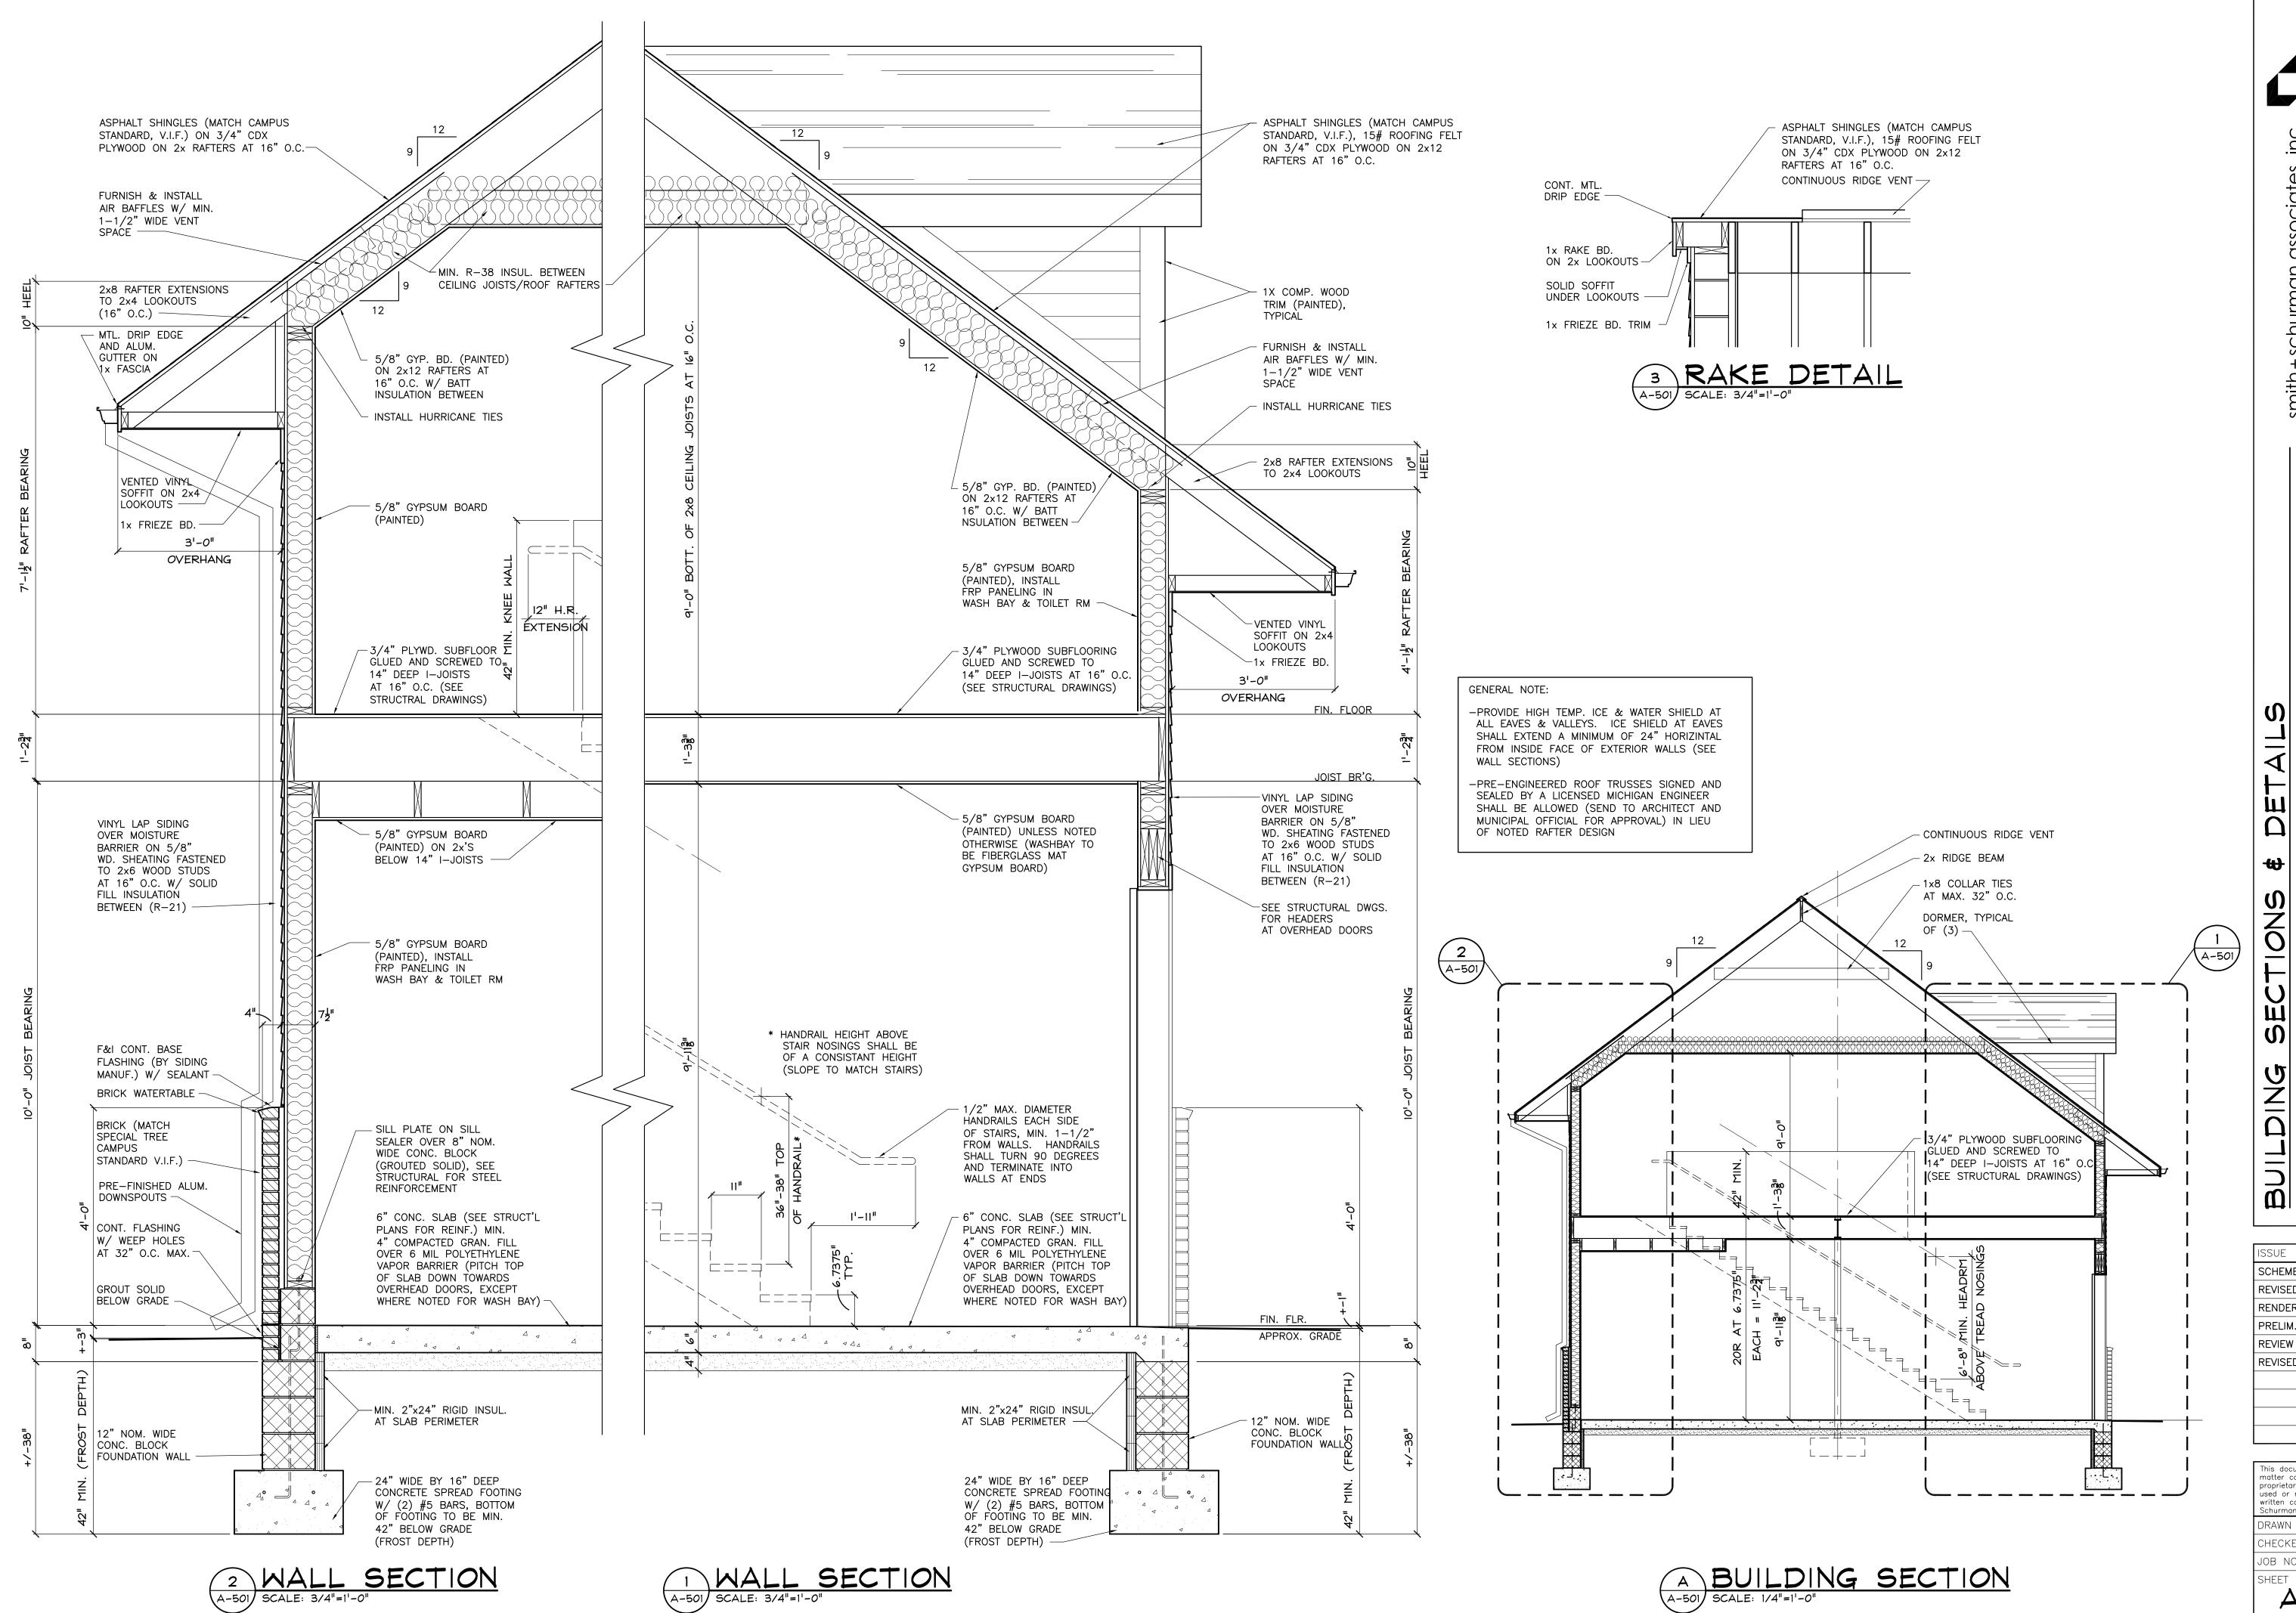

ciates, ⊇. ס + schurmar

SCHEME May 19, 2023 REVISED May 23, 2023 RENDER June 26, 2023 PRELIM. Dec. 18, 2023 REVIEW Feb. 09, 2024 REVISED Jan. 14, 2025

48174

This document and the subject roprietary and are not to b used or reproduced without written consent of Smith +

DRAWN BY: CHECKED BY:

23-9271 JOB NO: SHEET NUMBER: A-501